



DEPARTMENT OF THE ARMY  
US ARMY CORPS OF ENGINEERS  
NEW ENGLAND DISTRICT  
696 VIRGINIA ROAD  
CONCORD MA 01742-2751

November 23, 2015

Regulatory Division  
CENAE-R-PEC  
Permit Number: NAE-2015-01928

City of Portsmouth  
c/o Terry Desmarais  
680 Peverly Hill Road  
Portsmouth, New Hampshire 03801

Dear Applicant:

This is to inform you that we have reviewed your application to conduct activities as described on the attached NH State Permit 2015-01866, dated October 9, 2015.

Based on the information you provided to the New Hampshire Wetlands Bureau, we have determined that your project, which includes a discharge of dredged or fill material into waters or wetlands, will have only minimal individual or cumulative environmental impacts on waters of the United States, including wetlands. Therefore, this work is authorized under the attached Federal permit known as the New Hampshire Programmatic General Permit (PGP). This work must be performed in accordance with the terms and conditions of the PGP and the following special conditions:

**Special Condition 1:** As described in the attached New Hampshire Division of Historical Resources letter dated May 27, 2015 fencing and monitoring by an archaeologist will be conducted in Areas 5 and 6 to protect two identified middens and a probable remnant of the Fort Washington earthworks.

**Special Condition 2:** This authorization does not authorize the revetment work shown in the attached plans or referenced in the attached State Permit.

This authorization expires on August 3, 2017 unless the PGP is modified, suspended, or revoked before that. You must complete the work authorized herein by that date. If you do not, you must contact this office to determine the need for further authorization before continuing the activity. We recommend that you contact us *before* this authorization expires to discuss a time extension or reissuance of the authorization.

If you change the plans or construction methods for work within our jurisdiction, please contact us immediately to discuss modification of this authorization. This office must approve any changes before you undertake them.

This authorization presumes that the work as described above and as shown on your plans noted above is in waters of the U.S. Should you desire to appeal our jurisdiction, please submit a request for an approved jurisdictional determination in writing to this office.

This permit does not obviate the need to obtain other Federal, state or local authorizations required by law, including those listed in the PGP. Performing work not specifically authorized by this determination or failing to comply with all the terms and conditions of the PGP may subject you to the enforcement provisions of Corps regulations.

We continually strive to improve our customer service. In order for us to better serve you, we would appreciate your completing our Customer Service Survey located at [http://www.nae.usace.army.mil/reg/Customer\\_Service\\_Survey.pdf](http://www.nae.usace.army.mil/reg/Customer_Service_Survey.pdf).

If you have questions concerning this, please contact Richard Kristoff of my staff at (978) 318-8171, (978) 318-8335/8338, (800) 343-4789, or, if calling from within Massachusetts, (800) 362-4367.

Sincerely,

  
Frank J. DelGiudice  
Chief, Permits & Enforcement Branch  
Regulatory Division

Enclosures

Copies Furnished:

New Hampshire Department of Environmental Services, Wetlands Bureau, Attn: Mr. Collis Adams, P.O. Box 95, 29 Hazen Drive, Concord, New Hampshire 03302-0095

Jon Pearson, AECOM, 701 Edgewater Drive, Wakefield, Massachusetts 01880,  
[Jon.Pearson@aecom.com](mailto:Jon.Pearson@aecom.com)



The State of New Hampshire

# Department of Environmental Services

FILE COPY



Thomas S. Burack, Commissioner

## WETLANDS AND NON-SITE SPECIFIC PERMIT 2015-01866

**Permittee:** City of Portsmouth  
c/o Terry Desmarais  
680 Peverly Hill Rd.  
Portsmouth, NH 03801

**Project Location:** Peirce Island, Portsmouth  
Portsmouth Tax Map/Lot No. 208 / 1

**Waterbody:** Piscataqua River

**APPROVAL DATE:** 10/06/2015

**EXPIRATION DATE:** 10/06/2020

## NOTE -- CONDITIONS

Based upon review of the above referenced application, in accordance with RSA 482-A and RSA 485-A:17, a Wetlands Permit and Non-Site Specific Permit was issued. This permit shall not be considered valid unless signed as specified below.

**PERMIT DESCRIPTION:** Impact a total of 135,975 square feet of developed and undeveloped upland tidal buffer zone, including a total of 21,745 square feet in the undeveloped tidal buffer zone (13,210 s.f. temporary and 7,505 s.f permanent impacts); and a total of 114,230 square feet in the developed tidal buffer zone (87,220 sf. temporary and 27,010 permanent impacts) for construction to upgrade the existing Portsmouth Wastewater Treatment facility in accordance with EPA Consent Decree.

Approve as mitigation implementation of the "Invasive Species Management Plan" by Normandeau Associates dated August 18, 2015.


### **THIS APPROVAL IS SUBJECT TO THE FOLLOWING PROJECT SPECIFIC CONDITIONS:**

1. All work shall be in accordance with plans by AECom dated July 2015, as received by the NH Department of Environmental Services (DES) on 7/21/2015.
2. This permit is not valid unless an Alteration of Terrain permit or other method of compliance with RSA 485-A:17 and Env-Wq 1500 is achieved.
3. This permit is further contingent upon execution of approved mitigation "Invasive Species Management Plan" by Normandeau Associates dated August 18, 2015, with the following requirements:
  - a. The Plan shall be initiated concurrent with the project facility construction;
  - b. Initial report documenting the first season's activities shall be submitted no later than October 1;
  - c. A second report shall be submitted following the next season no later than October 1 of the second year;
  - d. A plan for long-term success and monitoring shall be submitted to DES at the end of the second year for review and approval.
4. Orange construction fence shall be installed around permitted impact areas to avoid activities expanding into unintended areas, and in further accordance with specific requirement relative to threatened species protection stated below.
5. Appropriate siltation and erosion controls shall be in place prior to construction, shall be maintained during construction, and shall remain until the area is stabilized. Temporary controls shall be removed once the area has been stabilized.
6. Relative to the protection of the state-threatened Marsh Elder populations the following conditions shall be adhered to:
  - a. No construction activity or equipment staging will occur outside of erosion control limits, approximately 40 feet from Marsh Elder populations;
  - b. Construction safety fencing shall be installed along either side of Peirce Island Road during the construction;
  - c. During the construction season (Dec. 1- Apr. 30) erosion control fencing will be installed around the seasonal construction trailer/staging area, located adjacent to the eastern end of Sub-population 1;
  - d. Before construction fencing is removed at the end of the construction season, and /or upon termination of the project, care should be taken to remove any sediments that have collected along the fence, so that they do not run off with storm water and impact the Marsh Elder.
7. Any further alteration of areas on this property that are subject to RSA 482-A jurisdiction will require a new application and further permitting.

8. All development activities associated with this project shall be conducted in compliance with applicable requirements of RSA 483-B and N.H. Code Admin. Rules Env-Wq 1400 during and after construction.
9. No person undertaking any activity shall cause or contribute to, or allow the activity to cause or contribute to, any violations of the surface water quality standards in RSA 485-A and Env-Wq 1700.
10. Erosion control products shall be installed per manufacturers recommended specifications.
11. The contractor responsible for completion of the work shall use techniques described in the New Hampshire Stormwater Manual, Volume 3, Erosion and Sediment Controls During Construction (December 2008).
12. No concrete is to be used anywhere in the construction of the stone riprap revetment. All stone shall be dry laid or placed stone underlain with filter fabric.
13. All temporary impacts shall be remediated back to natural contours and stabilized with native seed mix, as well as planted according to the approved landscape plan immediately upon completion of project construction use of the site.
14. A report documenting such restoration shall be submitted to DES within 30 days of the restoration activities being completed.
15. Construction equipment shall be inspected daily for leaking fuel, oil, and hydraulic fluid prior to entering surface waters or wetlands or operating in an area where such fluids could reach groundwater, surface waters, or wetlands.
16. The permittee's contractor shall maintain appropriate oil/diesel fuel spill kits on site that are readily accessible at all times during construction, and shall train each operator in the use of the kits.
17. All refueling of equipment shall occur outside of surface waters or wetlands during construction. Machinery shall be staged and refueled in upland areas only.
18. Faulty equipment shall be repaired immediately prior to entering areas that are subject to RSA 482-A jurisdiction.

**GENERAL CONDITIONS THAT APPLY TO ALL DES WETLANDS PERMITS:**

1. A copy of this permit shall be posted on site during construction in a prominent location visible to inspecting personnel;
2. This permit does not convey a property right, nor authorize any injury to property of others, nor invasion of rights of others;
3. The Wetlands Bureau shall be notified upon completion of work;
4. This permit does not relieve the applicant from the obligation to obtain other local, state or federal permits, and/or consult with other agencies as may be required (including US EPA, US Army Corps of Engineers, NH Department of Transportation, NH Division of Historical Resources (NH Department of Cultural Resources), NHDES-Alteration of Terrain, etc.);
5. Transfer of this permit to a new owner shall require notification to and approval by DES;
6. This project has been screened for potential impacts to known occurrences of rare species and exemplary natural communities in the immediate area. Since many areas have never been surveyed, or have received only cursory inventories, unidentified sensitive species or communities may be present. This permit does not absolve the permittee from due diligence in regard to state, local or federal laws regarding such communities or species.
7. Review enclosed sheet for status of the US Army Corps of Engineers' federal wetlands permit.

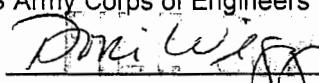APPROVED:   
Dori Wiggin, East Region Supervisor  
DES Wetlands Bureau


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**BY SIGNING BELOW I HEREBY CERTIFY THAT I HAVE FULLY READ THIS PERMIT AND AGREE TO ABIDE BY ALL PERMIT CONDITIONS.**

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OWNER'S SIGNATURE (required)


CONTRACTOR'S SIGNATURE (required)



Project No: 86753.08	Drawn By: vkh08	Date: 5/19/2015	<p>0 1,000 2,000 4,000</p> <p>S16 / 171</p>	<p>Fee</p> <p>CITY OF PORTSMOUTH PORTSMOUTH, NEW HAMPSHIRE PEIRCE ISLAND WASTEWATER TREATMENT FACILITY</p> <p>EXHIBIT A - REVETMENT LOCATIONS</p> <p>SCALE: 1:24,000</p> <p>NORMANDEAU environmental consultants 25 Nashua Road Bedford NH 03110 (603) 472-5191 www.normandeau.com</p> <p>JUNE 2015</p>
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NHDES WETLAND PERMIT  
CITY OF PORTSMOUTH, NEW HAMPSHIRE

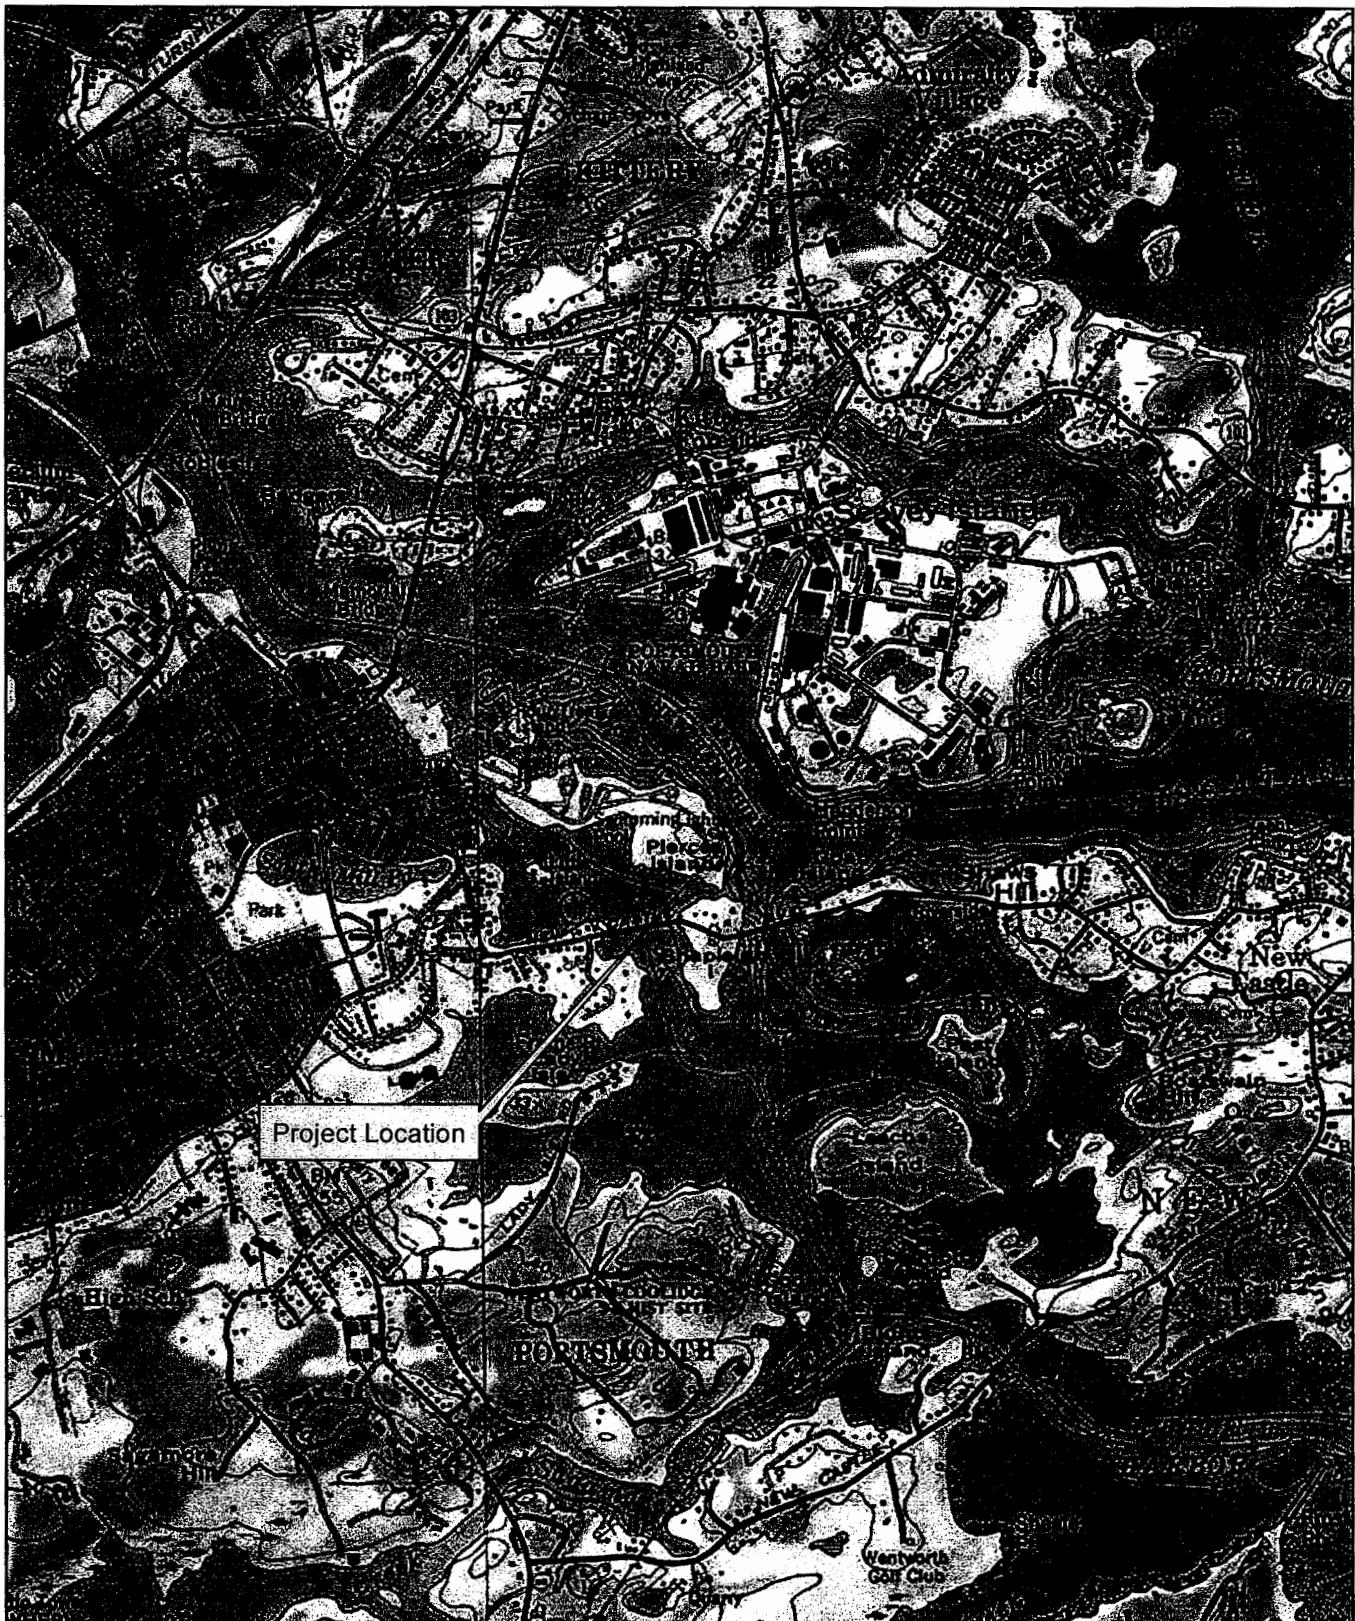PEIRCE ISLAND  
WASTEWATER TREATMENT FACILITY UPGRADE  
JULY 2015

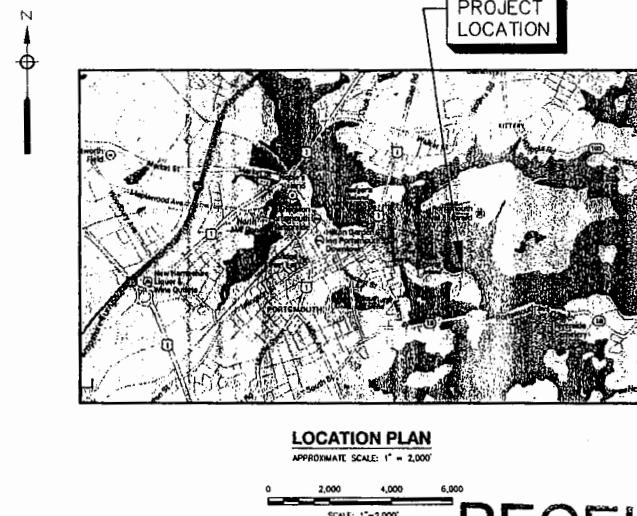

INDEX OF SHEETS


- 00 G-001 PERMIT COVER SHEET, LOCATION PLAN AND INDEX OF SHEETS
- 00 C-101 PERMIT LEGEND, ABBREVIATIONS AND GENERAL NOTES
- 00 C-102 PERMIT EXISTING CONDITIONS AND EROSION CONTROL PLAN I
- 00 C-103 PERMIT EXISTING CONDITIONS AND EROSION CONTROL PLAN II
- 00 C-104 PERMIT DEMOLITION PLAN I
- 00 C-105 PERMIT DEMOLITION PLAN II
- 00 C-106 PERMIT DEMOLITION PLAN III
- 00 C-107 PERMIT SITE LAYOUT, PAVING, GRADING AND DRAINAGE PLAN I
- 00 C-108 PERMIT SITE LAYOUT, PAVING, GRADING AND DRAINAGE PLAN II
- 00 C-109 PERMIT SITE LAYOUT, PAVING, GRADING AND DRAINAGE PLAN III
- 00 C-110 PERMIT SITE LAYOUT, PAVING, GRADING AND DRAINAGE PLAN IV
- 00 C-111 PERMIT LANDSCAPE PLAN I
- 00 C-112 PERMIT LANDSCAPE PLAN II
- 00 C-113 PERMIT LANDSCAPE PLAN III
- 00 C-114 PERMIT WETLAND IMPACT PLAN KEY PLAN
- 00 C-115 PERMIT WETLAND IMPACT PLAN I
- 00 C-116 PERMIT WETLAND IMPACT PLAN II
- 00 C-117 PERMIT WETLAND IMPACT PLAN III
- 00 C-118 PERMIT ENLARGED PLANS AND SECTIONS AT REVETMENT AREAS I
- 00 C-119 PERMIT ENLARGED PLAN AND SECTION AT REVETMENT AREAS II
- 00 C-120 PERMIT DETAILS I
- 00 C-121 PERMIT DETAILS II
- 00 C-122 PERMIT DETAILS III
- 00 C-123 PERMIT DETAILS IV
- 00 C-124 PERMIT DETAILS V
- 00 C-125 PERMIT DETAILS VI
- 00 C-126 PERMIT DETAILS VII
- 00 C-127 PERMIT DETAILS VIII

NOTE:

WETLANDS WERE DELINEATED BY NORMANDEAU ASSOCIATES, INC. ON JUNE 3, 2013. THE WETLAND DELINEATIONS WERE COMPLETED IN ACCORDANCE WITH THE CRITERIA DESCRIBED IN THE U.S. ARMY CORPS OF ENGINEERS WETLAND DELINEATION MANUAL TECHNICAL REPORT Y-87-1 (JANUARY, 1987) AND THE REGIONAL SUPPLEMENT FOR THE NORTHCENTRAL AND NORTHEAST REGION (JANUARY, 2012) AND MEET THE CRITERIA FOR WETLAND DOCUMENTATION IN ACCORDANCE WITH THE NH DES ADMINISTRATIVE RULES ENV-WT 301.01 AND ENV-WT 101.48.

PERMIT APPLICATION DRAWING NOT FOR CONSTRUCTION		DESCRIPTION
STAMP NO.:	DATE ISSUED:	REVISIONS
SPCL. IC:	PERMIT NO.:	
NAME:	EXPIRATION DATE:	
COMPANY:	ISSUED BY:	
ADDRESS:	PERMITTING AUTHORITY:	
PHONE:	TELEPHONE:	
FAX:	E-MAIL:	
AECOM		
NORMANDEAU ASSOCIATES, INC.		
ATTUS		
PEIRCE ISLAND WASTE UPGRAGE		COVER SHEET, LOCATION PLAN AND INDEX OF SHEETS
GIVEN THIS DAY OF MONTH YEAR		
PROJECT NO: 00301525 CAD DWG FILE: 00-G-001 - DESIGNED BY: T. BISHOP DRAWN BY: C. BOODER DEPT CHECK: C. BOODER PROJ CHECK: E. MURRAY DATE: JULY 2015 SCALE: AS NOTED		
00 G-001 PERMIT		

CITY OF PORTSMOUTH, NH - DEPARTMENT OF PUBLIC WORKS  
 PEIRCE ISLAND WWTF UPGRADE  
 LEGEND, ABBREVIATIONS  
 AND GENERAL NOTES  
 PERMITTING

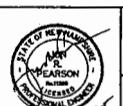


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 NOT FOR CONSTRUCTION

DATE MADE BY CHECKED

DESCRIPTION

RÉVISIONS

**LEGEND**

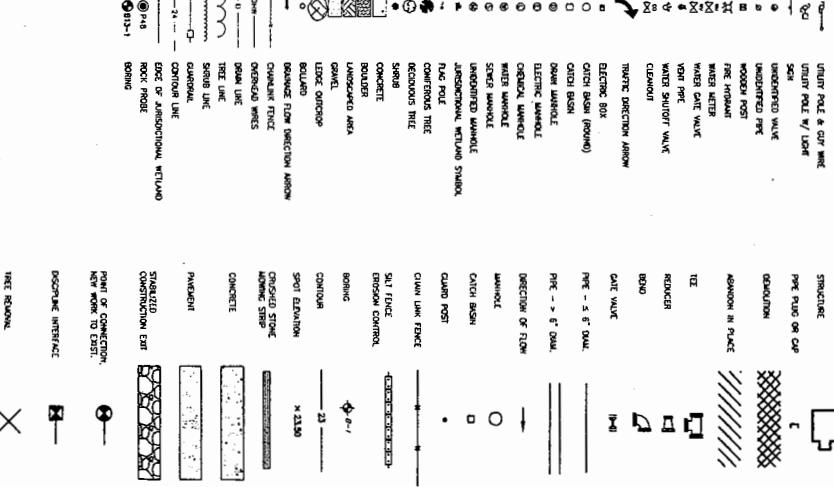

**EXISTING**

**PROPOSED**

**GENERAL NOTES**

- HORIZONTAL LOCATIONS SHOWN ARE REFERENCED TO THE NH STATE PLANE COORDINATE SYSTEM (NAD).
- VERTICAL DATA IS MADE AND IS BASED ON NATIONAL GRID SURVEY POINT CLASS 1000 PRECISELY LOCATED WITH A PUBLISHED ELEVATION OF 2014.
- TOPOGRAPHIC INFORMATION SHOWN IS THE RESULT OF A SURVEY MADE IN JULY 2013 BY SOURCE SURVEY, INC., FOR NEW PLACE INNOVATIONS LTD. AND MERRILL CONSTRUCTION LTD. (MCC). MCC ON JULY 3, 2013, ISSUED THE SURVEY AND MADE ON MERRILL IN, LTD. BY SOURCE SURVEY, INC. ON JULY 3, 2013, ISSUED THE SURVEY AND MADE ON MERRILL IN, LTD. BY SOURCE SURVEY, INC.
- PRECISE SURVEY DATA IS APPROPRIATE FOR USE IN THE ACCURACY OF COMPUTATIONS OF UNDERRADING TUNNELS WHICH PRIOR TO ANY EXCAVATION ON SITE, THE CONTRACTOR SHALL NOTIFY THE OWNER.
- THE CONTRACTOR SHALL EFFECT STRONG SIGHT CHECKS PRIOR TO COMMENCING ANY CLEARING, EXCAVATION OR STORAGE OF MATERIAL, MATERIAL, TELL, AND GROUND SHALL BE RETURNED TO THE ORIGINAL GRAZE UNLESS SHOWN ON THE DRAWINGS.
- ALL LABOR DURATIONS REFER TO OUTSIDE EDGE OF WALL AT GRADE LINE, UNLESS OTHERWISE INDICATED.
- UNPAVED AREAS DESIGNATED BY THE CONTRACTOR SHALL BE CLARDED AND GRUBBED IF REQUIRED AND RESTORED WITH LOAM AND SEED.
- SAFETY OR EGRESS ASSUMPTIONS & BASED ON MAP AS DRAFTED. EXISTING PLATE NUMBERINGS ARE BASED ON ROD TO ROD TO CONVERT MAP TO 2014 % AND 0.17 FEET TO COMMON ROAD LEVELS TO MAP AS SUBSTRACT 0.77 FEET.
- ALL SPANNING, HEAVY WALLS, GUARD RAIS, GUARD RAIS, SUPPORTS, SCAFFOLDS, SHEARERS AND ANY OTHER EQUIPMENT IS THE PROPERTY OF THE CONTRACTOR. A FEE FOR EQUIPMENT RENTAL COST TO THE OWNER.
- ALL AREAS OF EXCAVATION, BACKFILL, TELL, AND GROUND SHALL BE RETURNED TO THE ORIGINAL GRAZE UNLESS SHOWN ON THE DRAWINGS.
- ALL UTILITY BOLES, FRAMES, GATES, ETC. DESTROYED BY CONTRACTOR AND NOT TO BE ABANDONED SHALL BE RELOCATED TO THE OWNER'S GRAZE AT NO ADDITIONAL COST TO THE OWNER.
- REFLECTOR STAKES ARE USED TO MARK THE EXTERIOR WALLS AND CENTER OF LINES.
- ALL SPANNING, HEAVY WALLS, GUARD RAIS, GUARD RAIS, SUPPORTS, SCAFFOLDS, SHEARERS AND ANY OTHER EQUIPMENT IS THE PROPERTY OF THE CONTRACTOR. A FEE FOR EQUIPMENT RENTAL COST TO THE OWNER.
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**VERTICAL DATUM CONVERSION NOTE:**

MAPS OR ELEVATION ARE BASED ON NAD 83, AND 0.17 FEET TO COMMON ROAD LEVELS

TO MAP AS SUBSTRACT 0.77 FEET.

ALL SPANNING, HEAVY WALLS, GUARD RAIS, GUARD RAIS, SUPPORTS, SCAFFOLDS, SHEARERS AND ANY OTHER EQUIPMENT IS THE PROPERTY OF THE CONTRACTOR. A FEE FOR EQUIPMENT RENTAL COST TO THE OWNER.

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AND D - 22-Jun-15

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C

D


X



RIGHT TURN

LEFT TURN

**PERMIT APPLICATION DRAWING  
NOT FOR CONSTRUCTION**

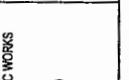

EXISTING CONDITIONS AND  
EROSION CONTROL PLAN I

CITY OF PORTSMOUTH, NH - DEPARTMENT OF PUBLIC WORKS

PEIRCE ISLAND WASTE UPGRADE

PERMITTING

PROJECT NO. 03031525

CAD CDR FILE: 03-C-102.DWG

DESIGNED BY: T. WASSELL

DRAWN BY: C. BERZINS


DEP CHECK: C. BERZINS

PROV CHECK: E. MESSINEO

DATE: JULY 2015

SCALE: AS NOTED

00 C-102 PERMIT

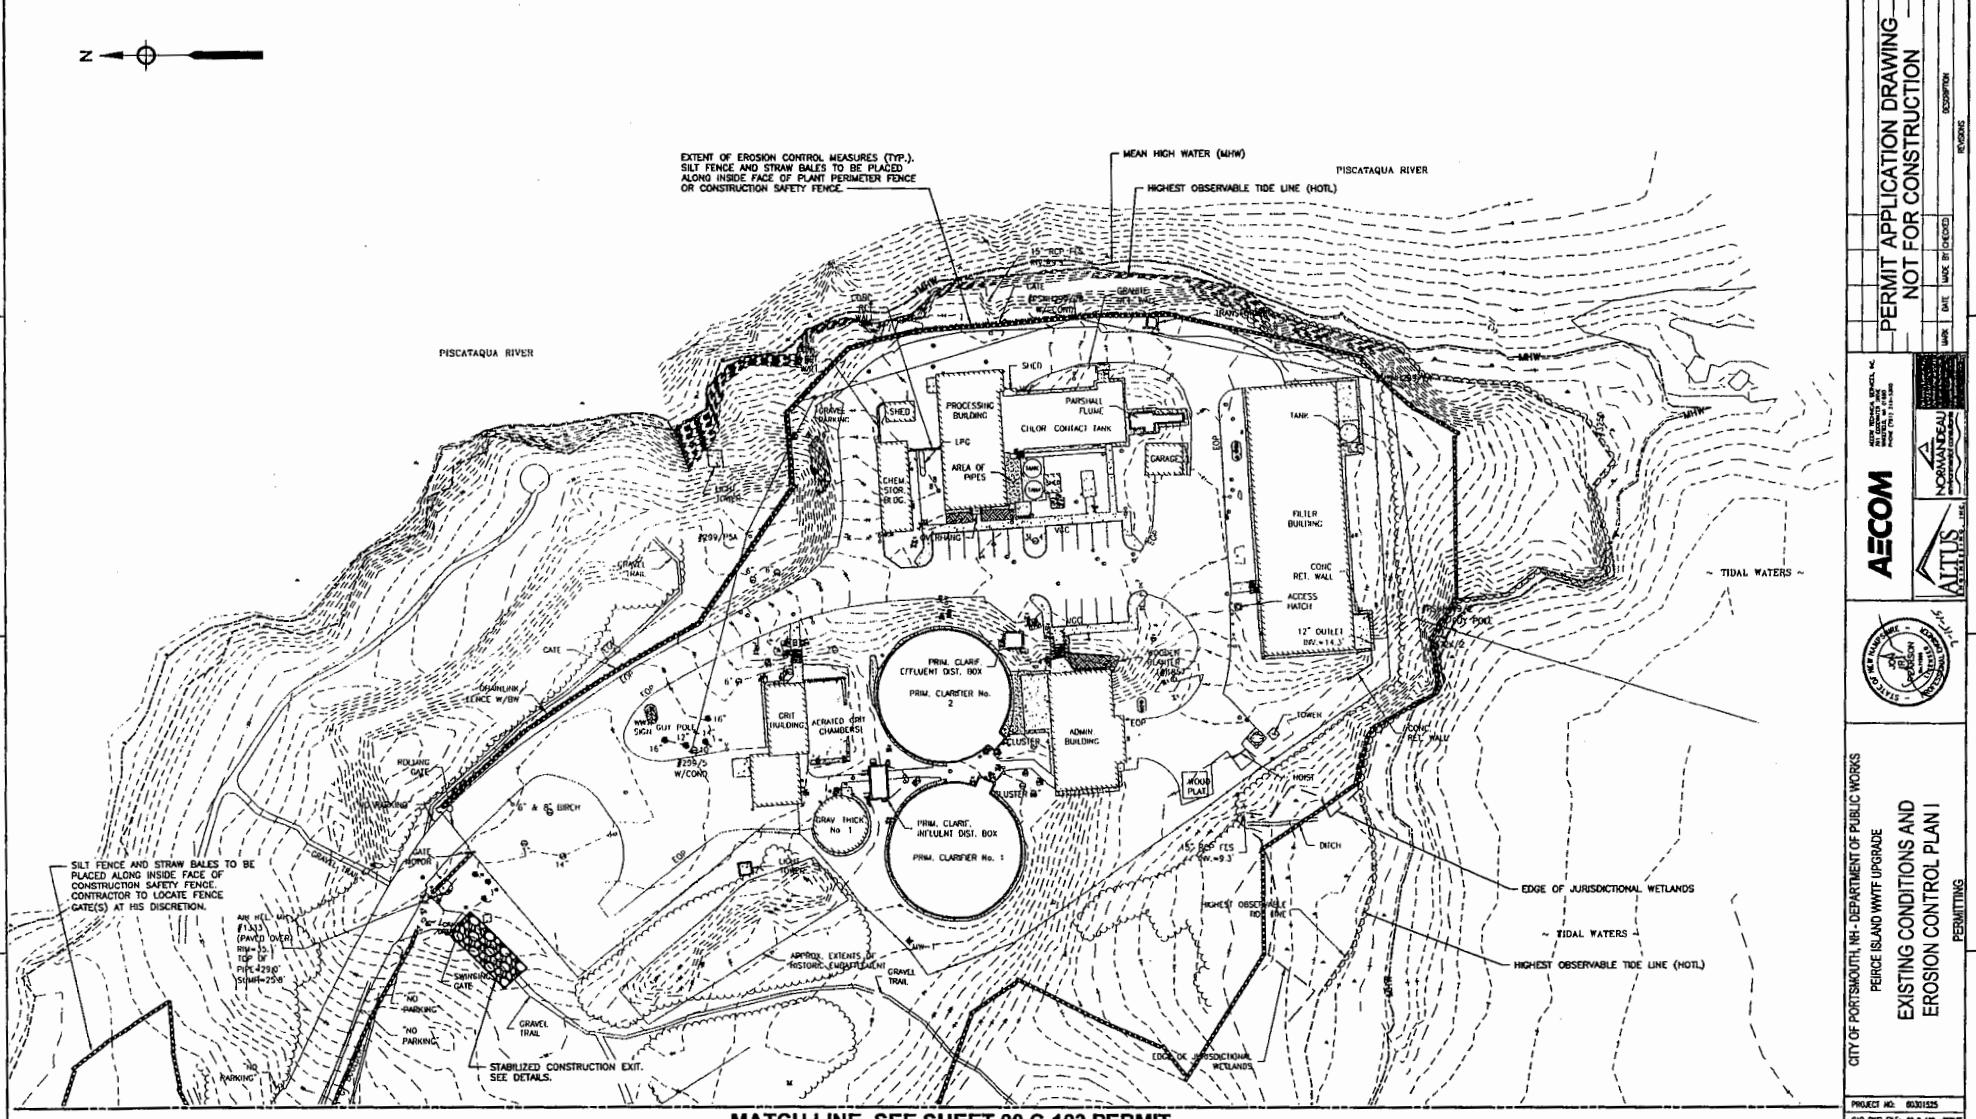


**MATCH LINE, SEE SHEET 00 C-103 PERMIT**

**PLAN**

SCALE: 1"-40'

0 40 80 120  
FEET  
SCALE



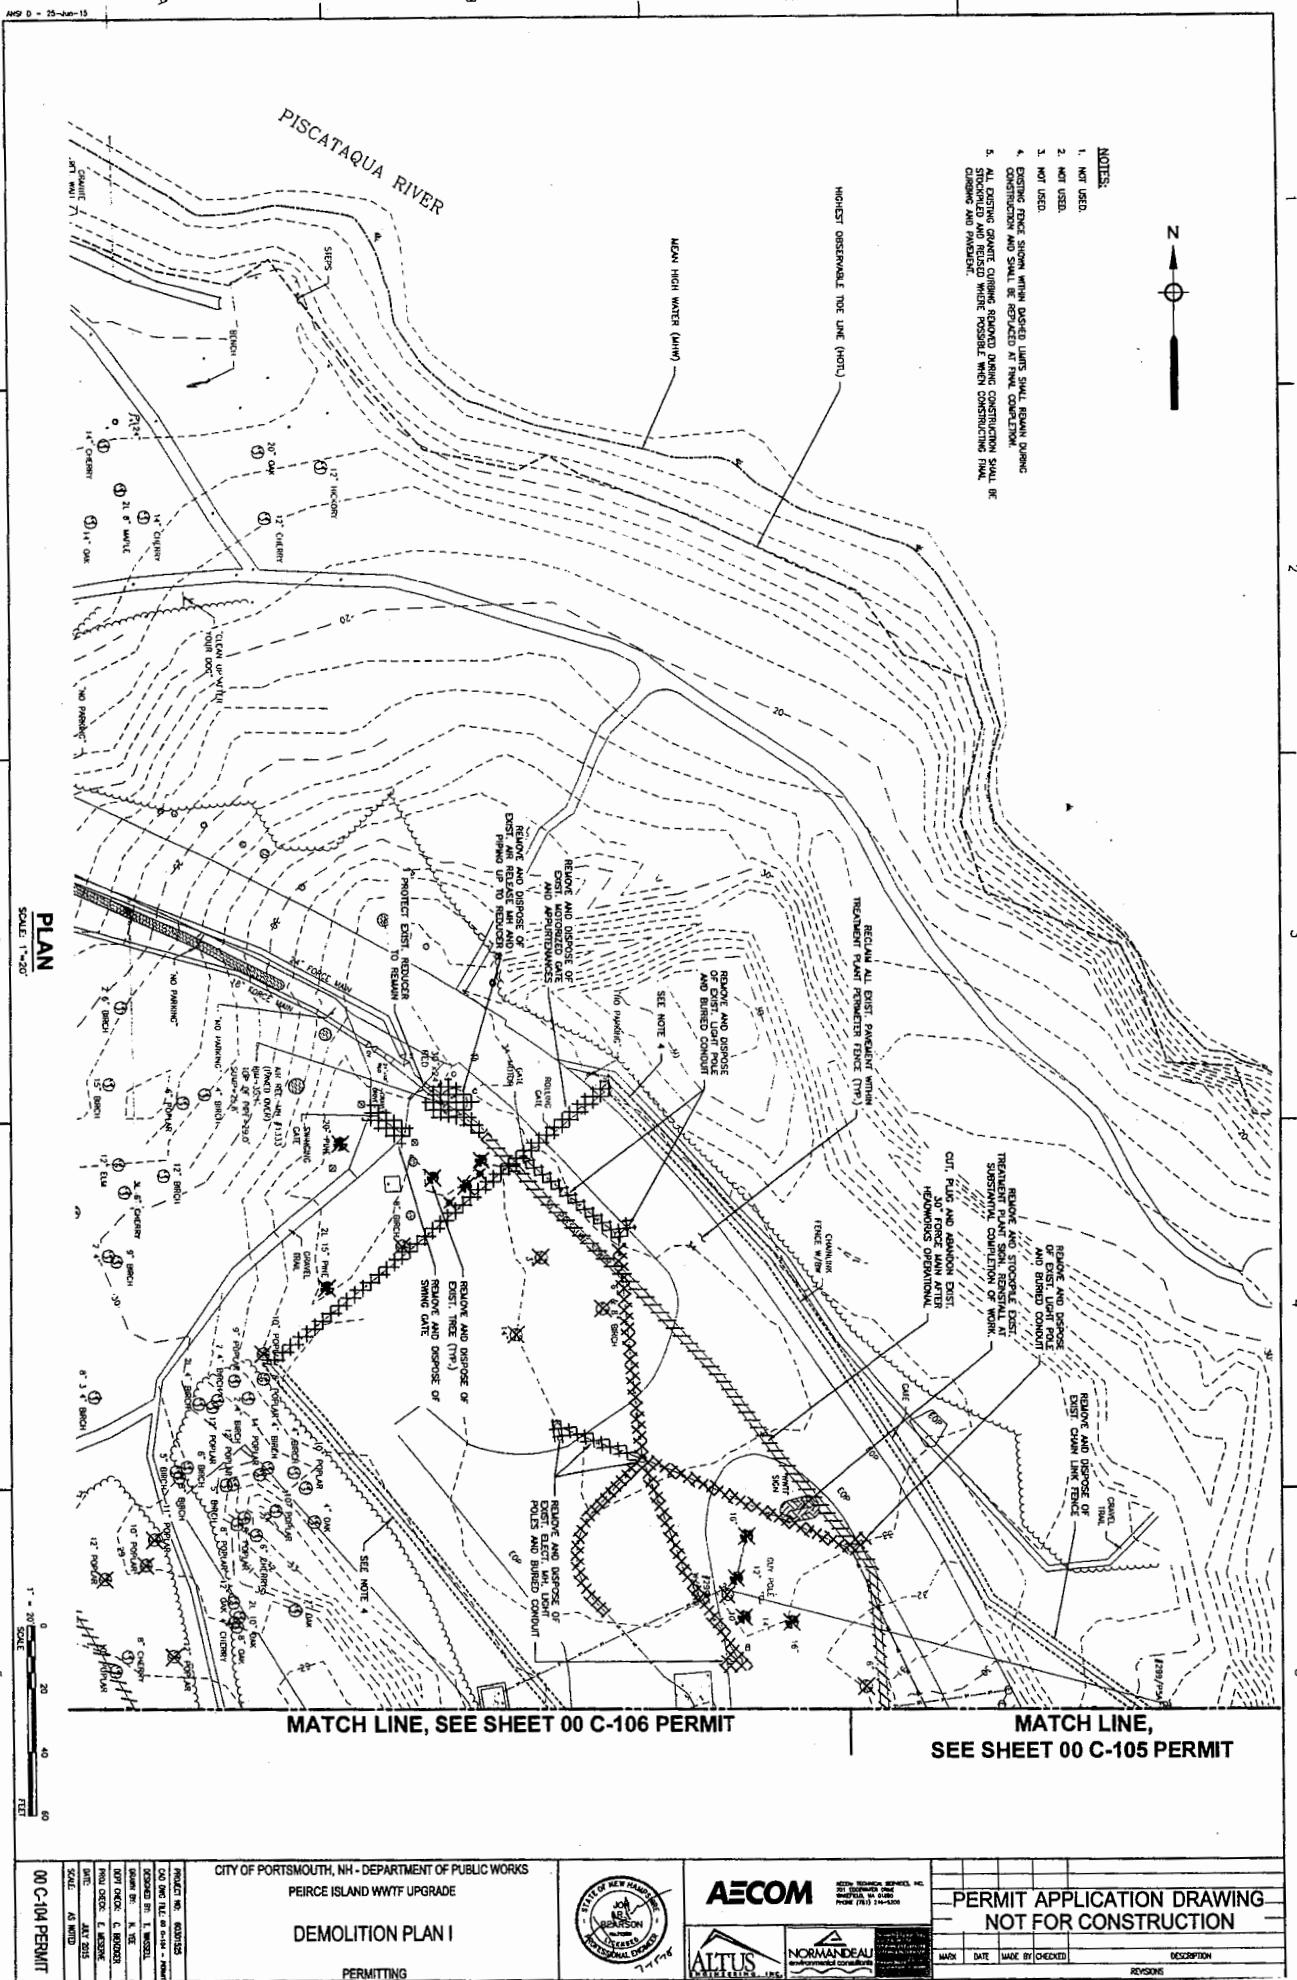

PERMIT APPLICATION DRAWING  
NOT FOR CONSTRUCTION

DEPARTMENT OF  
WATER AND SEWER  
SERVICES


AECOM  
NORMANDEAU  
ALTAUS



CITY OF PORTSMOUTH, NH - DEPARTMENT OF PUBLIC WORKS  
PEIRCE ISLAND WWTF UPGRADE  
SITE LAYOUT, PAVING, GRADING  
AND DRAINAGE PLAN III

PERMITTING

MATCH LINE, SEE SHEET 00 C-108 PERMIT

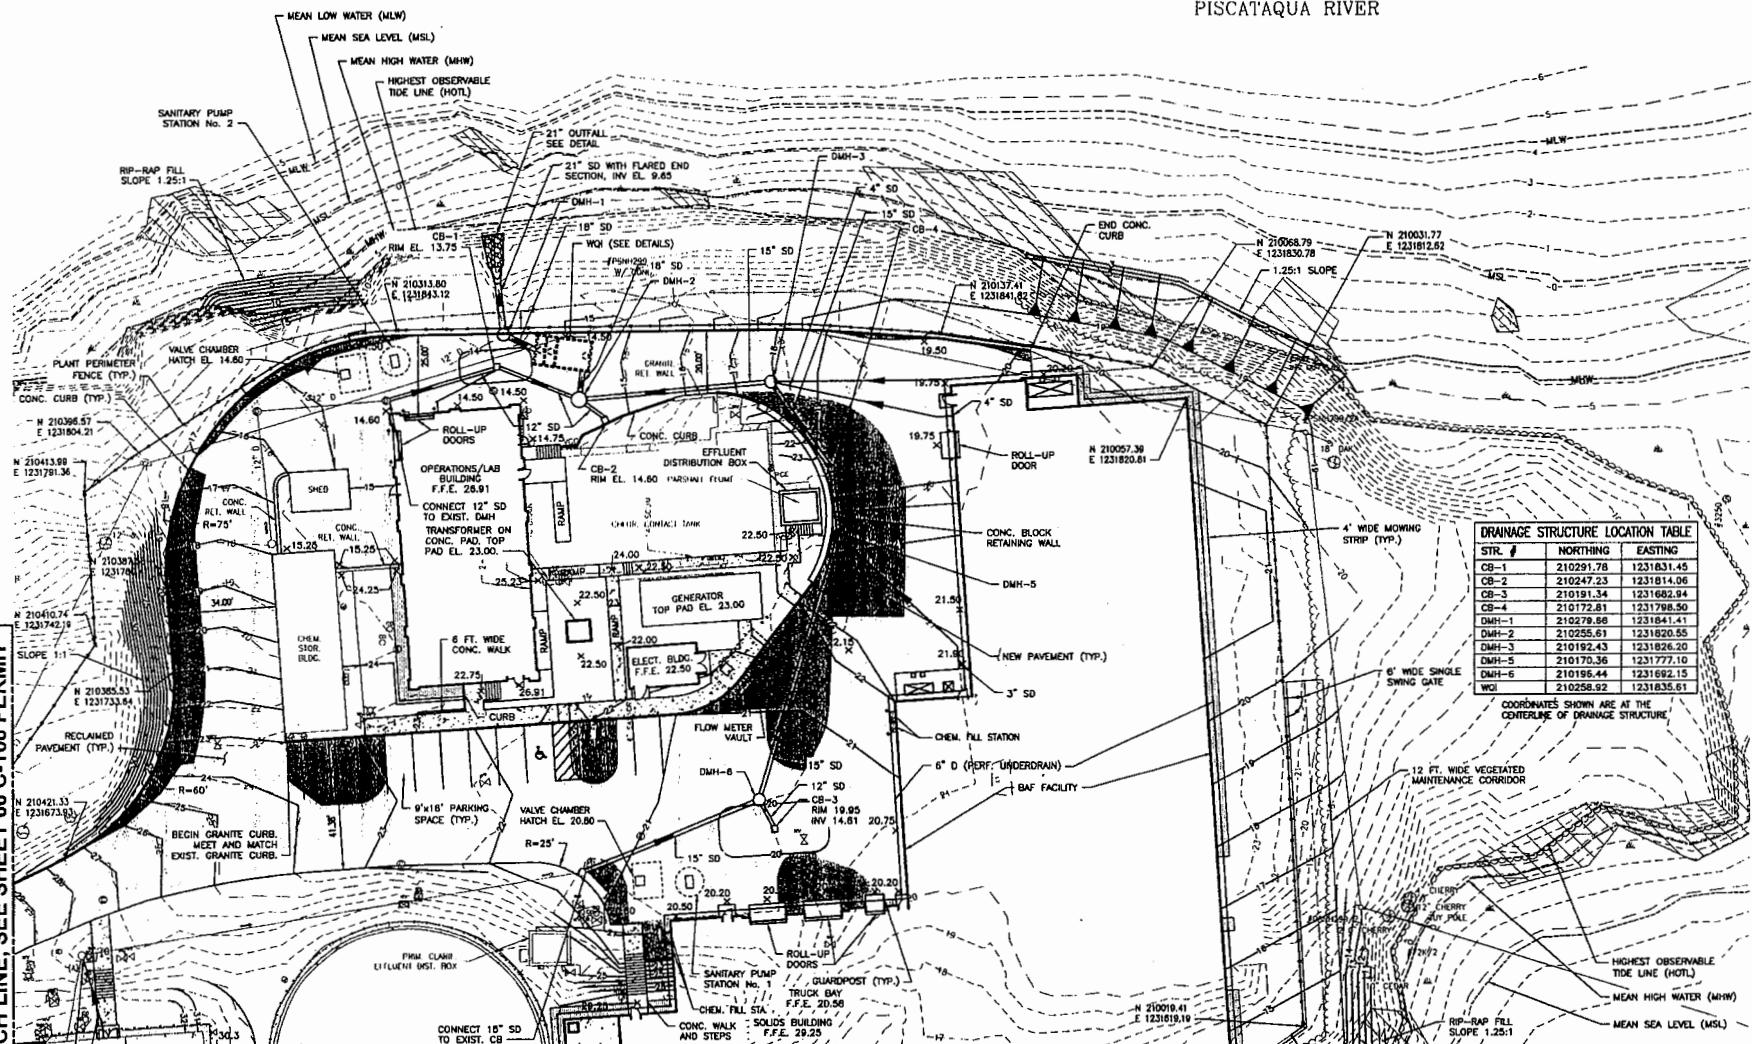


MATCH LINE, SEE SHEET 00 C-110 PERMIT

PLAN  
SCALE: 1"-20'

0 20 40 60  
FEET  
SCALE


PROJECT NO: 00001525  
CAD DNG FILE: 00-6-18 - Power  
DESIGNED BY: T. WASSELL  
DRAWN BY: N. YEE  
DEPT CHECK: C. BENZIGER  
PROJ CHECK: E. WESTRUP  
DATE: JULY 2015  
SCALE: AS NOTED

00 C-109 PERMIT

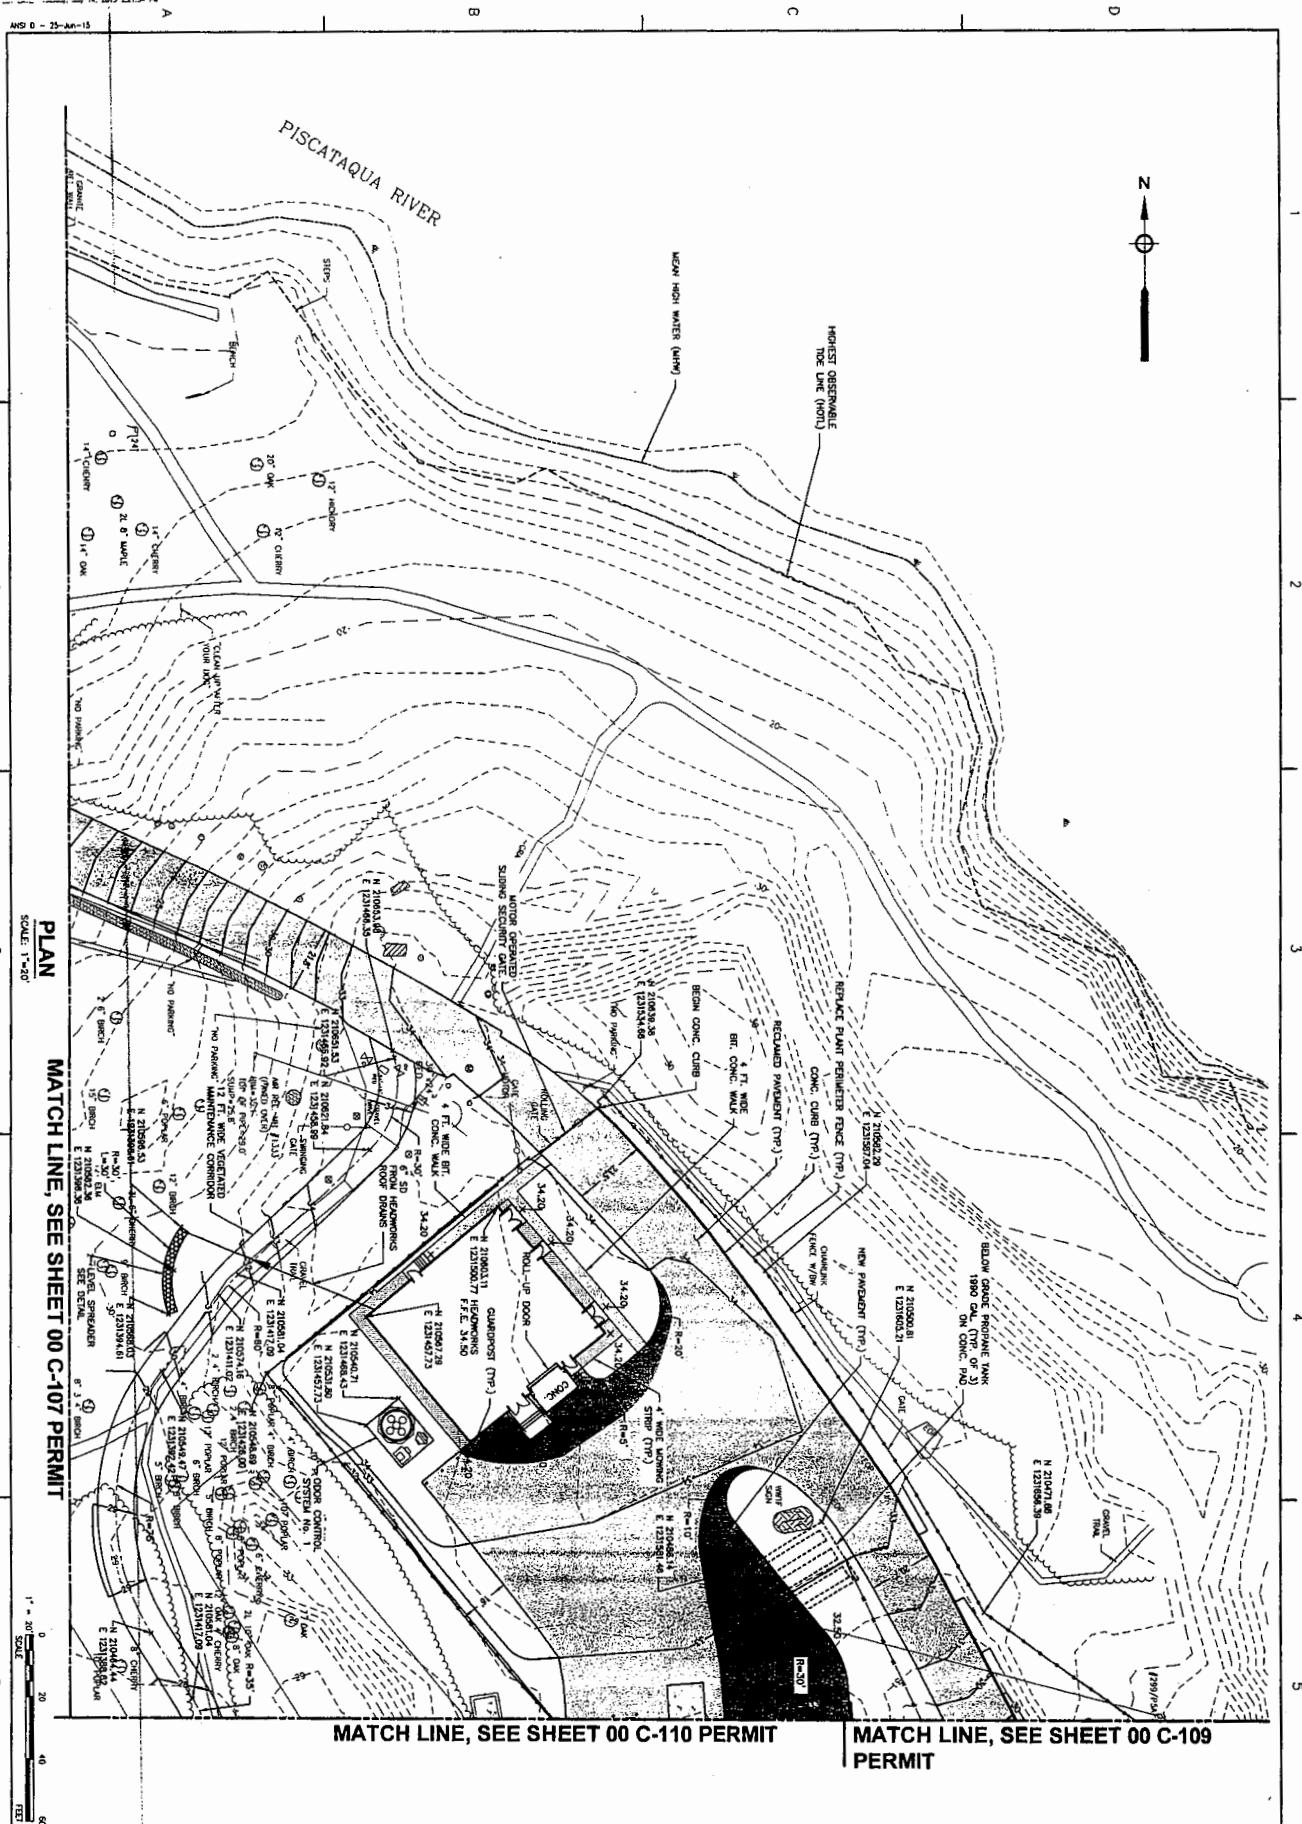

PROJECT NO. #00108	DO ONE FILE AS A SET - FORM APPROVED BY: [Signature]	STATE OF NEW HAMPSHIRE JOHN R. BEARSON DEPARTMENT OF ENVIRONMENT PHONE: (603) 224-1200	AECOM	PERMIT APPLICATION DRAWING NOT FOR CONSTRUCTION		
PEIRCE ISLAND WWTF UPGRADE SITE LAYOUT, PAVING, GRADING AND DRAINAGE PLAN II PERMITTING		NORMANDEAU ENVIRONMENTAL CONSULTANTS INC.	MARK DATE MADE BY CHECKED	DESCRIPTION		
00 C-108 PERMIT	100 C-109 PERMIT	100 C-109 PERMIT	100 C-109 PERMIT	100 C-109 PERMIT	100 C-109 PERMIT	

MATCH LINE, SEE SHEET 00 C-104 PERMIT

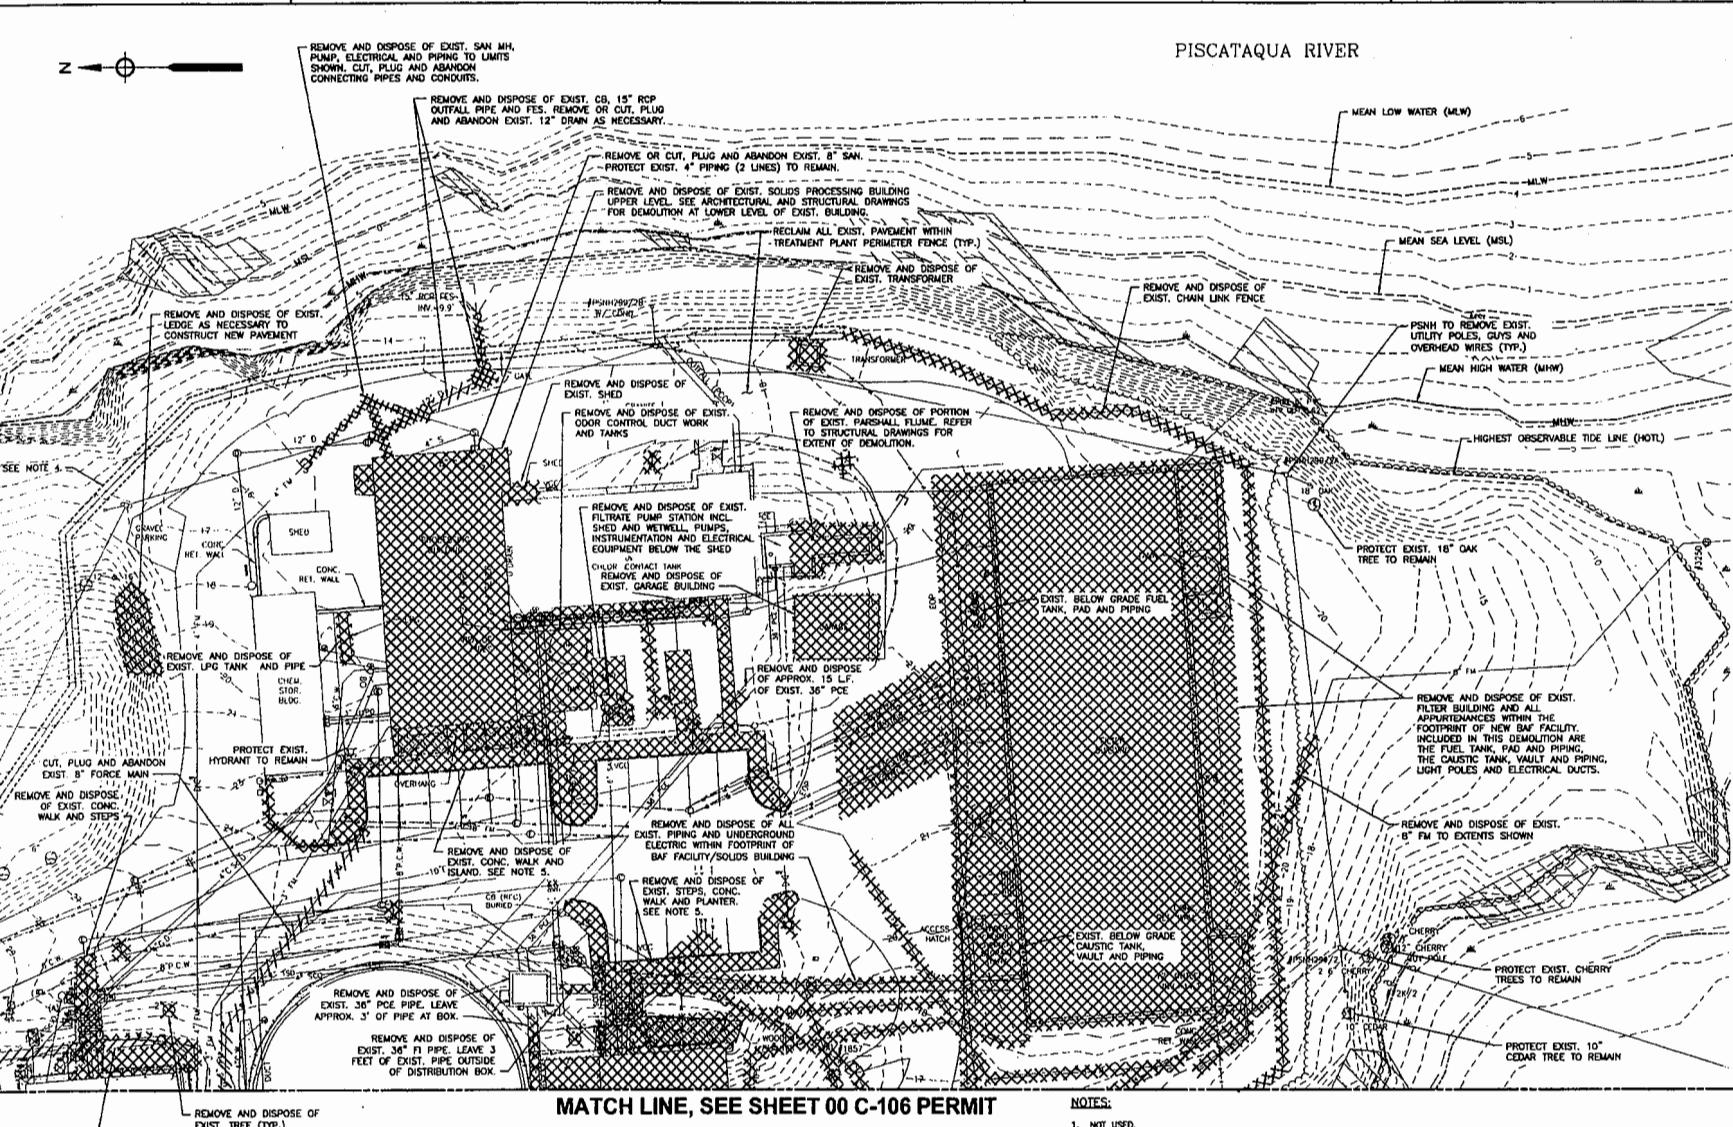


NOTES:

1. NOT USED.
2. NOT USED.
3. NOT USED.
4. EXISTING FENCE SHOWN WITHIN DASHED LINES SHALL REMAIN DURING CONSTRUCTION AND SHALL BE REPLACED AT FINAL COMPLETION.
5. ALL EXISTING GRANITE CURBING REMOVED DURING CONSTRUCTION SHALL BE STOCKPILED AND REUSED WHERE POSSIBLE WHEN CONSTRUCTING FINAL CURBING AND PAVEMENT.

PROJECT NO: 00301525  
CAD DWG FILE: 00 C-104 - PERMIT  
DESIGNED BY: L. BASSILL  
DRAWN BY: H. YEE  
DEPT CHECK: C. BOGDAN  
PROJ CHECK: E. MERRILL  
DATE: JULY 2015  
SCALE: AS NOTED

00 C-105 PERMIT

CITY OF PORTSMOUTH, NH - DEPARTMENT OF PUBLIC WORKS  
PERCE ISLAND WHARF UPGRADE  
DEMOLITION PLAN II  
PERMITTING

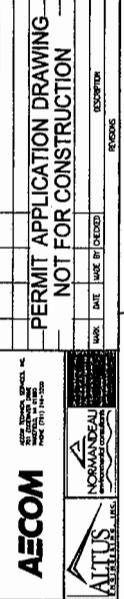

PERMIT APPLICATION DRAWING  
NOT FOR CONSTRUCTION

EXPIRED  
REISSUE


DATE  
EXPIRE BY



## MATCH LINE, SEE SHEET 00 C-104 PERMIT



## MATCH LINE, SEE SHEET 00 C-105 PERMIT

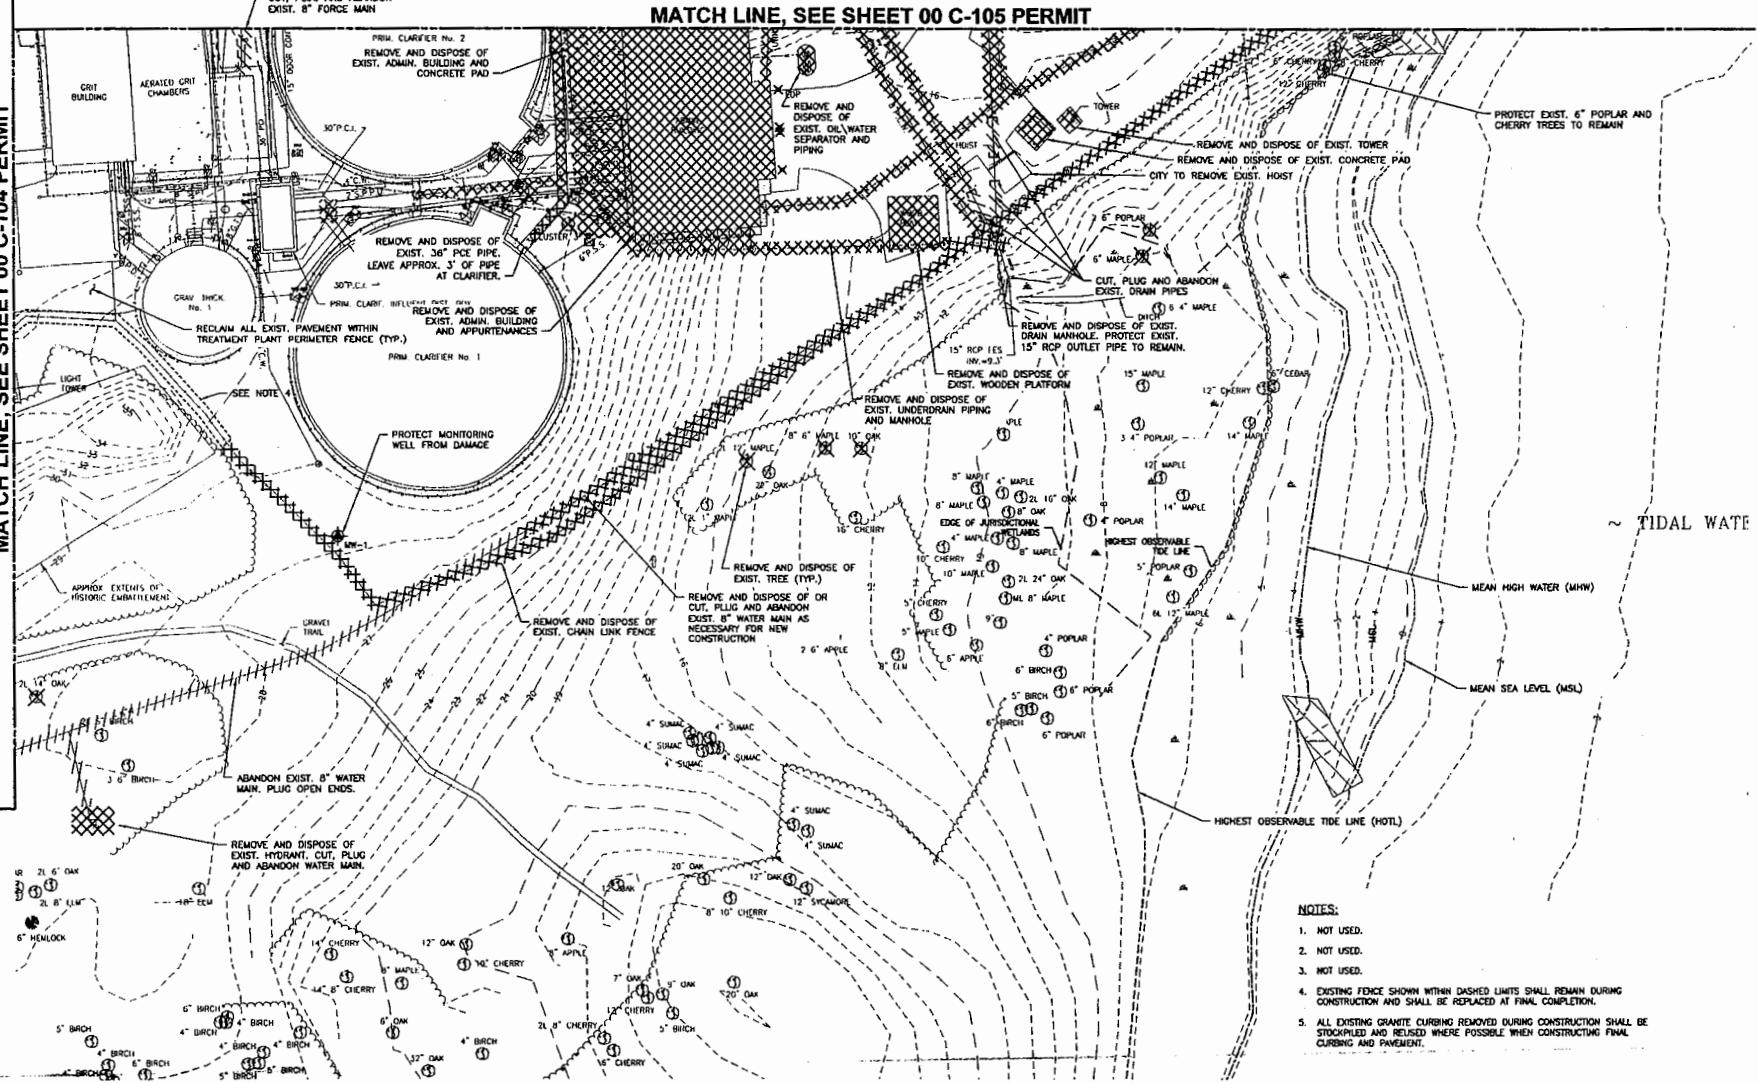

## PLAN

SCALE: 1"-20'

0 20 40 50  
FEET  
SCALE

00 C-106 PERMIT

PERMIT APPLICATION DRAWING  
NOT FOR CONSTRUCTION

AECOM  
NORMANDEAU  
ALTUS  
KATHLEEN INC.



CITY OF PORTSMOUTH NH - DEPARTMENT OF PUBLIC WORKS  
PEIRCE ISLAND WHarf UPGRADE  
DEMOLITION PLAN III  
PERMITTING

- NOTES:
1. NOT USED.
  2. NOT USED.
  3. NOT USED.
  4. EXISTING FENCE SHOWN WITHIN DASHED LINES SHALL REMAIN DURING CONSTRUCTION AND SHALL BE REPLACED AT FINAL COMPLETION.
  5. ALL EXISTING GRANITE CURBING REMOVED DURING CONSTRUCTION SHALL BE STOCKPILED AND REUSED WHERE POSSIBLE WHEN CONSTRUCTING FINAL CURBING AND PAVEMENT.

PROJECT NO. 6031525  
CAD DWG FILE: 00 C-106 - PERMIT  
DESIGNED BY: T. WISEMAN  
DRAWN BY: M. YEE  
DEPT CHECK: C. BENZINGER  
PROJ CHECK: E. MESERVE  
DATE: JAY 2015  
SCALE: AS NOTED


MATCH LINE, SEE THIS SHEET

PLAN

SCALE: 1"=40'

PLAN


SCALE: 1"=40'

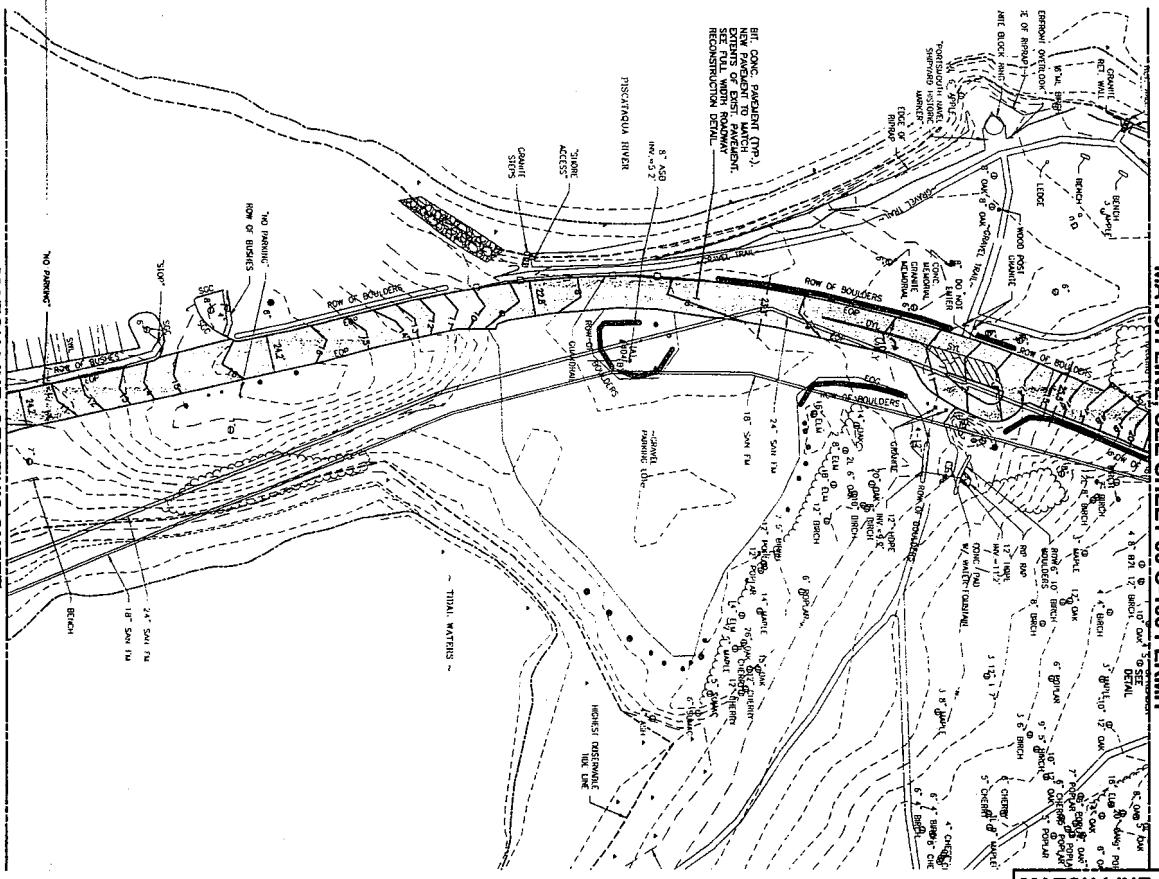

MATCH LINE,  
SEE SHEET  
00 C-110  
PERMIT



MATCH LINE, SEE THIS SHEET

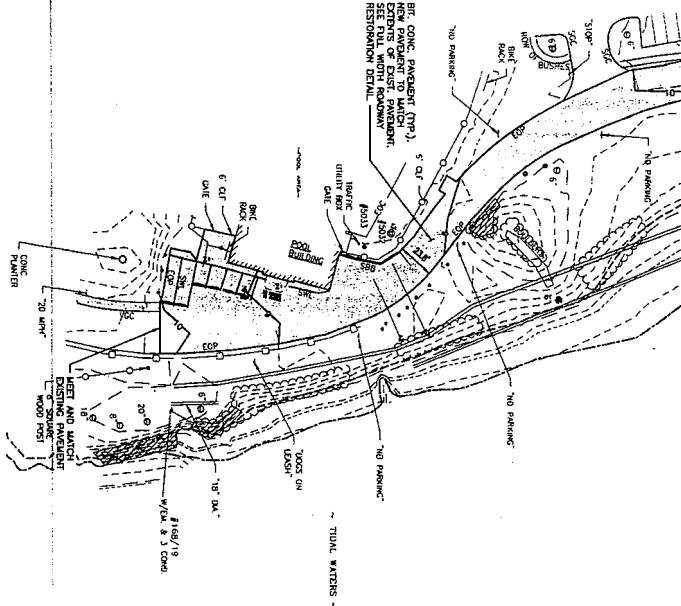

PERMIT APPLICATION DRAWING  
NOT FOR CONSTRUCTION



AECOM



NORMANDEAU  
ENVIRONMENTAL CONSULTANTS INC.

PROJ. NO. 0010155

DATE: 7/14/2015

TIME: 02:57 PM

PERMIT NO. 00 C-107

EXPIRE DATE: 7/14/2016

PERIOD: 12 MONTHS

MARK DATE MADE BY CHECKED


DESCRIPTION

REVOKED

CITY OF PORTSMOUTH, NH - DEPARTMENT OF PUBLIC WORKS  
PEIRCE ISLAND WWTF UPGRADE  
SITE LAYOUT, PAVING, GRADING  
AND DRAINAGE PLAN I  
PERMITTING

MATCH LINE, SEE SHEET  
00 C-107 PERMIT

MATCH LINE, SEE SHEET  
00 C-108 PERMIT

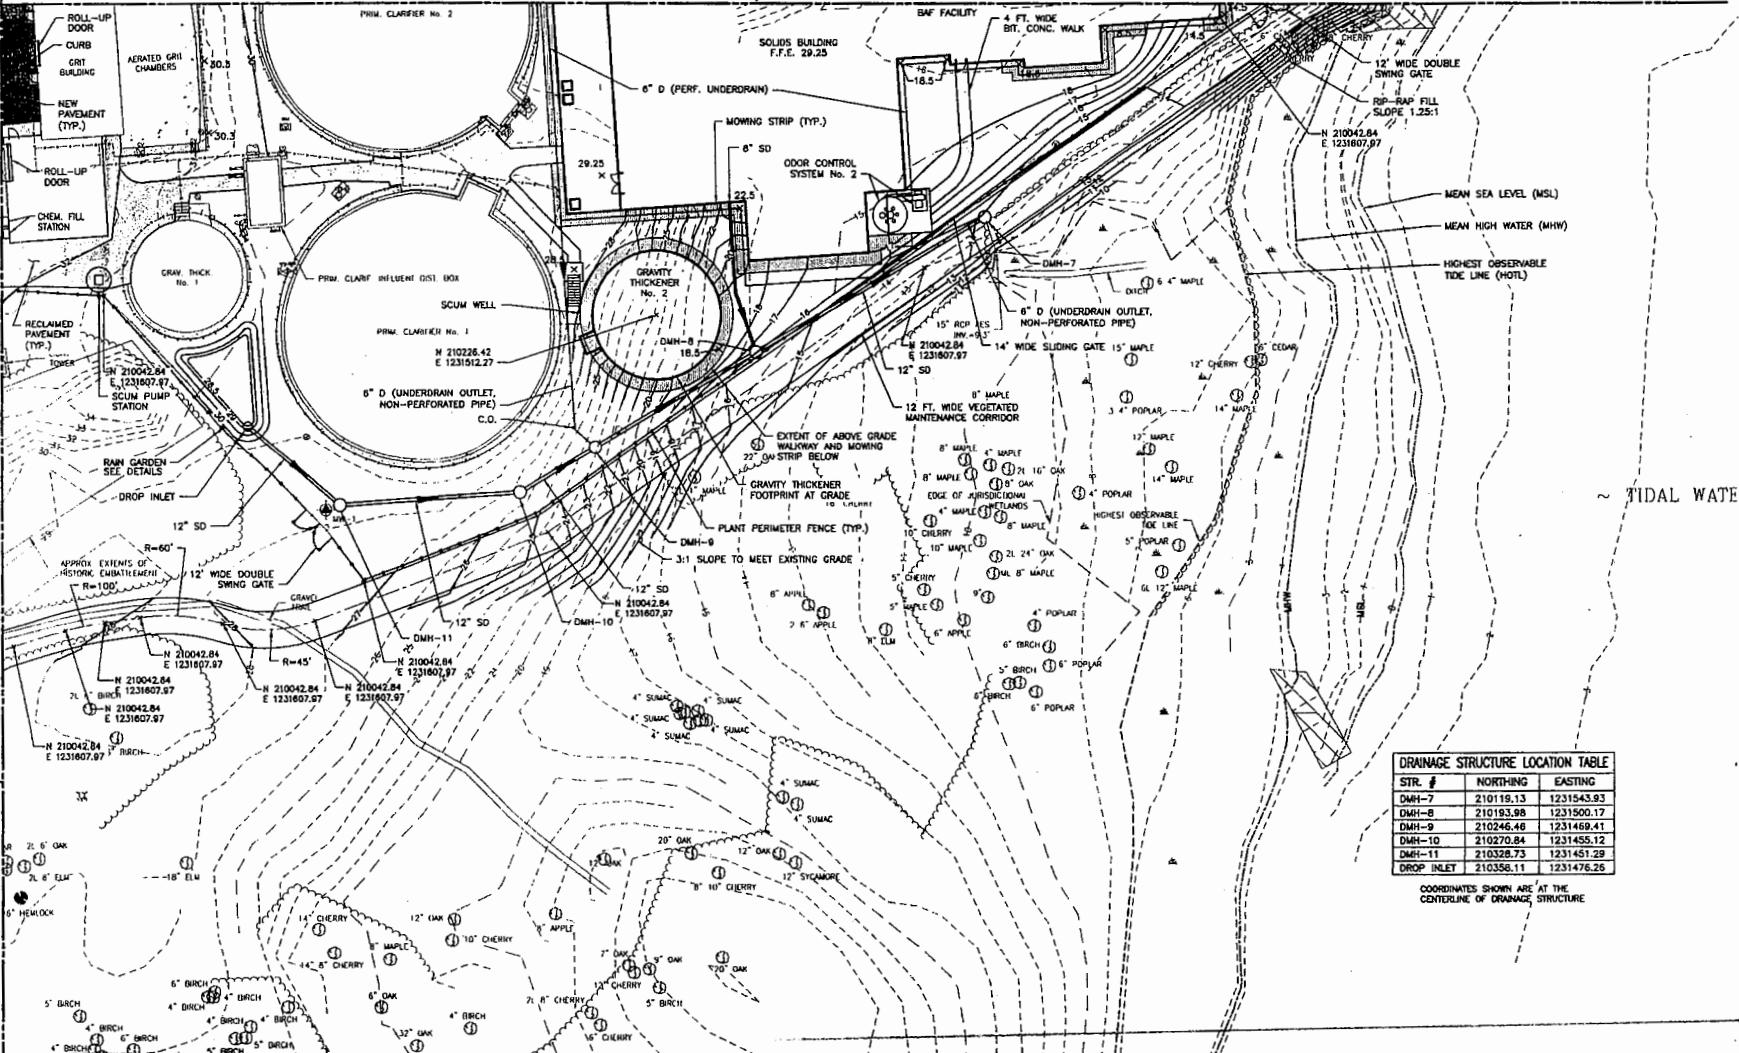

PLAN

SCALE: 1"-20'

DRAINAGE STRUCTURE LOCATION TABLE		
STRUCTURE #	NORTHLING	EASTING
DMH-7	210119.13	1231543.93
DMH-8	210153.98	1231500.17
DMH-9	210246.48	1231469.41
DMH-10	210270.84	1231455.12
DMH-11	210328.73	1231451.29
DROP INLET	210356.11	1231476.25

COORDINATES SHOWN ARE AT THE CENTERLINE OF DRAINAGE STRUCTURE

0 20 40 60  
FEET  
SCALE


00 C-110 PERMIT

PERMIT APPLICATION DRAWING  
NOT FOR CONSTRUCTION



CITY OF PORTSMOUTH - NH - DEPARTMENT OF PUBLIC WORKS  
PIERCE ISLAND WATERSHED UPGRADE  
SITE LAYOUT, PAVING, GRADING  
AND DRAINAGE PLAN IV  
PERMITTING

PROJECT NO: 80301525  
CAD DWG FILE: 00-C-110 - PLAN  
DRAWN BY: L. MUSSEL  
DRAWN BY: K. TEE  
DOPT CHECK: C. BOODRER  
PROJ CHECK: E. MORSE  
DATE: JULY 2015  
SCALE: AS NOTED

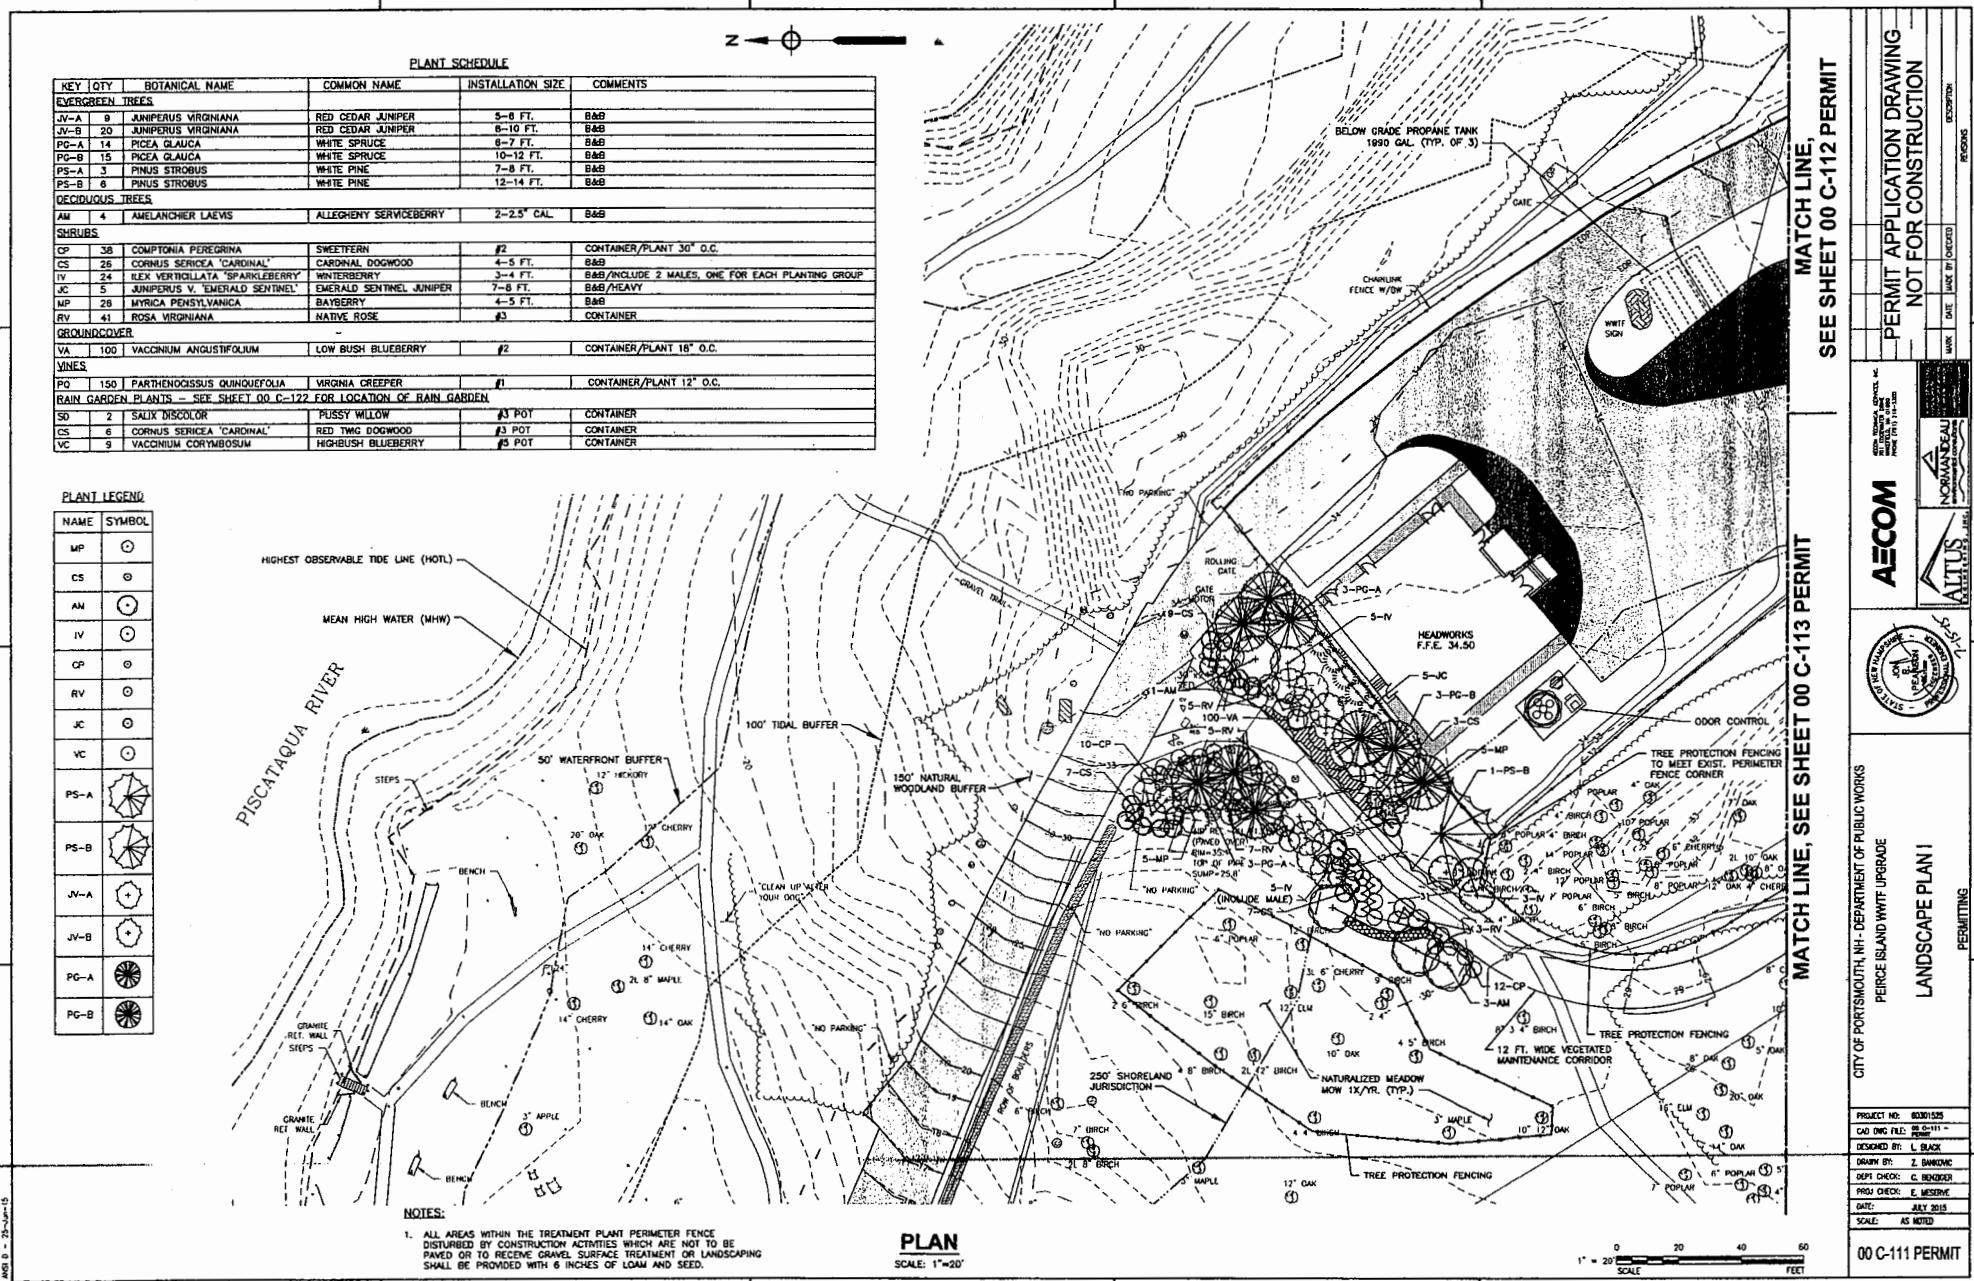

**PERMIT APPLICATION DRAWING  
NOT FOR CONSTRUCTION**


REVISIONS

DATE MADE BY CHECKED

NAME

**AECOM**

**NORMANDEAU ALTIUS**

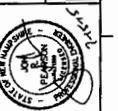

CITY OF PORTSMOUTH NH - DEPARTMENT OF PUBLIC WORKS

PIERCE ISLAND WWTF UPGRADE

LANDSCAPE PLAN II

PERMITTING

**MATCH LINE,  
SEE SHEET 00 C-111 PERMIT**


**MATCH LINE, SEE SHEET 00 C-113 PERMIT**

**PLAN**


SCALE: 1"=20'

0 20 40 60  
FEET

- NOTES:
1. ALL AREAS WITHIN THE TREATMENT PLANT PERIMETER FENCE DISTURBED BY CONSTRUCTION ACTIVITIES WHICH ARE NOT TO BE PAVED OR TO RECEIVE GRAVEL SURFACE TREATMENT OR LANDSCAPING SHALL BE PROVIDED WITH 6 INCHES OF LOAM AND SEED.

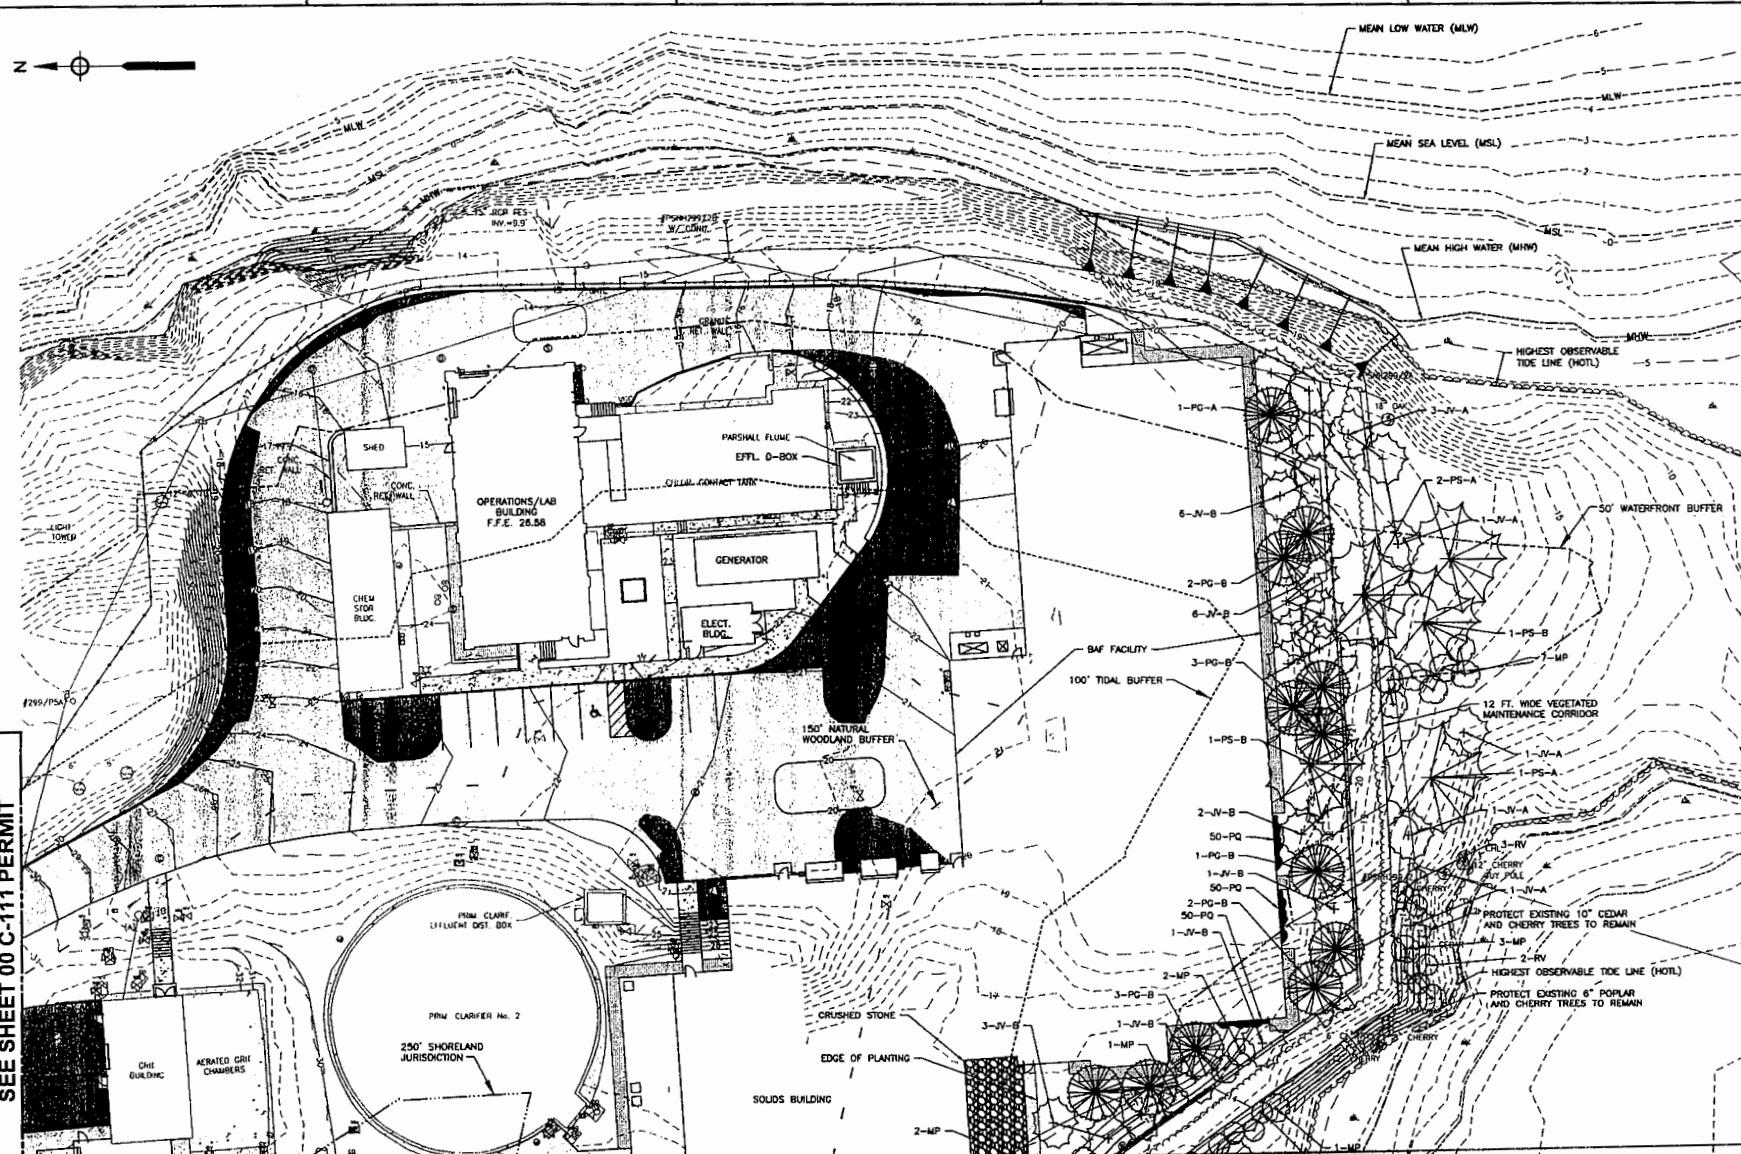

## MATCH LINE, SEE SHEET 00 C-111 PERMIT

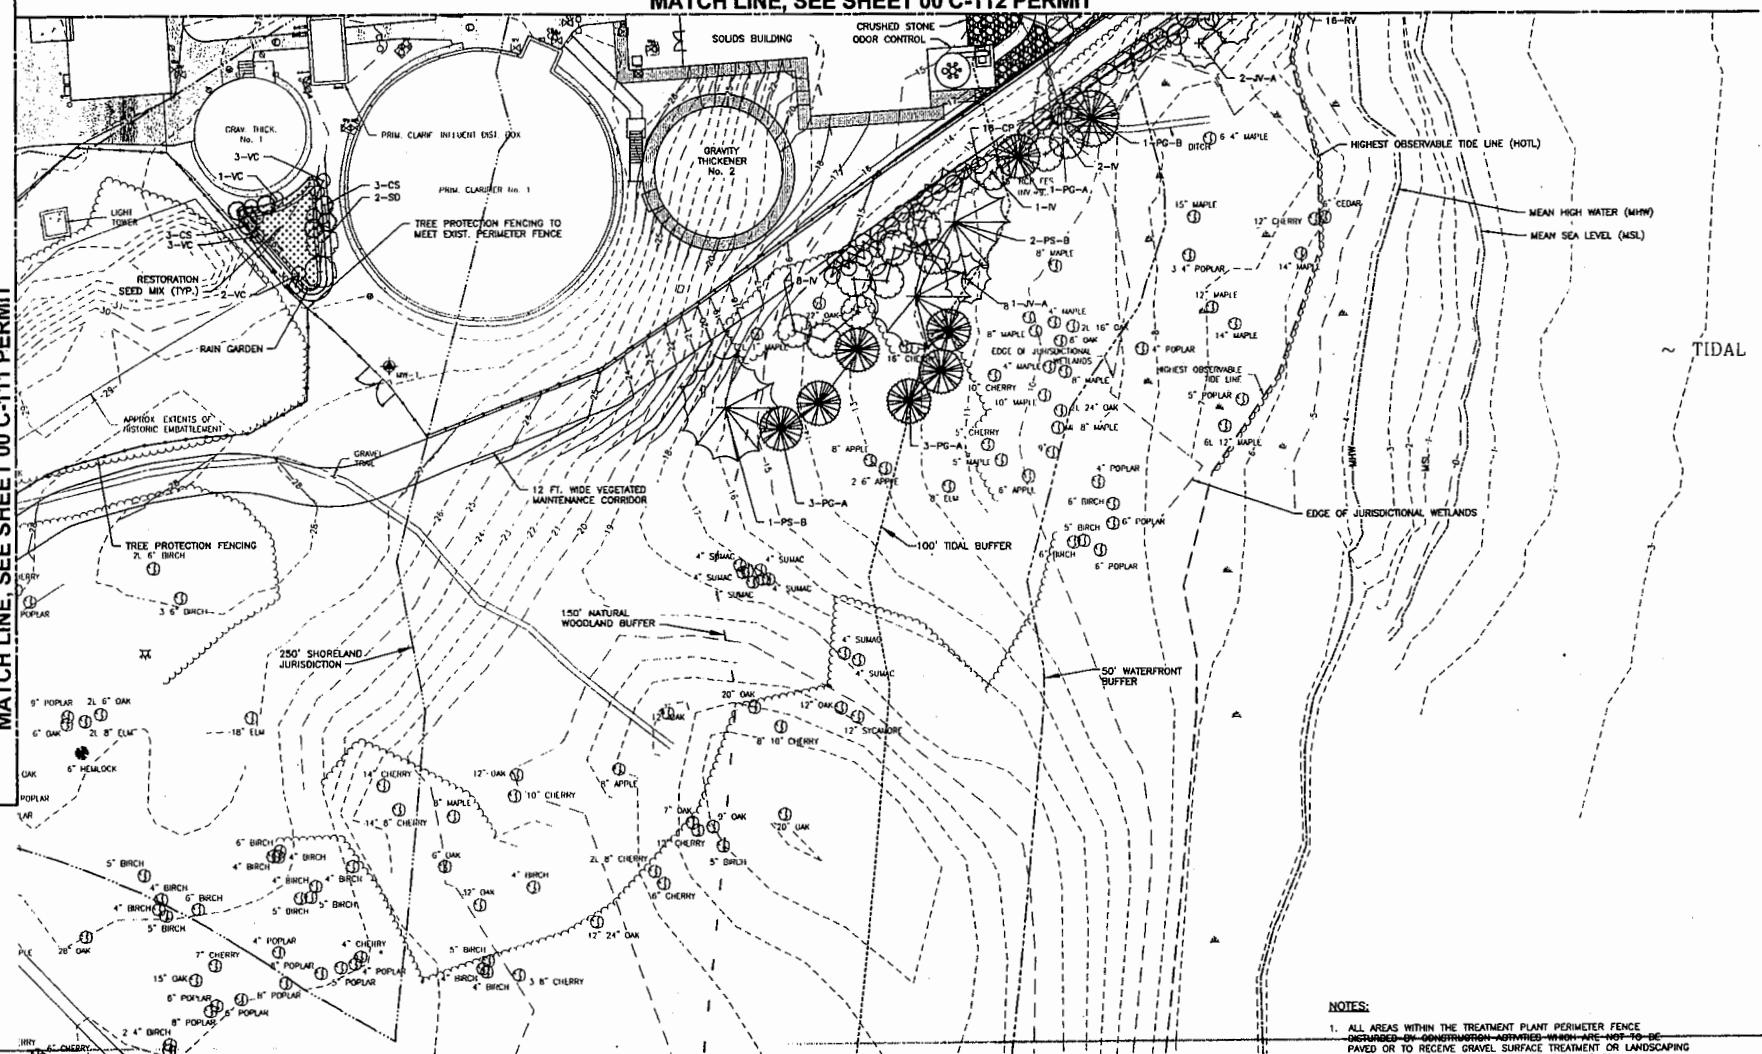

PLAN

SCALE: 1"-20'

0 20 40 60  
SCALE FEET

00 C-113 PERMIT

PROJECT NO. 60301525  
CAD FILE: 00-C-113-  
DESIGNED BY: L. BLACK  
DRAWN BY: Z. BAKOCZ  
DEPI CHECK: C. BOODER  
PROJ. CHECK: E. MEDINE  
DATE: JULY 2013  
SCALE: AS NOTED

CITY OF PORTSMOUTH, NH - DEPARTMENT OF PUBLIC WORKS  
PEICE ISLAND WWTF UPGRADE  
LANDSCAPE PLAN III  
PERMITTING


PERMIT APPLICATION DRAWING  
NOT FOR CONSTRUCTION


WORK	DATE	NAME BY DESCRIBED
------	------	-------------------

AECOM  
NORMANDAU  
Environmental Services



1000 Main Street  
Portsmouth, NH 03801  
603.436.4400  
www.ci.portsmouth.nh.us

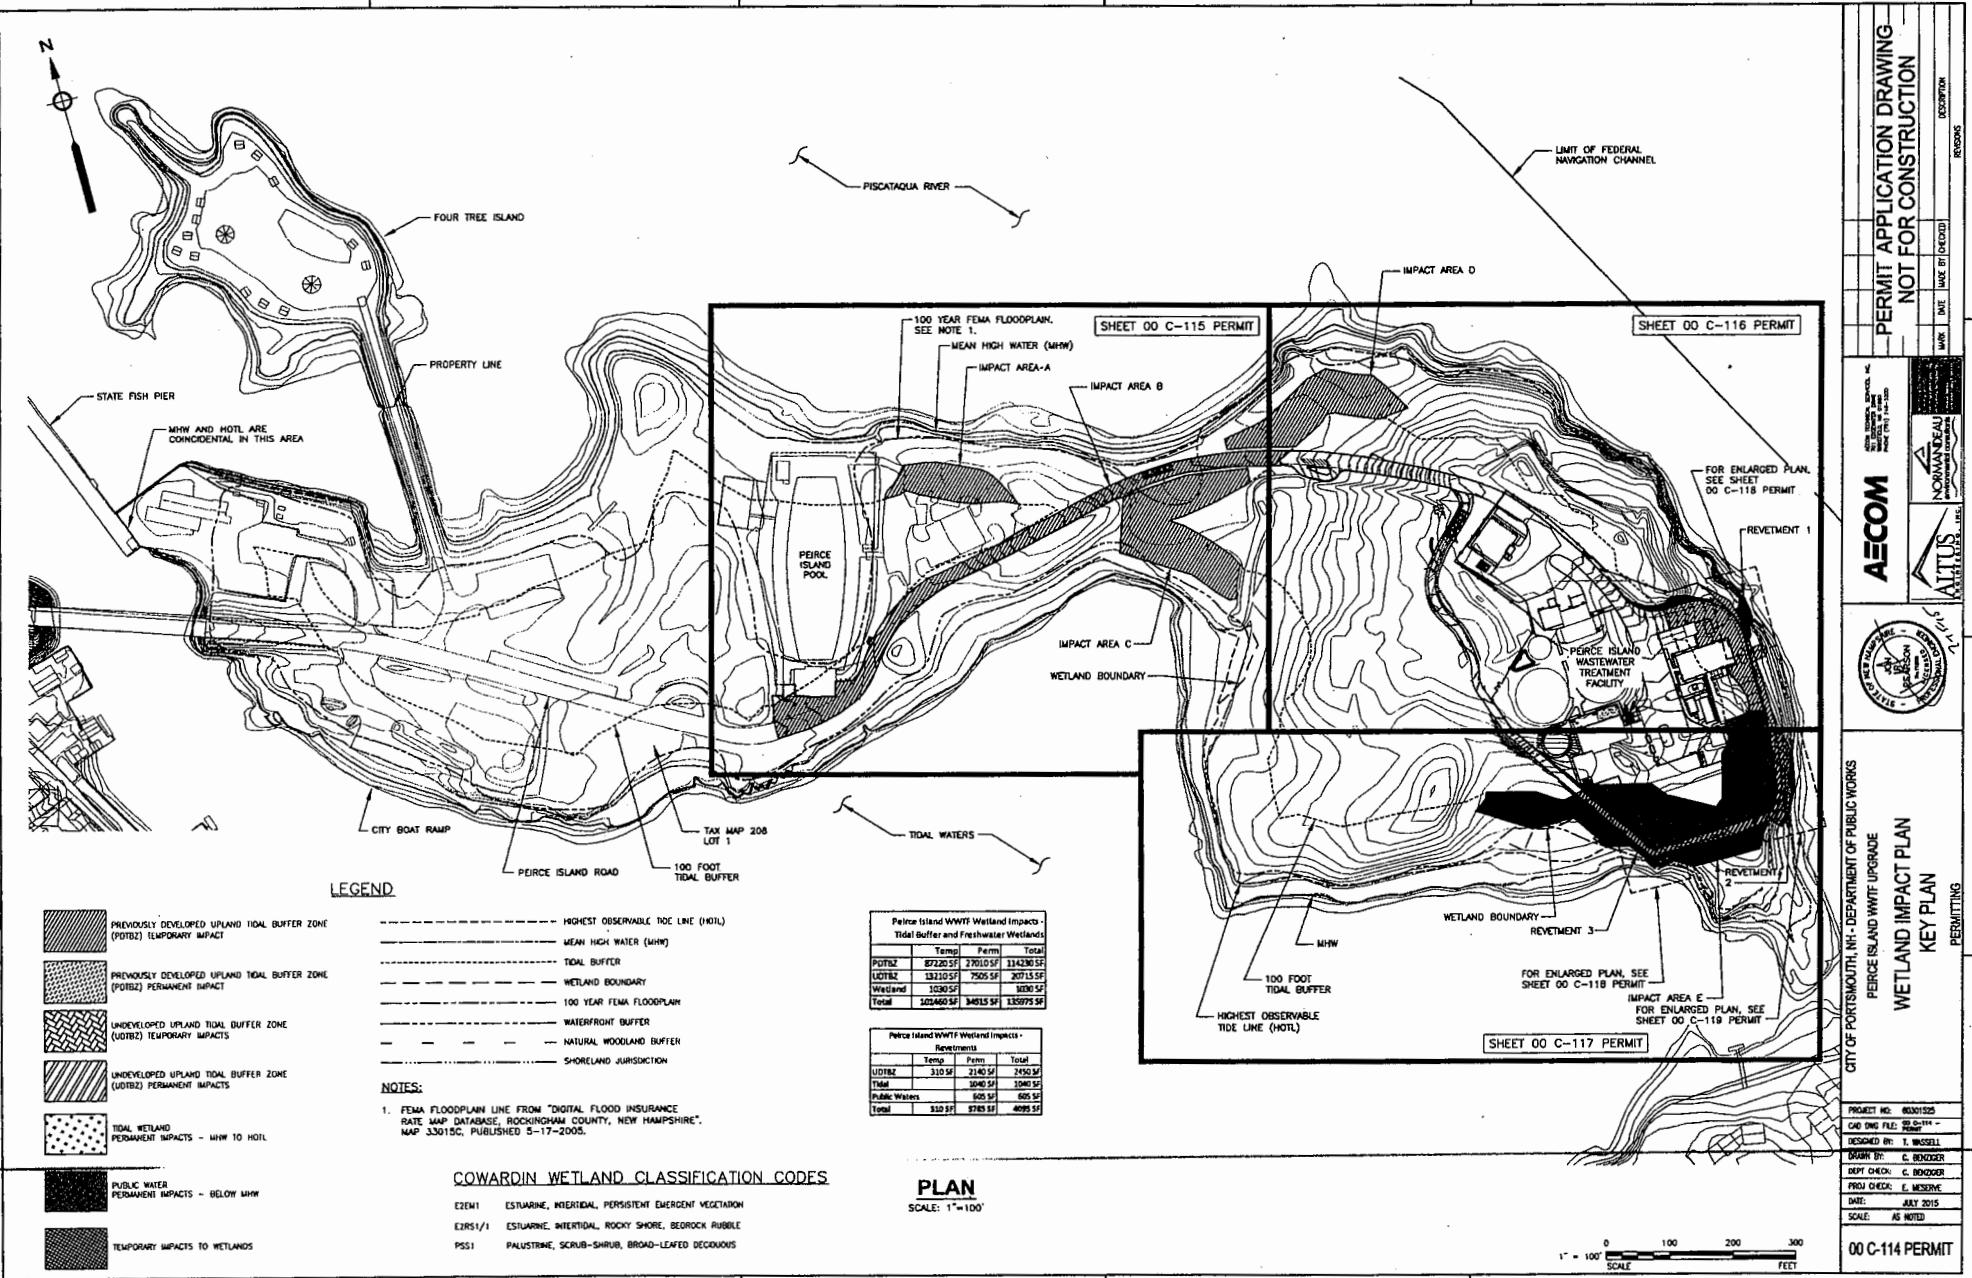

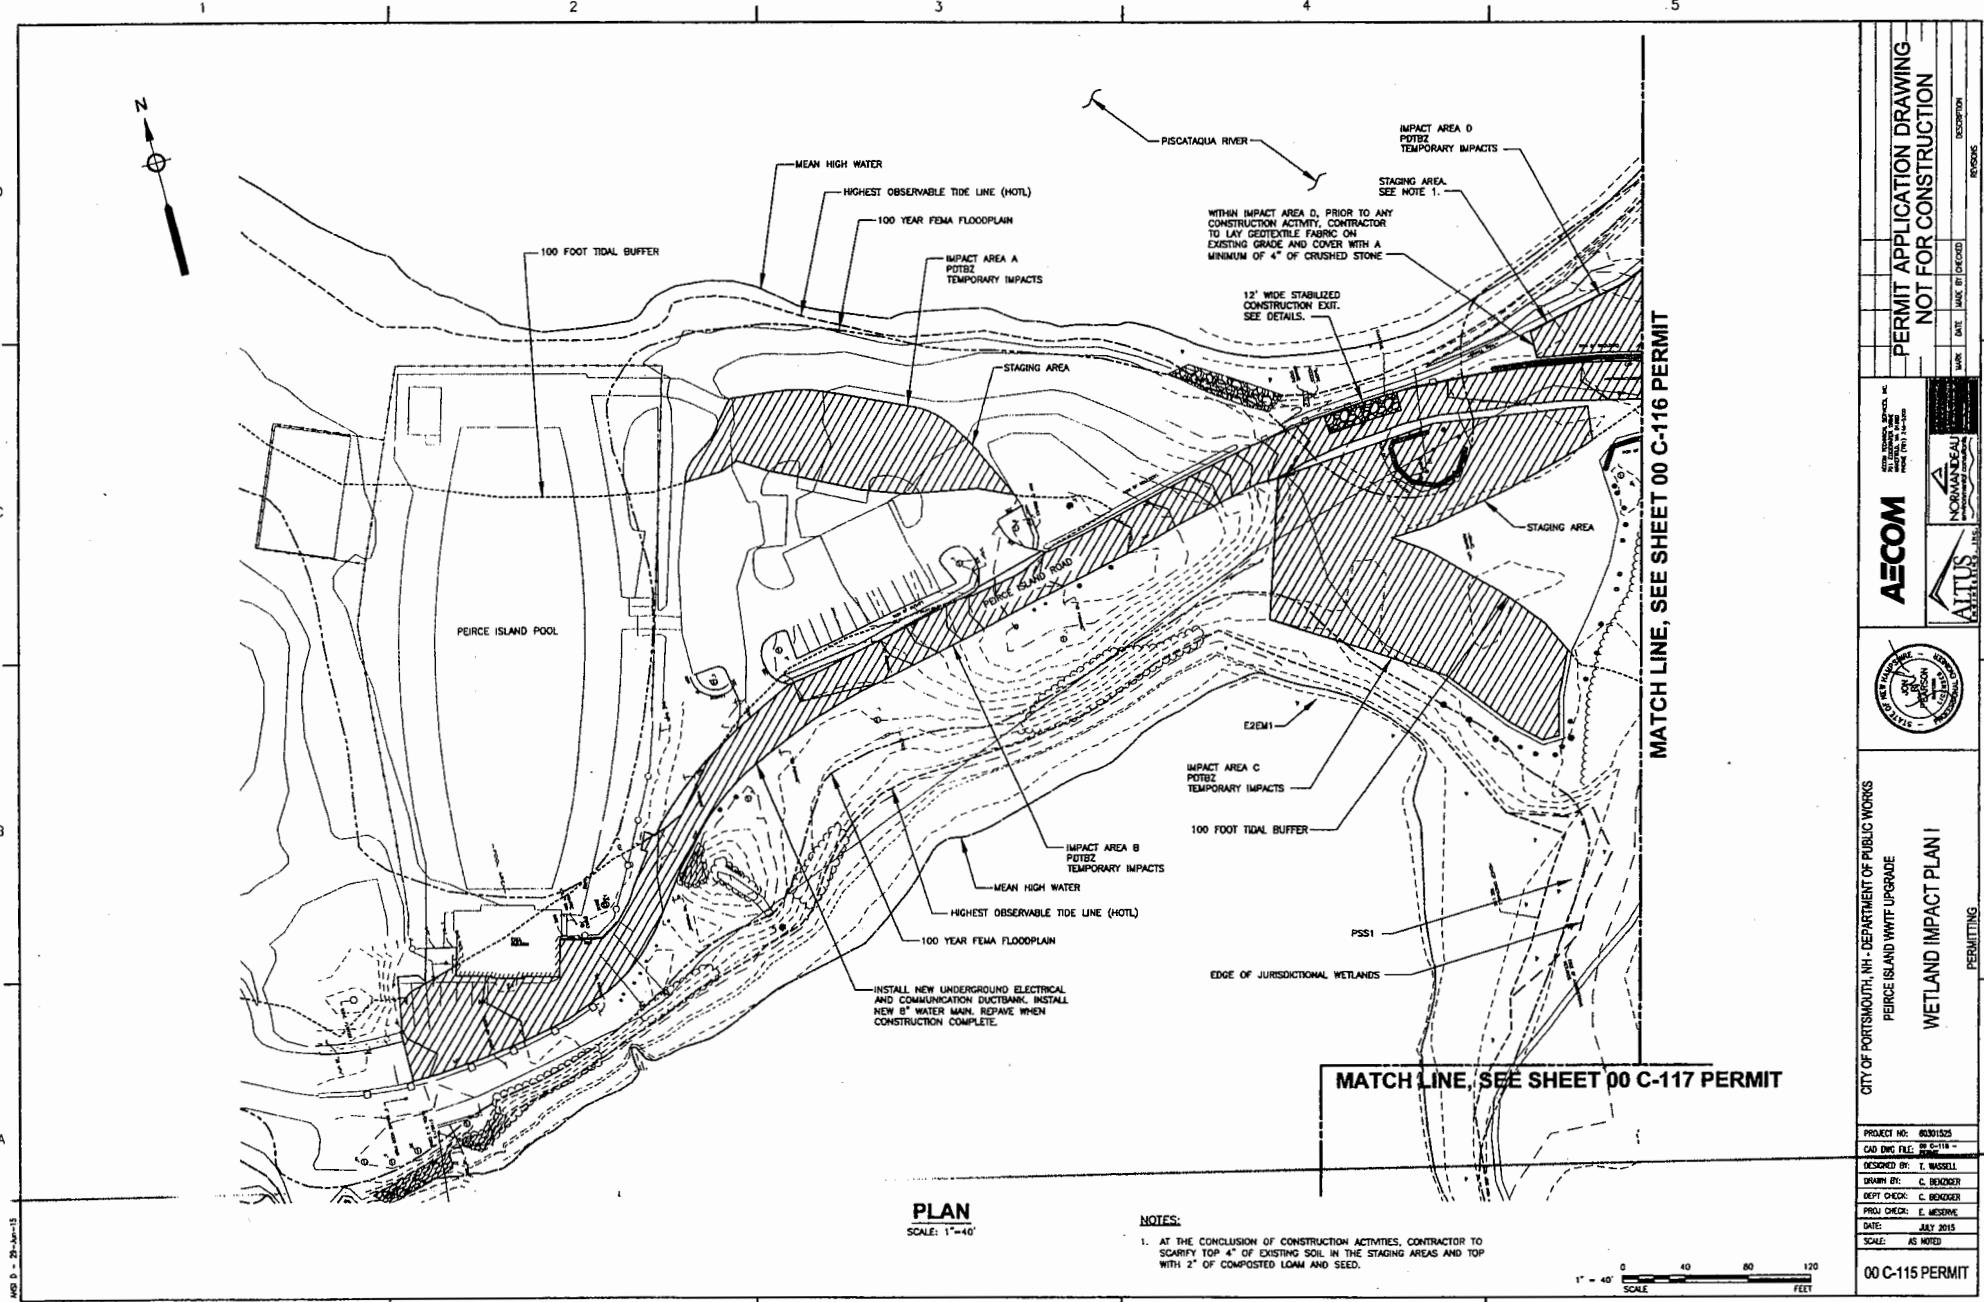

**PERMIT APPLICATION DRAWING  
NOT FOR CONSTRUCTION**


**AECOM**  
NORMANDALE  
CONTRACTORS  
AITUS CONSULTANTS



**WETLAND IMPACT PLAN II**

CITY OF PORTSMOUTH, NH - DEPARTMENT OF PUBLIC WORKS  
PEIRCE ISLAND WWTF UPGRADE

PERMITTING

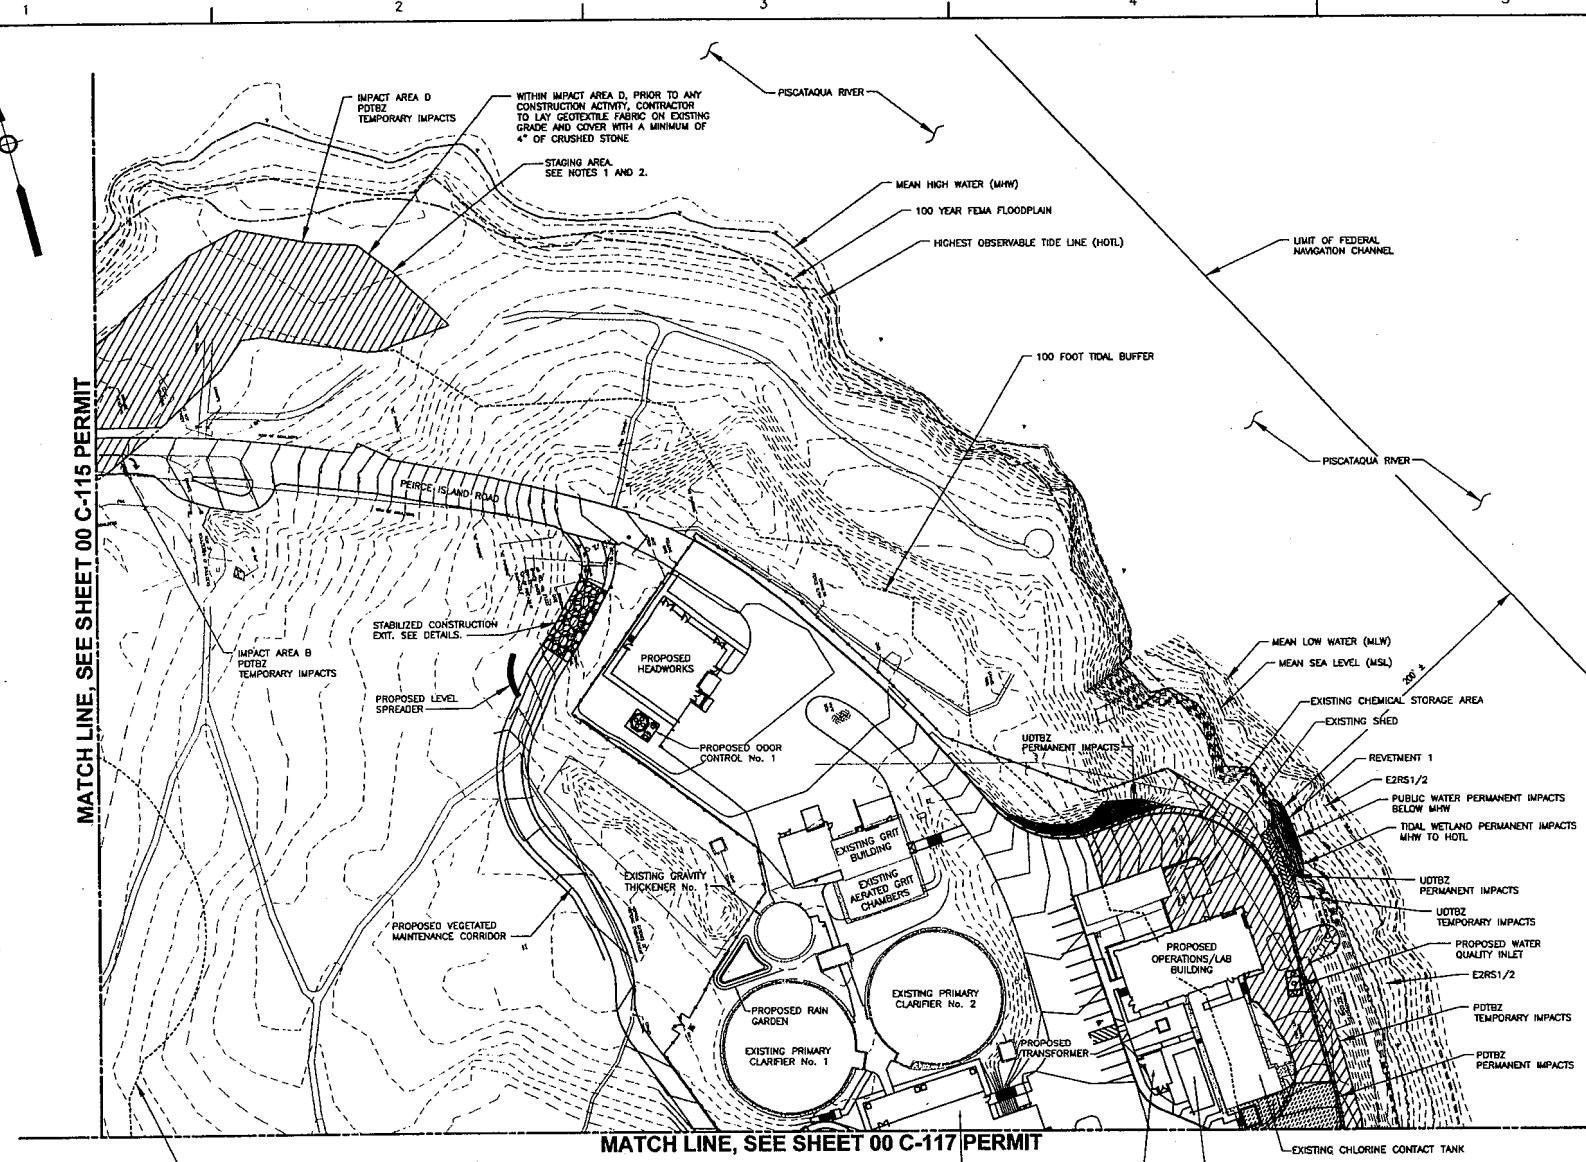

**NOTES:**

1. AT THE CONCLUSION OF CONSTRUCTION ACTIVITIES, CONTRACTOR TO SCARIFY TOP 4" OF EXISTING SOIL IN THE STAGING AREAS AND TOP WITH 2" OF COMPOSTED LOAM AND SEED.
2. PRIOR TO ANY CONSTRUCTION ACTIVITY, CONTRACTOR TO LAY GEOTEXTILE FABRIC ON EXISTING GRADE AND COVER WITH A MINIMUM OF 4" OF CRUSHED STONE.

**PLAN**

SCALE: 1" = 40'

1" = 40' 0 40 80 120  
SCALE FEET

PROJECT NO. 00301525  
CAD DWG FILE: 00-C-116.dwg  
DESIGNED BY: T. MASSI  
DRAWN BY: C. BENZER  
DRAFT CHECK: C. BENZER  
PROJ CHECK: E. MESEIVE  
DATE: JULY 2015  
SCALE: AS NOTED

00 C-116 PERMIT

**PERMIT APPLICATION DRAWING  
NOT FOR CONSTRUCTION**







**ENLARGED PLANS AND SECTIONS  
REVERTMENT AREAS I  
REBELLING**


PROJECT NO: 60301525  
CAD DWG FILE: 00-C-118-  
DESIGNED BY: T. MUSSET

DRAWN BY: C. BENDER  
DOPT CHECK: C. BENDER  
PROJ. CHECK: E. KIRKSEY  
DATE: JULY 2015  
SCALE: AS NOTED

00 C-118 PERMIT

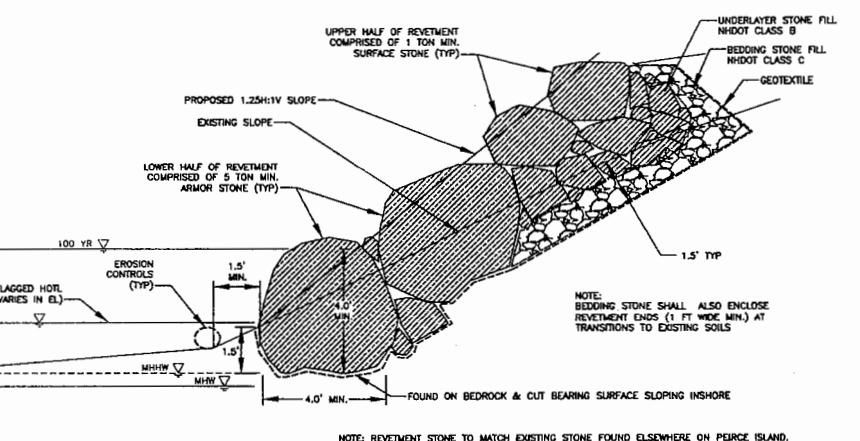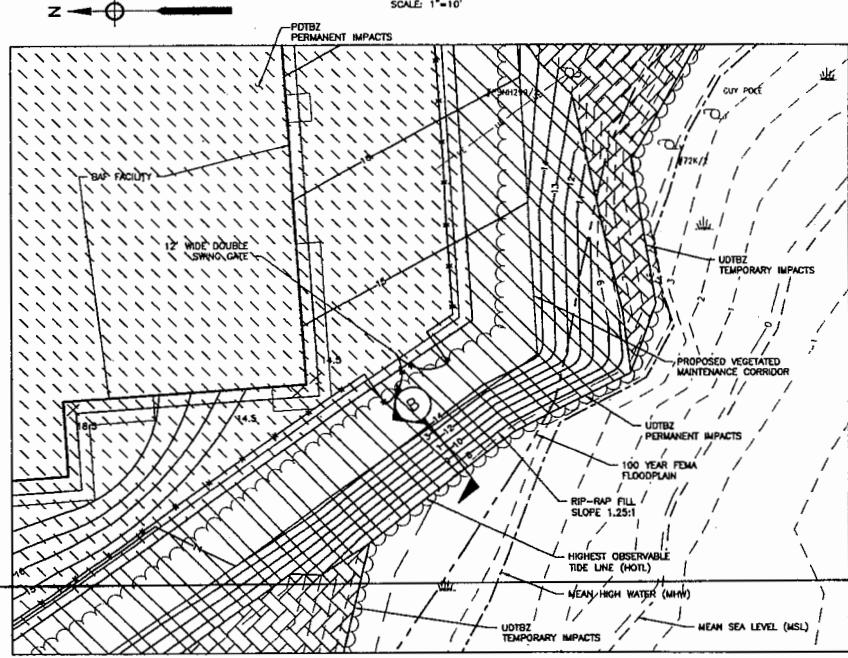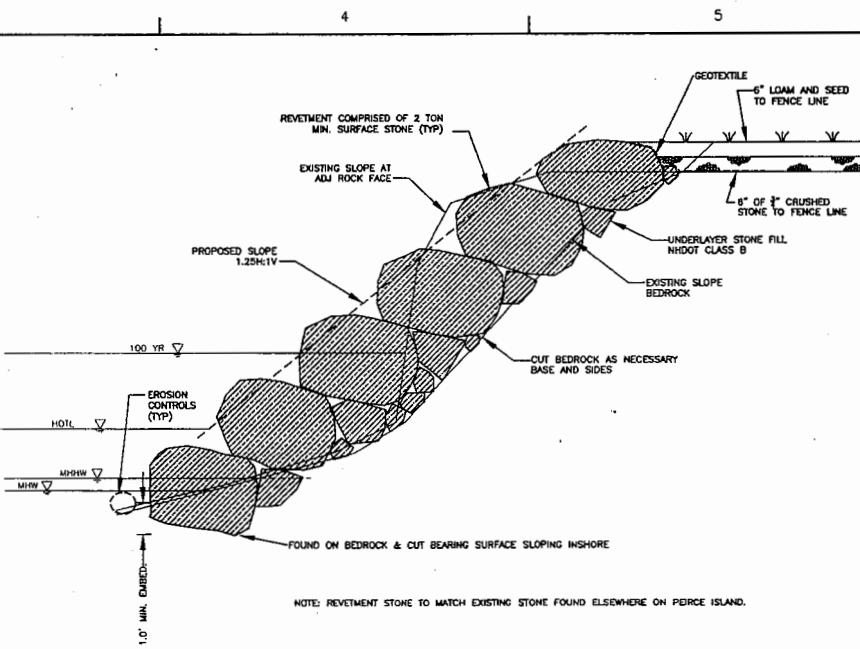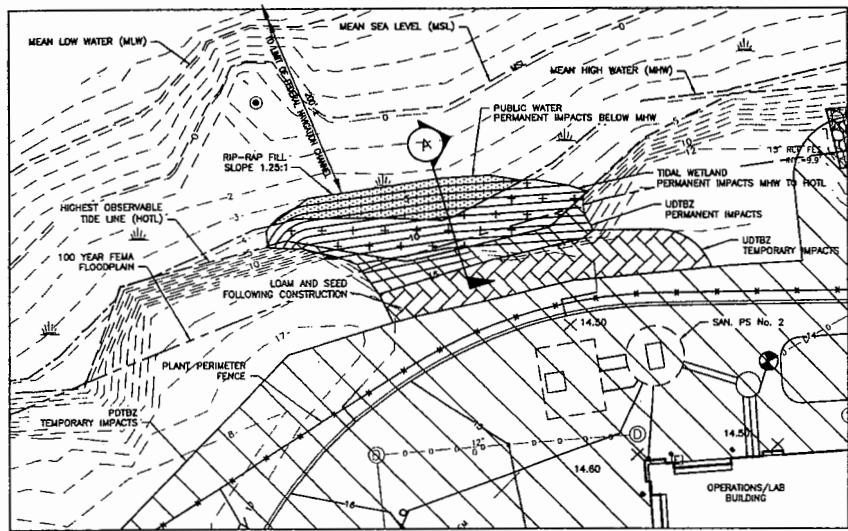

**PERMIT APPLICATION DRAWING  
NOT FOR CONSTRUCTION**

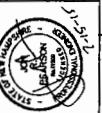

CITY OF PORTSMOUTH, NH - DEPARTMENT OF PUBLIC WORKS

**DETAILS I**

PERMITTING

PROJECT NO: 80301525
CAD DWG FILE: 80-6180-PERMIT
DESIGNED BY: J. MASTELL
DRAWN BY: L. YEE
DEPT CHECK: C. BENZER
PROD CHECK: E. MUSINE
DATE: JULY 2015
SCALE: AS NOTED

00 C-120 PERMIT

TRENCH WIDTH $W_s$ OR $W_u$			
NOMINAL PIPE DIAMETER	DEPTH OF PIPE INVERT BELOW GROUND SURFACE		
0	0 TO 12' 12' TO 20' >20'		
24" AND SMALLER	5'-0" 7'-0" 9'-0"		
OVER 24"	0 + 3'-0" 0 + 5'-0" 0 + 7'-0"		


1. PIPE TRENCHES MAY BE EXCAVATED WIDER THAN TRENCH WIDTH  $W_s$  (SHEETED) OR  $W_u$  (UNSHIELDED) ABOVE THE TOP OF PIPE ZONE.
2. TRENCHES SHALL NOT BE EXCAVATED BEYOND THE TRENCH WIDTH  $W_u$  BELOW THE TOP OF PIPE ZONE.
3. SHEETING MUST BE USED IF EXCAVATION AND BACKFILL BELOW NORMAL DEPTH IS REQUIRED. SHEETING SHALL BE LEFT IN PLACE BELOW A LINE 1'-0" ABOVE THE TOP OF PIPE.

**GENERAL NOTES FOR PIPE TRENCHES**

NOT TO SCALE  
2-1-1.21 (REV. 10-23-95)

**TRENCH SECTION IN  
UNACCEPTABLE MATERIAL**

NOT TO SCALE  
2-1-1.21 (REV. 03-15-95)

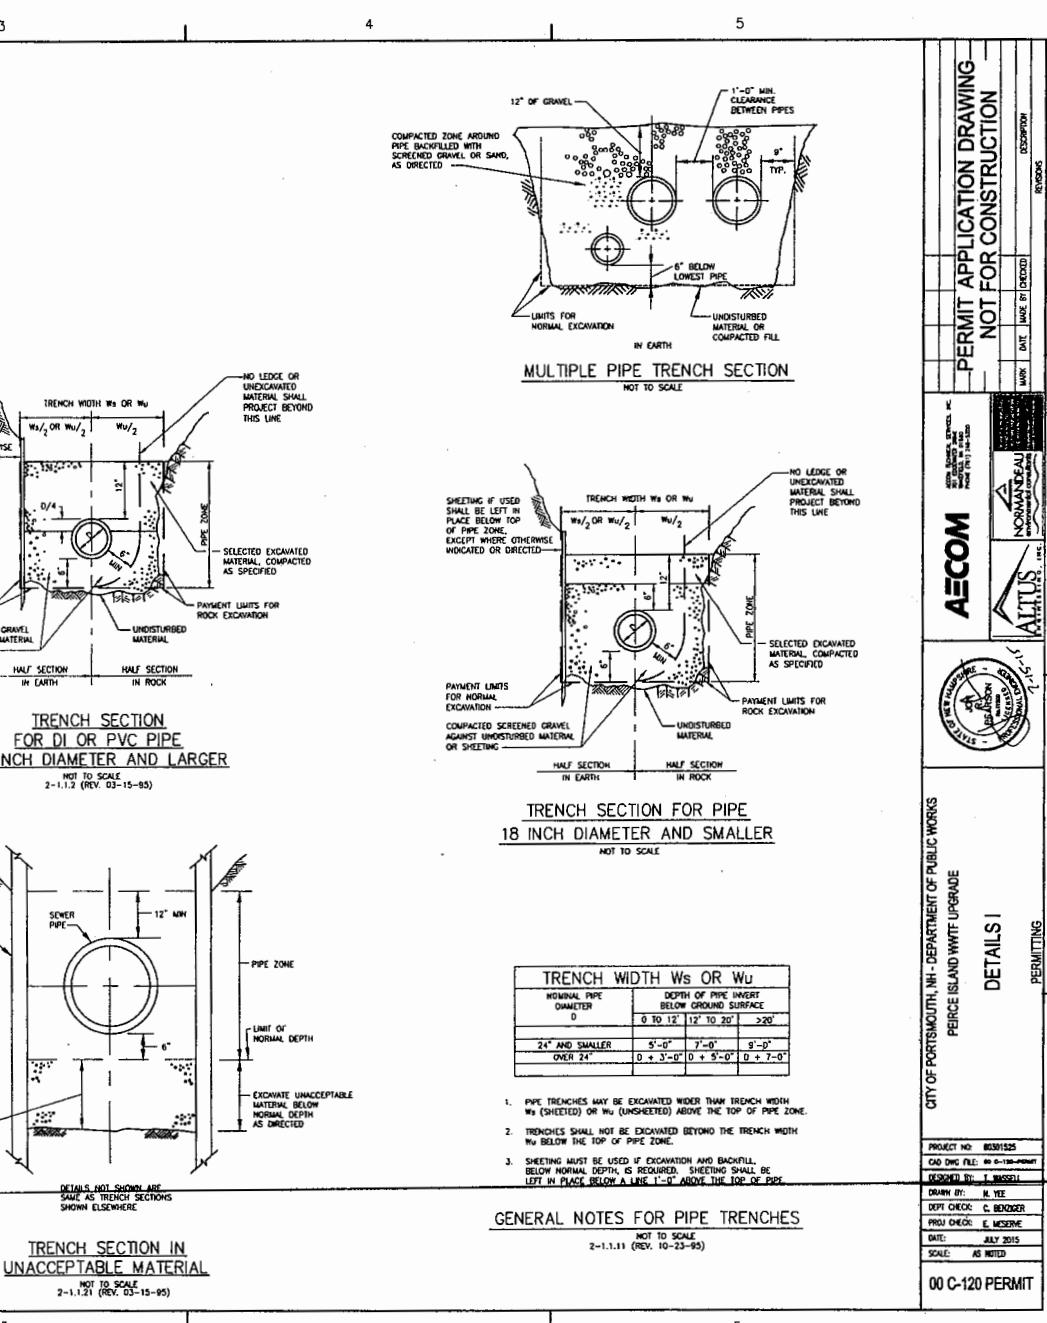


**STRAW BALE EROSION CONTROL**

NTS  
2-1-60.4 (REV. 08-29-95)


NOTE:  
DO NOT USE IF LOCATION PREVENTS  
THE EXISTING GROUND SLOPES IN  
TOWARD THE TOE OF THE EMBANKMENT.

TYPE A: OVERLAP EDGES

NOTE:  
DO NOT USE WHERE EXISTING  
GROUND SLOPES AWAY FROM THE  
TOE OF THE EMBANKMENT.

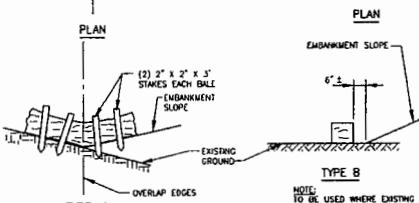

**PERMIT APPLICATION DRAWING  
NOT FOR CONSTRUCTION**

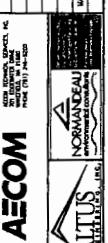








CITY OF PORTSMOUTH NH-DEPARTMENT OF PUBLIC WORKS

DETAILS II

PERMITTING

PROJECT NO: 00301525  
CAD Dwg FILE: WD-C-121-PERM  
DESIGNED BY: T. RUSSELL  
DRAWN BY: N. YEE  
DRAFT CHECK: C. BENDER  
PROJ CHECK: E. RESERVE  
DATE: JULY 2015  
SCALE: AS NOTED

00 C-121 PERMIT

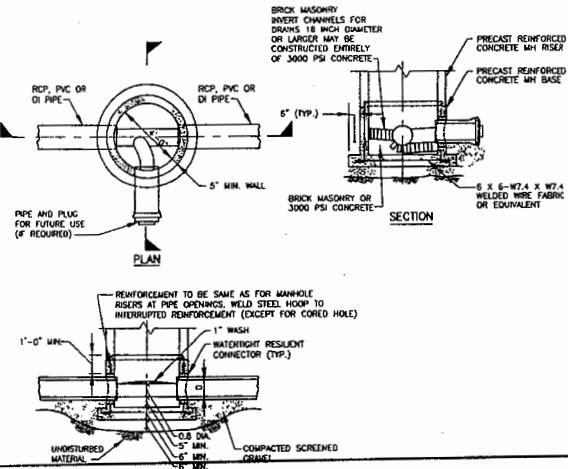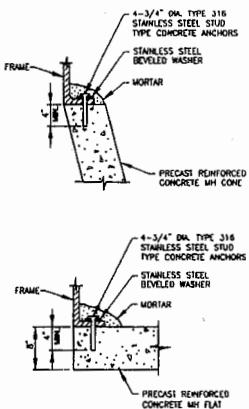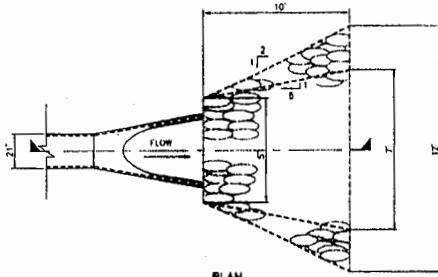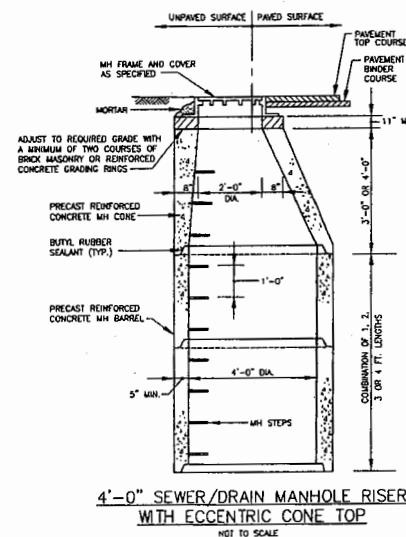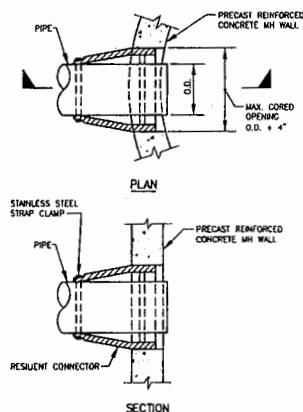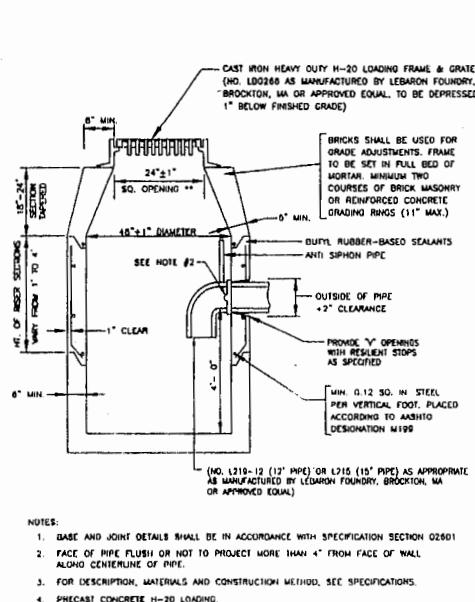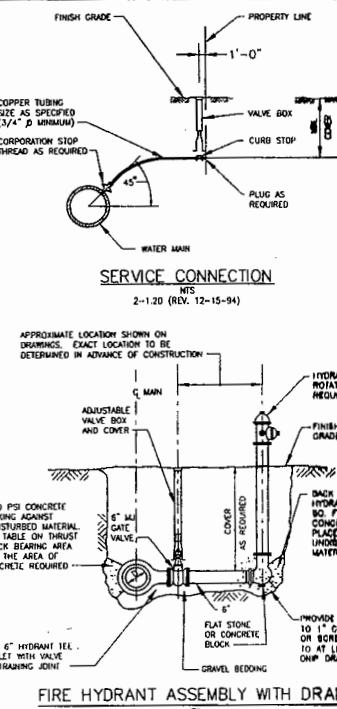

**4'-0" PRECAST REINFORCED CONCRETE  
MANHOLE BASE FOR SEWER/DRain MANHOLES**  
NOT TO SCALE

**PERMIT APPLICATION DRAWING  
NOT FOR CONSTRUCTION**


DESCRIPTION

NAME DATE MADE BY CHECKED


**AECOM**  
**NORMANDEAU**  
**ALTIUS**

**DETAILS III**  
**PERMITTING**


PROJECT NO. 60301325  
CAD Dwg. FILE: M-181-PDFN  
DESIGNED BY: T. WISELL  
DRAWN BY: M. YEE  
DRAFT CHECK: C. BENZER  
PROJ. CHECK: E. MESSINE  
DATE: JULY 2015  
SCALE: AS NOTED  
00 C-122 PERMIT

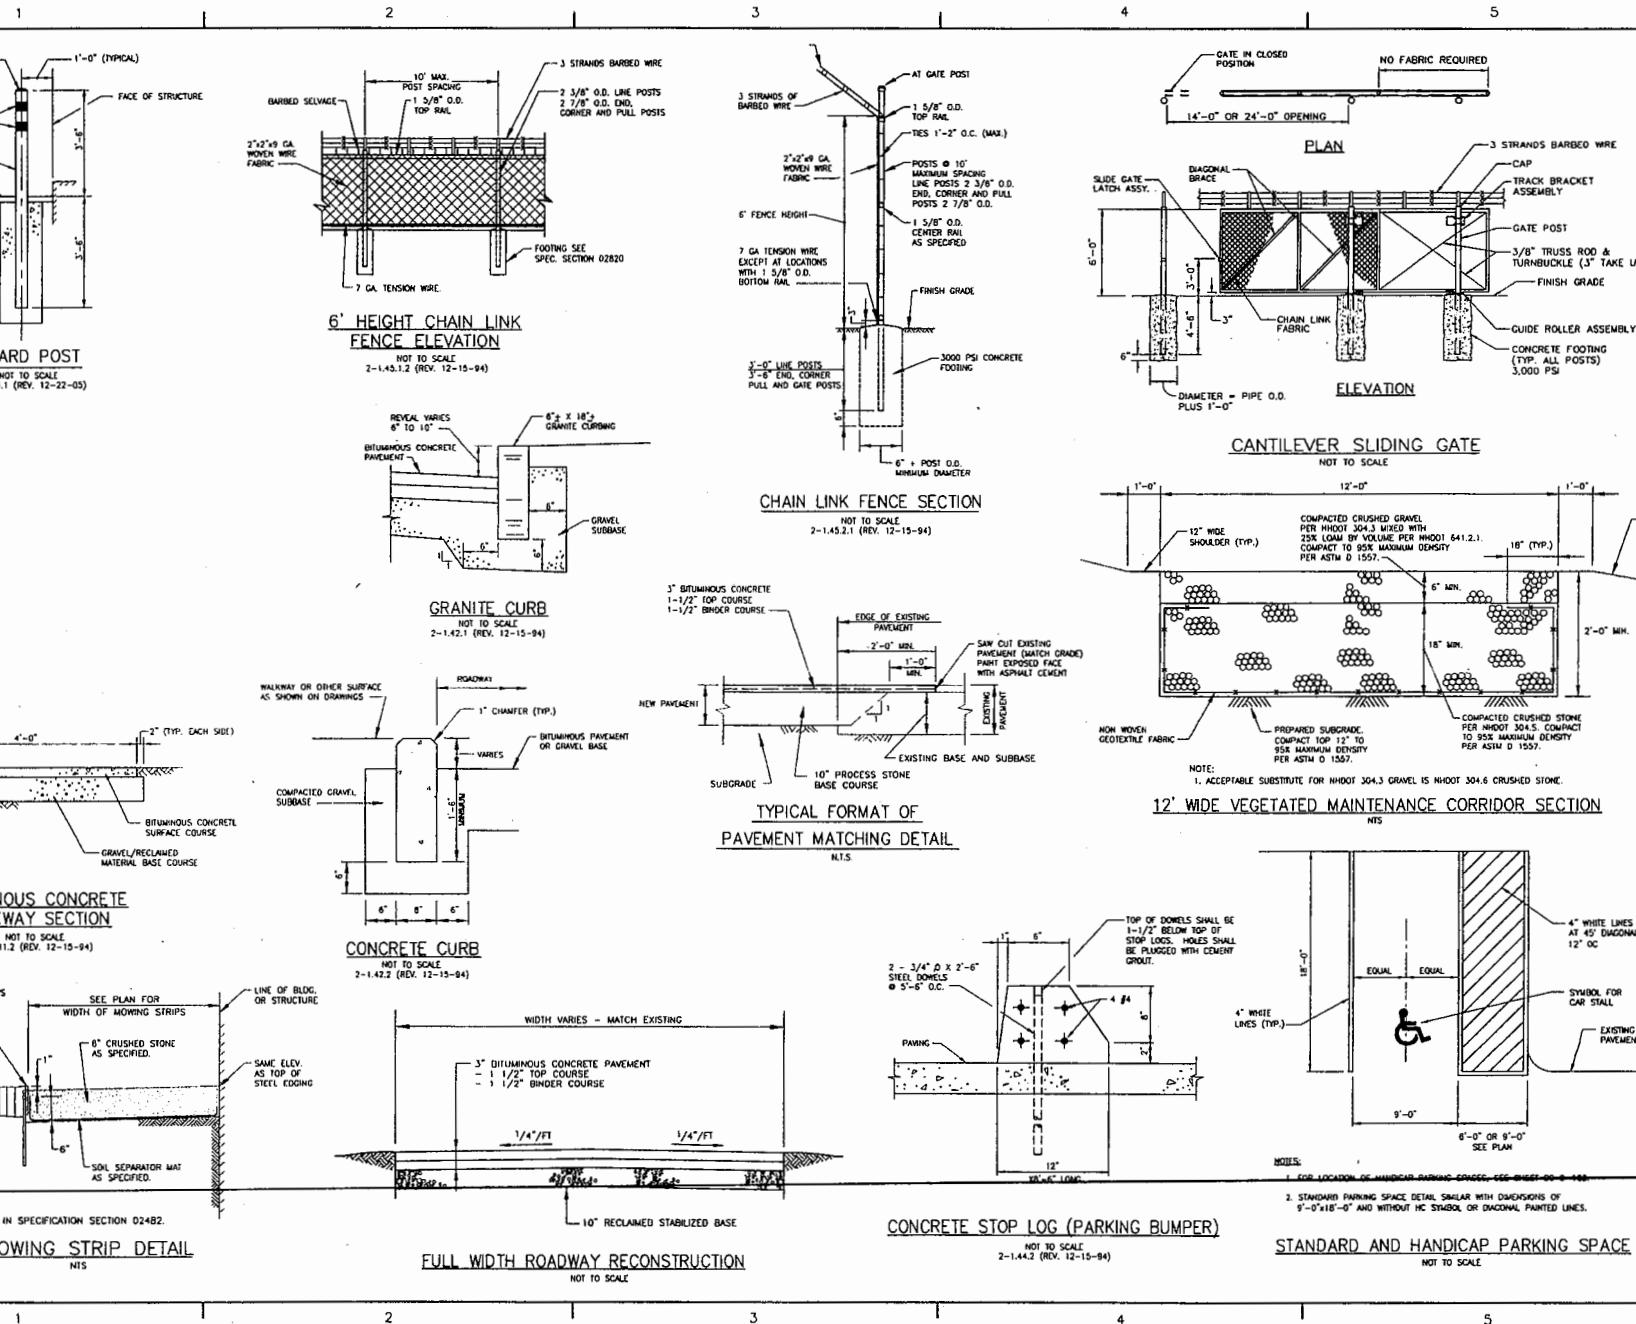



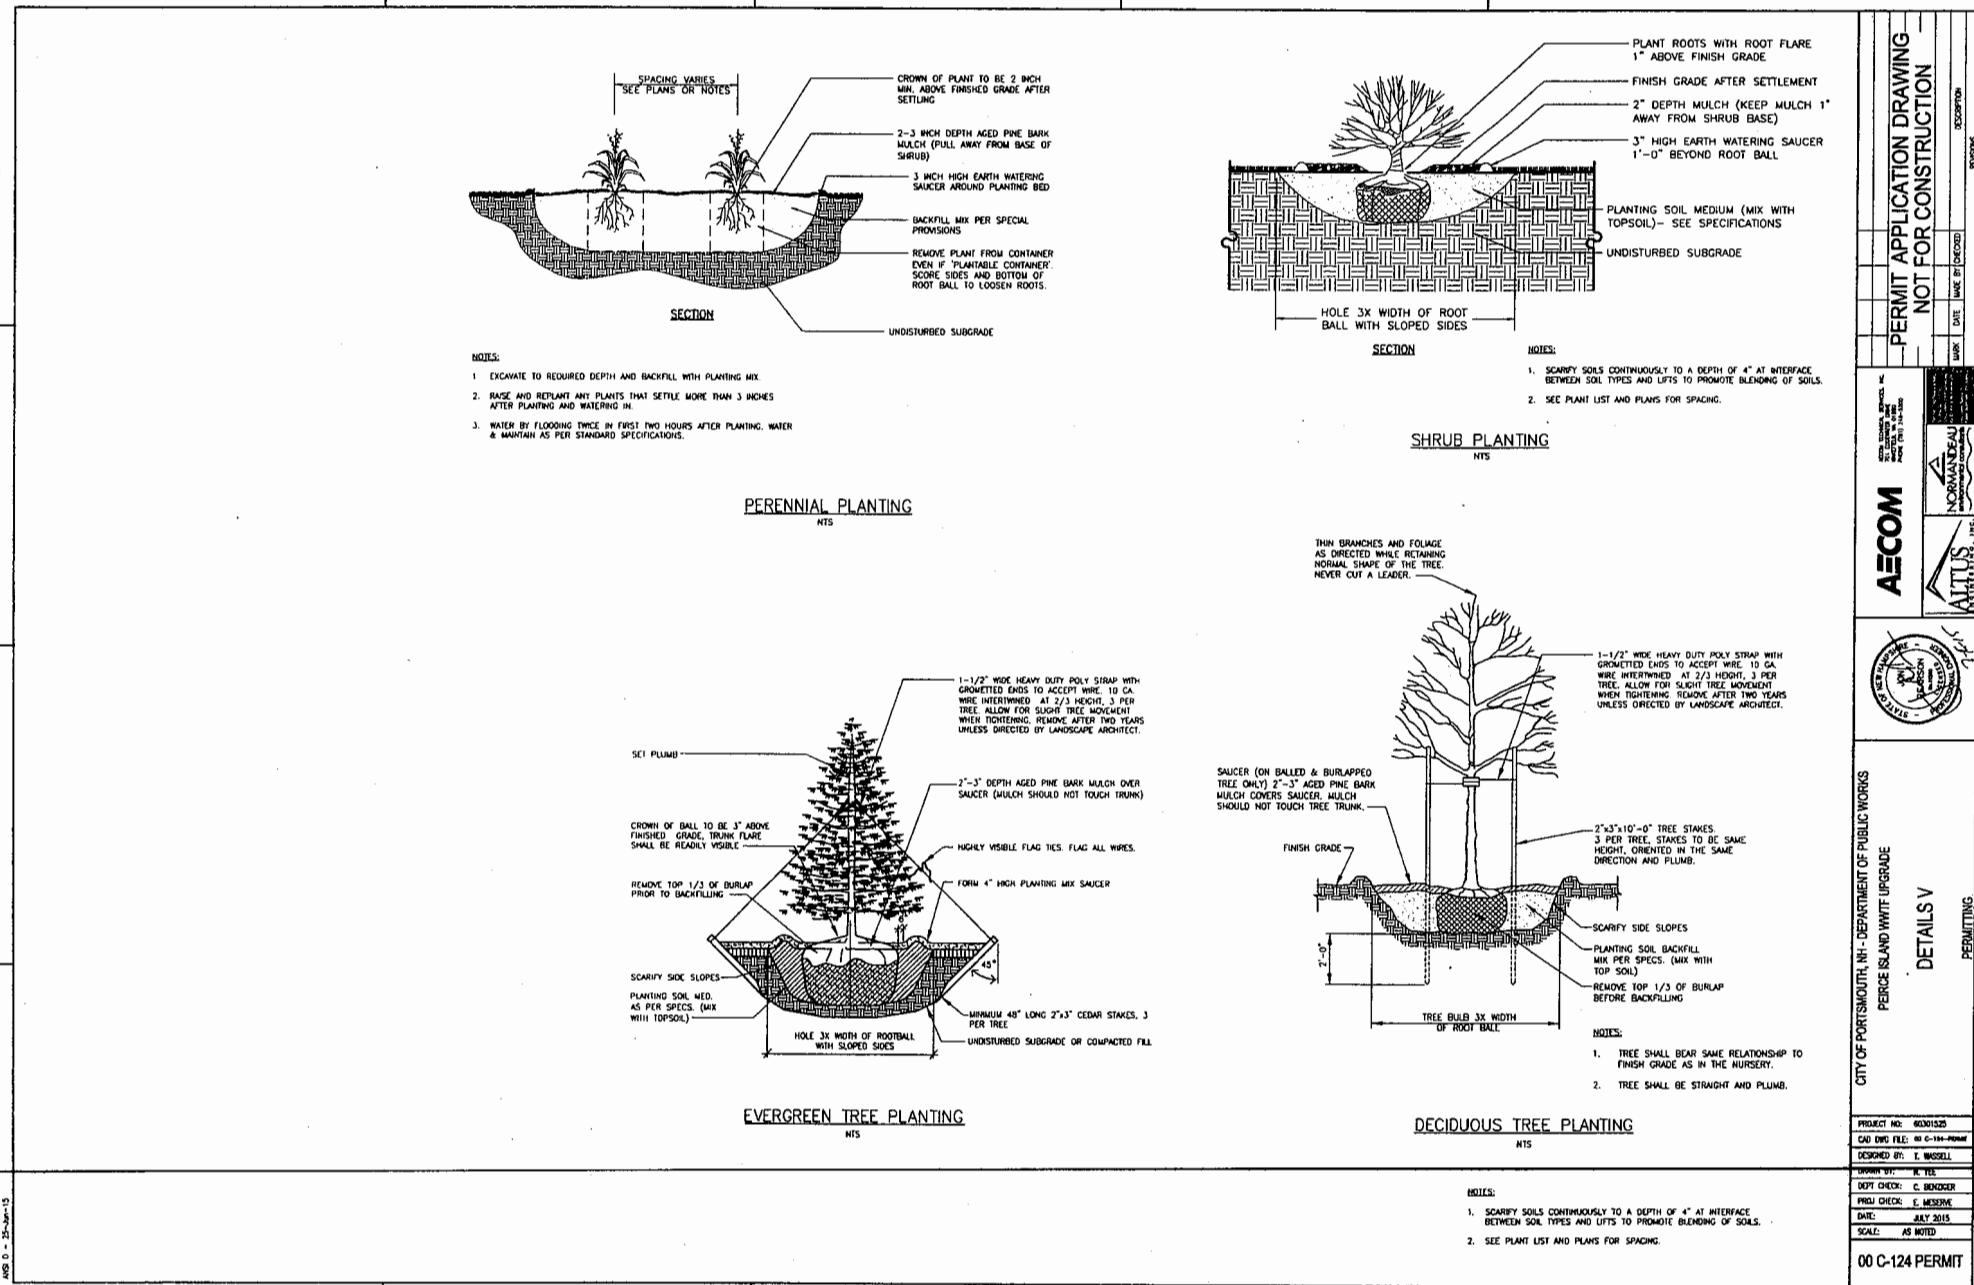



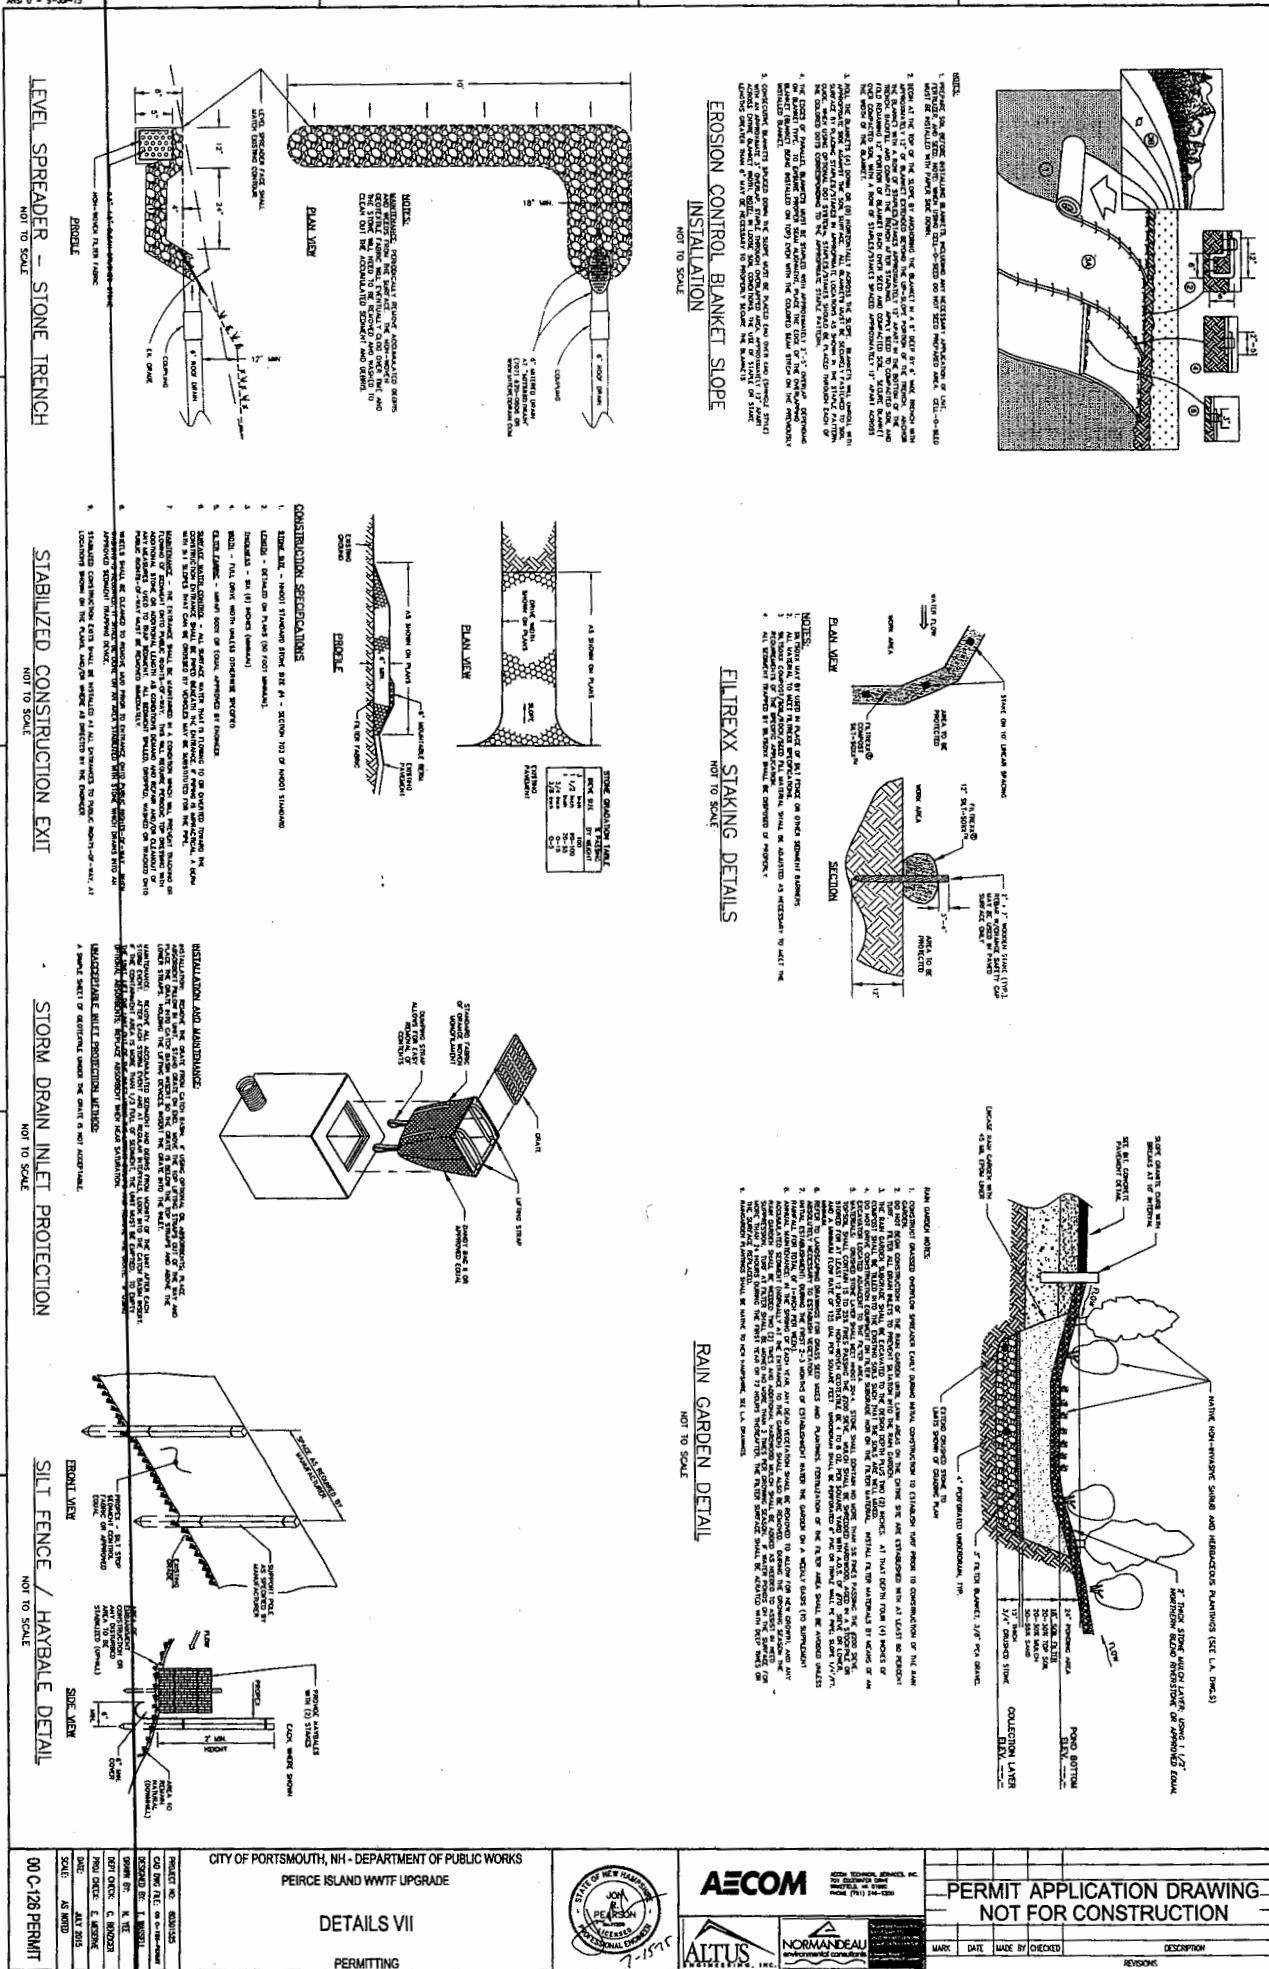





**US Army Corps  
of Engineers®**  
New England District

(Minimum Notice: Permittee must sign and return notification  
within one month of the completion of work.)

## **COMPLIANCE CERTIFICATION FORM**

**Permit Number:** NAE-2015-01928

**Project Manager** Richard Kristoff

**Name of Permittee:** Portsmouth

**Permit Issuance Date:** November 23, 2015

Please sign this certification and return it to the following address upon completion of the activity and any mitigation required by the permit. You must submit this after the mitigation is complete, but not the mitigation monitoring, which requires separate submittals.

\*\*\*\*\*  
\* MAIL TO: U.S. Army Corps of Engineers, New England District \*  
\* Permits and Enforcement Branch C \*  
\* Regulatory Division \*  
\* 696 Virginia Road \*  
\* Concord, Massachusetts 01742-2751 \*  
\*\*\*\*\*

Please note that your permitted activity is subject to a compliance inspection by an U.S. Army Corps of Engineers representative. If you fail to comply with this permit you are subject to permit suspension, modification, or revocation.

**I hereby certify that the work authorized by the above referenced permit was completed in accordance with the terms and conditions of the above referenced permit, and any required mitigation was completed in accordance with the permit conditions.**

---

Signature of Permittee

---

Date

---

Printed Name

---

Date of Work Completion

---

(      )  
Telephone Number

---

(      )  
Telephone Number