DR. ALEX SLOCUM

360 CORPORATE DR. PORTSMOUTH NH 03801

PURISINIUUIT, INTUSOUI				
ACCESSIBILITY NOTES	BUILDING CODES	DRAWING INDEX		9550 W.Higgins Rd. 170 Resement II 60018
VILLAGE ADOPTED ACCESSIBILITY REGULATIONS. 2. ALL THRESHOLDS MUST COMPLY WITH CITY/VILLAGE ADOPTED ACCESSIBILITY REGULATIONS.	APPLICABLE BUILDING CODES INTERNATIONAL BUILDING CODE 2018 (IBC) INTERNATIONAL ENERGY CONSERVATION CODE 2018 (IECC) INTERNATIONAL MECHANICAL CODE 2018 (IMC) INTERNATIONAL PLUMBING CODE 2018 (IPC) INTERNATIONAL RESIDENTIAL CODE 2018 (IRC) INTERNATIONAL RESIDENTIAL CODE 2018 (IRC) INFPA 70™ — NATIONAL ELECTRICAL CODE® 2020 AMENDMENTS "STATE FIRE CODE" AS DEFINED IN NH RSA 153:1 VI-A, WHICH INCLUDES THE ADOPTION BY REFERENCE OF THE LIFE SAFETY CODE NFPA 101 AND THE UNIFORM FIRE CODE NFPA 1, 2018 EDITIONS. 1. FIRE PROTECTION SYSTEM CONTRACTOR SHALL PROVIDE A COMPLETE FIRE SUPPRESSION SYSTEM FROM THE 4" MAIN TO BE THROUGHOUT THE TENANT SPACE. ALL SPRINKLER LINES TO BE IN COMPLIANCE WITH NFPA LOAD FIRE CODES. ALL SPRINKLERS TO HAVE CONCEALED COVER PLATE HEADS FLUSH WITH CEILING TILE. SPRINKLER CONTRACTOR TO SUBMIT COMPLETE SHOP DRAWINGS UNDER SEPARATE SUBMITTAL TO BUILDING AND FIRE DEPT. FOR APPROVAL BY FIRE SUPPRESSION CONTRACTOR. PRIORITY- LTS, DIFFUSERS, RETURNS, EXH., THEN SPRINKLER HEADS, FOR POSITION IN CEILING. 2. FIRE ALARM SYSTEM AN AUTOMATIC AND MANUAL FIRE ALARM SYSTEM IS EXISTING WITHIN THE BUILDING AND SEPARATE PLANS AND SPECIFICATIONS WILL BE PROVIDED FOR PERMITTING OUTSIDE OF THESE DRAWINGS. AN AUTOMATIC SYSTEM SHALL BE INSTALLED AND MAINTAINED IN ACCORDANCE WITH THE PROVISIONS OF THE INTERNATIONAL BUILDING CODE AND NFPA 72 IN ALL BUILDINGS OF GROUPS A, B, E, F, H, I, M, R, S AND U. (AMENDS SEC. 907.2, INTERNATIONAL BUILDING CODE.). A MANUAL FIRE ALARM SYSTEM WILL BE INSTALLED AND MAINTAINED IN THE FOLLOWING OCCUPANCIES REGARDLESS OF THE OCCUPANT LOAD: A, B, E, F, H, I-I, I-2, I-3, M, R-1, R-2, AND S. (AMENDS SECTION 907, INTERNATIONAL FIRE CODE). FA SUB WILL ALSO PROVIDE ALL REQUIRED SMOKE AND CARBON MONOXIDE DETECTOR LOCATIONS.	SHEET NO. G0-0 G0-0 GOVER PAGE GA0-1.0 EXTERIOR RENDERINGS GA0-1.1 EXTERIOR RENDERINGS - SITE DEVELOPMENT PLANS FOR SURGICAL CENTER 1 OF 1 EXISTING CONDITIONS PLAN C-101 SITE PREPARATION PLAN C-103 GRADING & DRAINAGE PLAN C-104 GRADING & DRAINAGE PLAN C-105 TRUCK TURNING PLAN C-501 DETAILS C-502 DETAILS C-503 DETAILS L-501 L-401 LANDSCAPE PLAN L-501 L-501 LANDSCAPE NOTES L-501 L-501 L-501 LANDSCAPE NOTES A1-2 EXTERIOR SCHEDULES A1-4.1 OVERALL EXTERIOR ELEVATIONS A1-3 EXTERIOR ELEVATIONS A1-4 EXTERIOR ELEVATIONS	APPLICANT: APEX DESIGN BUILD 9550 W.HIGGINS RD. 170 ROSEMONT, IL 60018 OWNER: PEASE DEVELOPMENT AUTHORITY 360 CORPORATE DRIVE PORTSMOUTH, NH 03801 ARCHITECT: CIVIL ENGINEER / LANDSCAPE ARCHITECT: ALLEN & MAJOR ASSOCIATES, INC. 400 HARVEY ROAD MANCHESTER, NH 03103 (603) 627-5500 SURVEYOR: DOUCET SURVEY LLC 102 KENT PLACE NEWMARKET, NH 03857 UTILITY PROVIDERS: NATURAL GAS: UNITIL CORP. ELECTRIC: EVERSOURCE TELEPHONE: CONSOLIDATED COMMUNICATIONS	DR. ALEX SLOCUM 360 CORPORATE DR. PORTSMOUTH, NH 03801 SEAL: DISCLAIMER: All drawings are proprietary and the exclusive property of our company. This/These print(s) shall not be shared, copied or reproduced without expressed permission of our company. This print is loaned in confidence and subject to return upon request by our company. No. Description Date
DRAFTING SYMBOLS		LOCATION MAP	PROJECT RENDERING	

DETAIL TITLE DESIGNATION SECTION CUT DETAIL DESIGNATION SHEET NUMBER. WHERE DRAWING IS LOCATED **ELEVATION DETAIL DESIGNATION** - SECTION NO. DESIGNATION - SHEET NUMBER. WHERE DRAWING IS LOCATED CALLOUT DETAIL DESIGNATION

SHEET NUMBER. WHERE DRAWING IS LOCATED


A1.0

NORTH ARROW SPOT ELEVATION MARK WALL TYPE DESIGNATION WINDOW TYPE DESIGNATION KEY NOTE TAG XX FINISH TAG **REVISION TAG**

(DENOTATES SOMETHING LOCATED BELOW OR BEHIND)


(DENOTATES SOMETHING

LOCATED ABOVE OR IN FRONT)

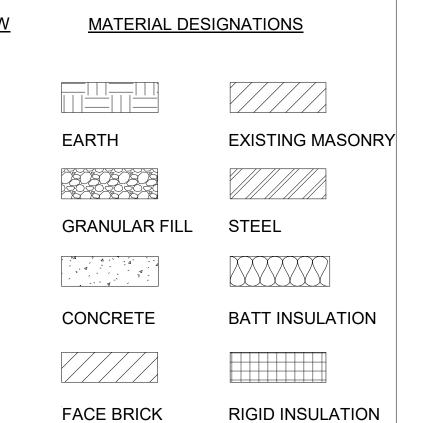

C.M.U.

GYPSUM BOARD

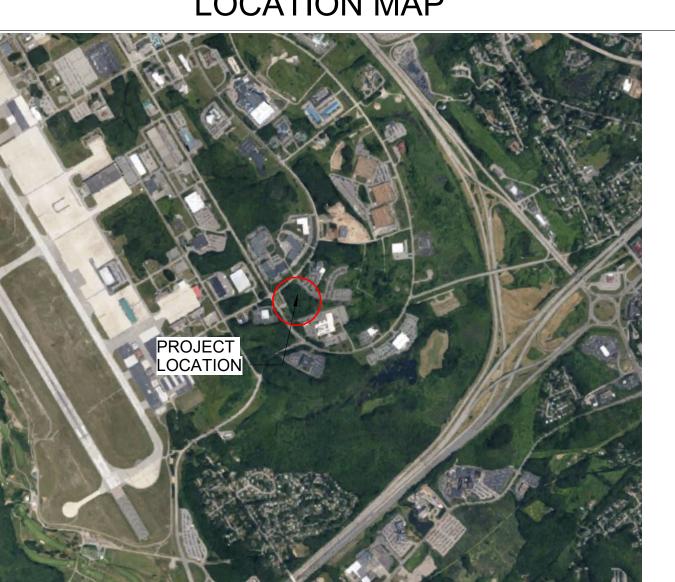



	Boodilpaon	Date

COVER PAGE





CIPEX DESIGN > BUILD

9550 W.Higgins Rd. 170 Rosemont, IL 60018

DR. ALEX SLOCUM

360 CORPORATE DR. PORTSMOUTH , NH 03801

SEA

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EXTERIOR RENDERINGS

Project number

GA0-1.0

Scale







9550 W.Higgins Rd. 170 Rosemont, IL 60018

DR. ALEX SLOCUM

360 CORPORATE DR. PORTSMOUTH , NH 03801

CLIENT APPROVAL

APPROVED AS SHOWN

☐ APPROVED WITH CHANGES

I UNDERSTAND ANY CHANGES HEREIN WILL RESULT IN ADDITIONAL COSTS AND TIME EXTENSIONS

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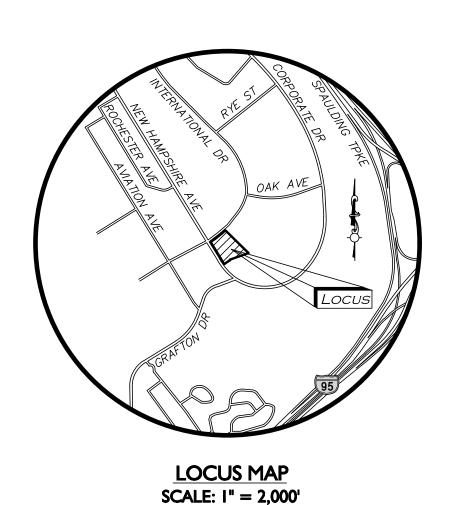
EXTERIOR RENDERINGS

Project number

GA0-1.1

Scale

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APPLICANT: APEX DESIGN BUILD 9550 W. HIGGINS ROAD. SUITE 170 ROSEMONT, IL 60018

OWNER:
PEASE DEVELOPMENT AUTHORITY
360 CORPORATE DRIVE
PORTSMOUTH, NH 03801

ARCHITECT:

CIVIL ENGINEER / LANDSCAPE ARCHITECT ALLEN & MAJOR ASSOCIATES, INC. 400 HARVEY ROAD MANCHESTER, NH 03103 (603) 627-5500

SURVEYOR: DOUCET SURVEY LLC 102 KENT PLACE NEWMARKET, NH 03857


UTILITY PROVIDERS:

NATURAL GAS: UNITIL CORP. ELECTRIC: EVERSOURCE

TELEPHONE: CONSOLIDATED COMMUNICATIONS

SITE DEVELOPMENT PLANS FOR SURGICAL CENTER

360 CORPORATE DRIVE
TAX MAP 315, LOT 5
PORTSMOUTH, NH 03801

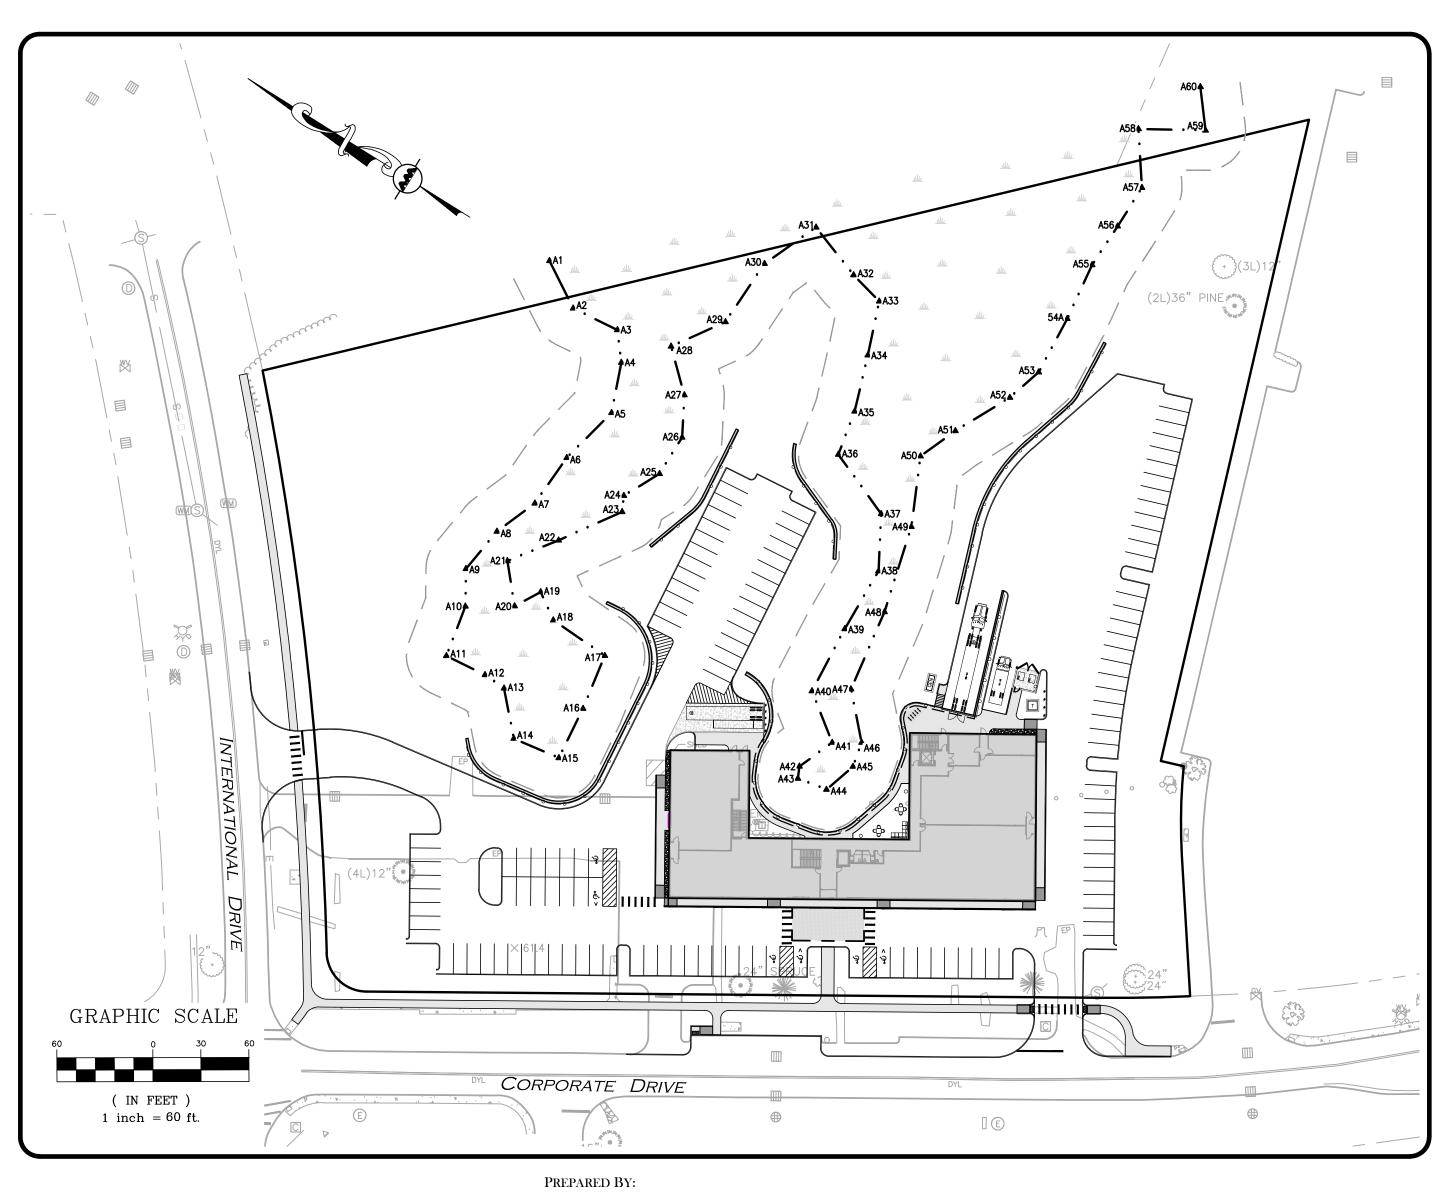

LIST OF D	PRAWING	iS	
DRAWING TITLE	SHEET NO.	ISSUED	REV 1
EXISTING CONDITIONS PLAN	1 OF 1	TBD	-
SITE SPECIFIC SOIL MAPPING	C-100	TBD	-
SITE PREPARATION PLAN	C-101	TBD	-
LAYOUT & MATERIALS PLAN	C-102	TBD	-
GRADING & DRAINAGE PLAN	C-103	TBD	-
UTILITIES PLAN & SEWER PROFILE	C-104	TBD	-
TRUCK TURNING PLAN	C-105	TBD	-
DETAILS	C-501	TBD	-
DETAILS	C-502	TBD	-
DETAILS	C-503	TBD	-
DETAILS	C-504	TBD	-
DETAILS	C-505	TBD	-
LANDSCAPE PLAN	L-101	TBD	-
LANDSCAPE NOTES	L-102	TBD	-
LANDSCAPE DETAILS	L-501	TBD	-
DANDSCAPE DETAILS	1-301	IBU	

PROGRESS PRINT ISSUED FOR REVIEW JULY 24, 2023

PROFESSIONAL ENGINEER FOR ALLEN & MAJOR ASSOCIATES, INC.

FOR MORE INFORMATION ABOUT THIS PLAN SET, CONTACT: BRIAN D. JONES AT ALLEN & MAJOR ASSC., INC. 603-627-5500




WOBURN, MA ◆ LAKEVILLE, MA ◆ MANCHESTER, NH


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FAX: (603) 627-5501

PROGRESS PRINT: JULY 24, 2023





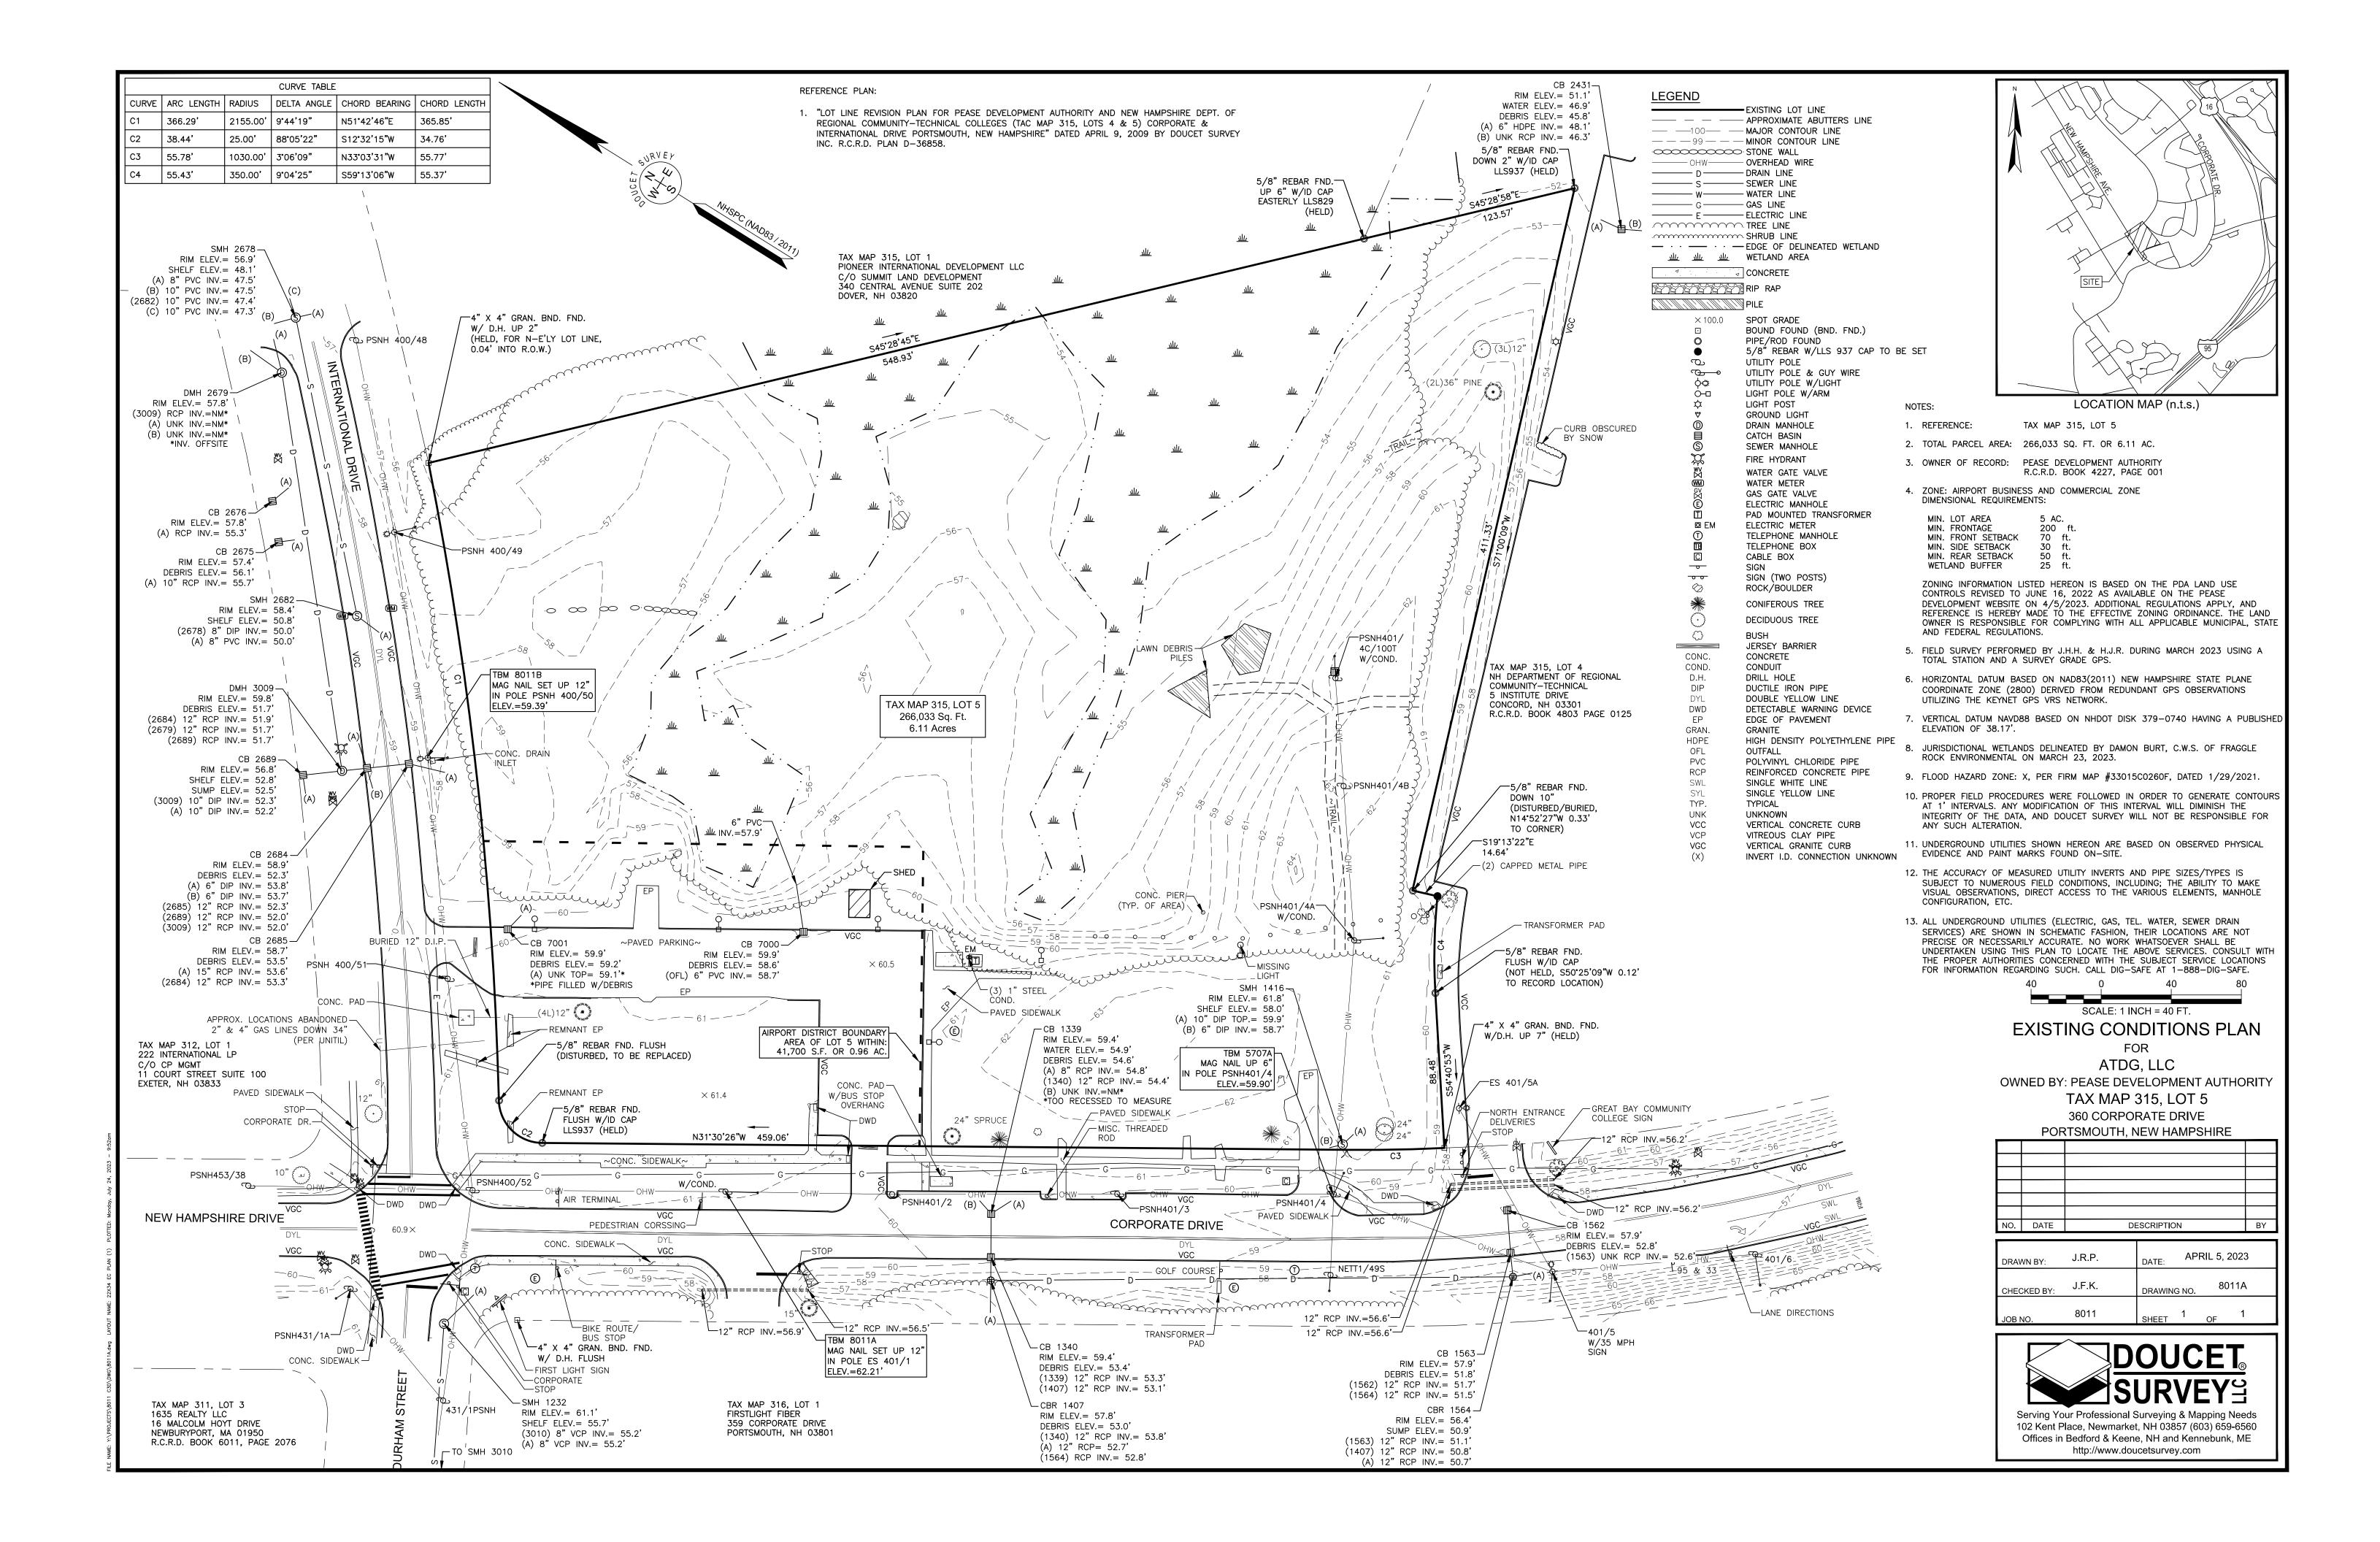
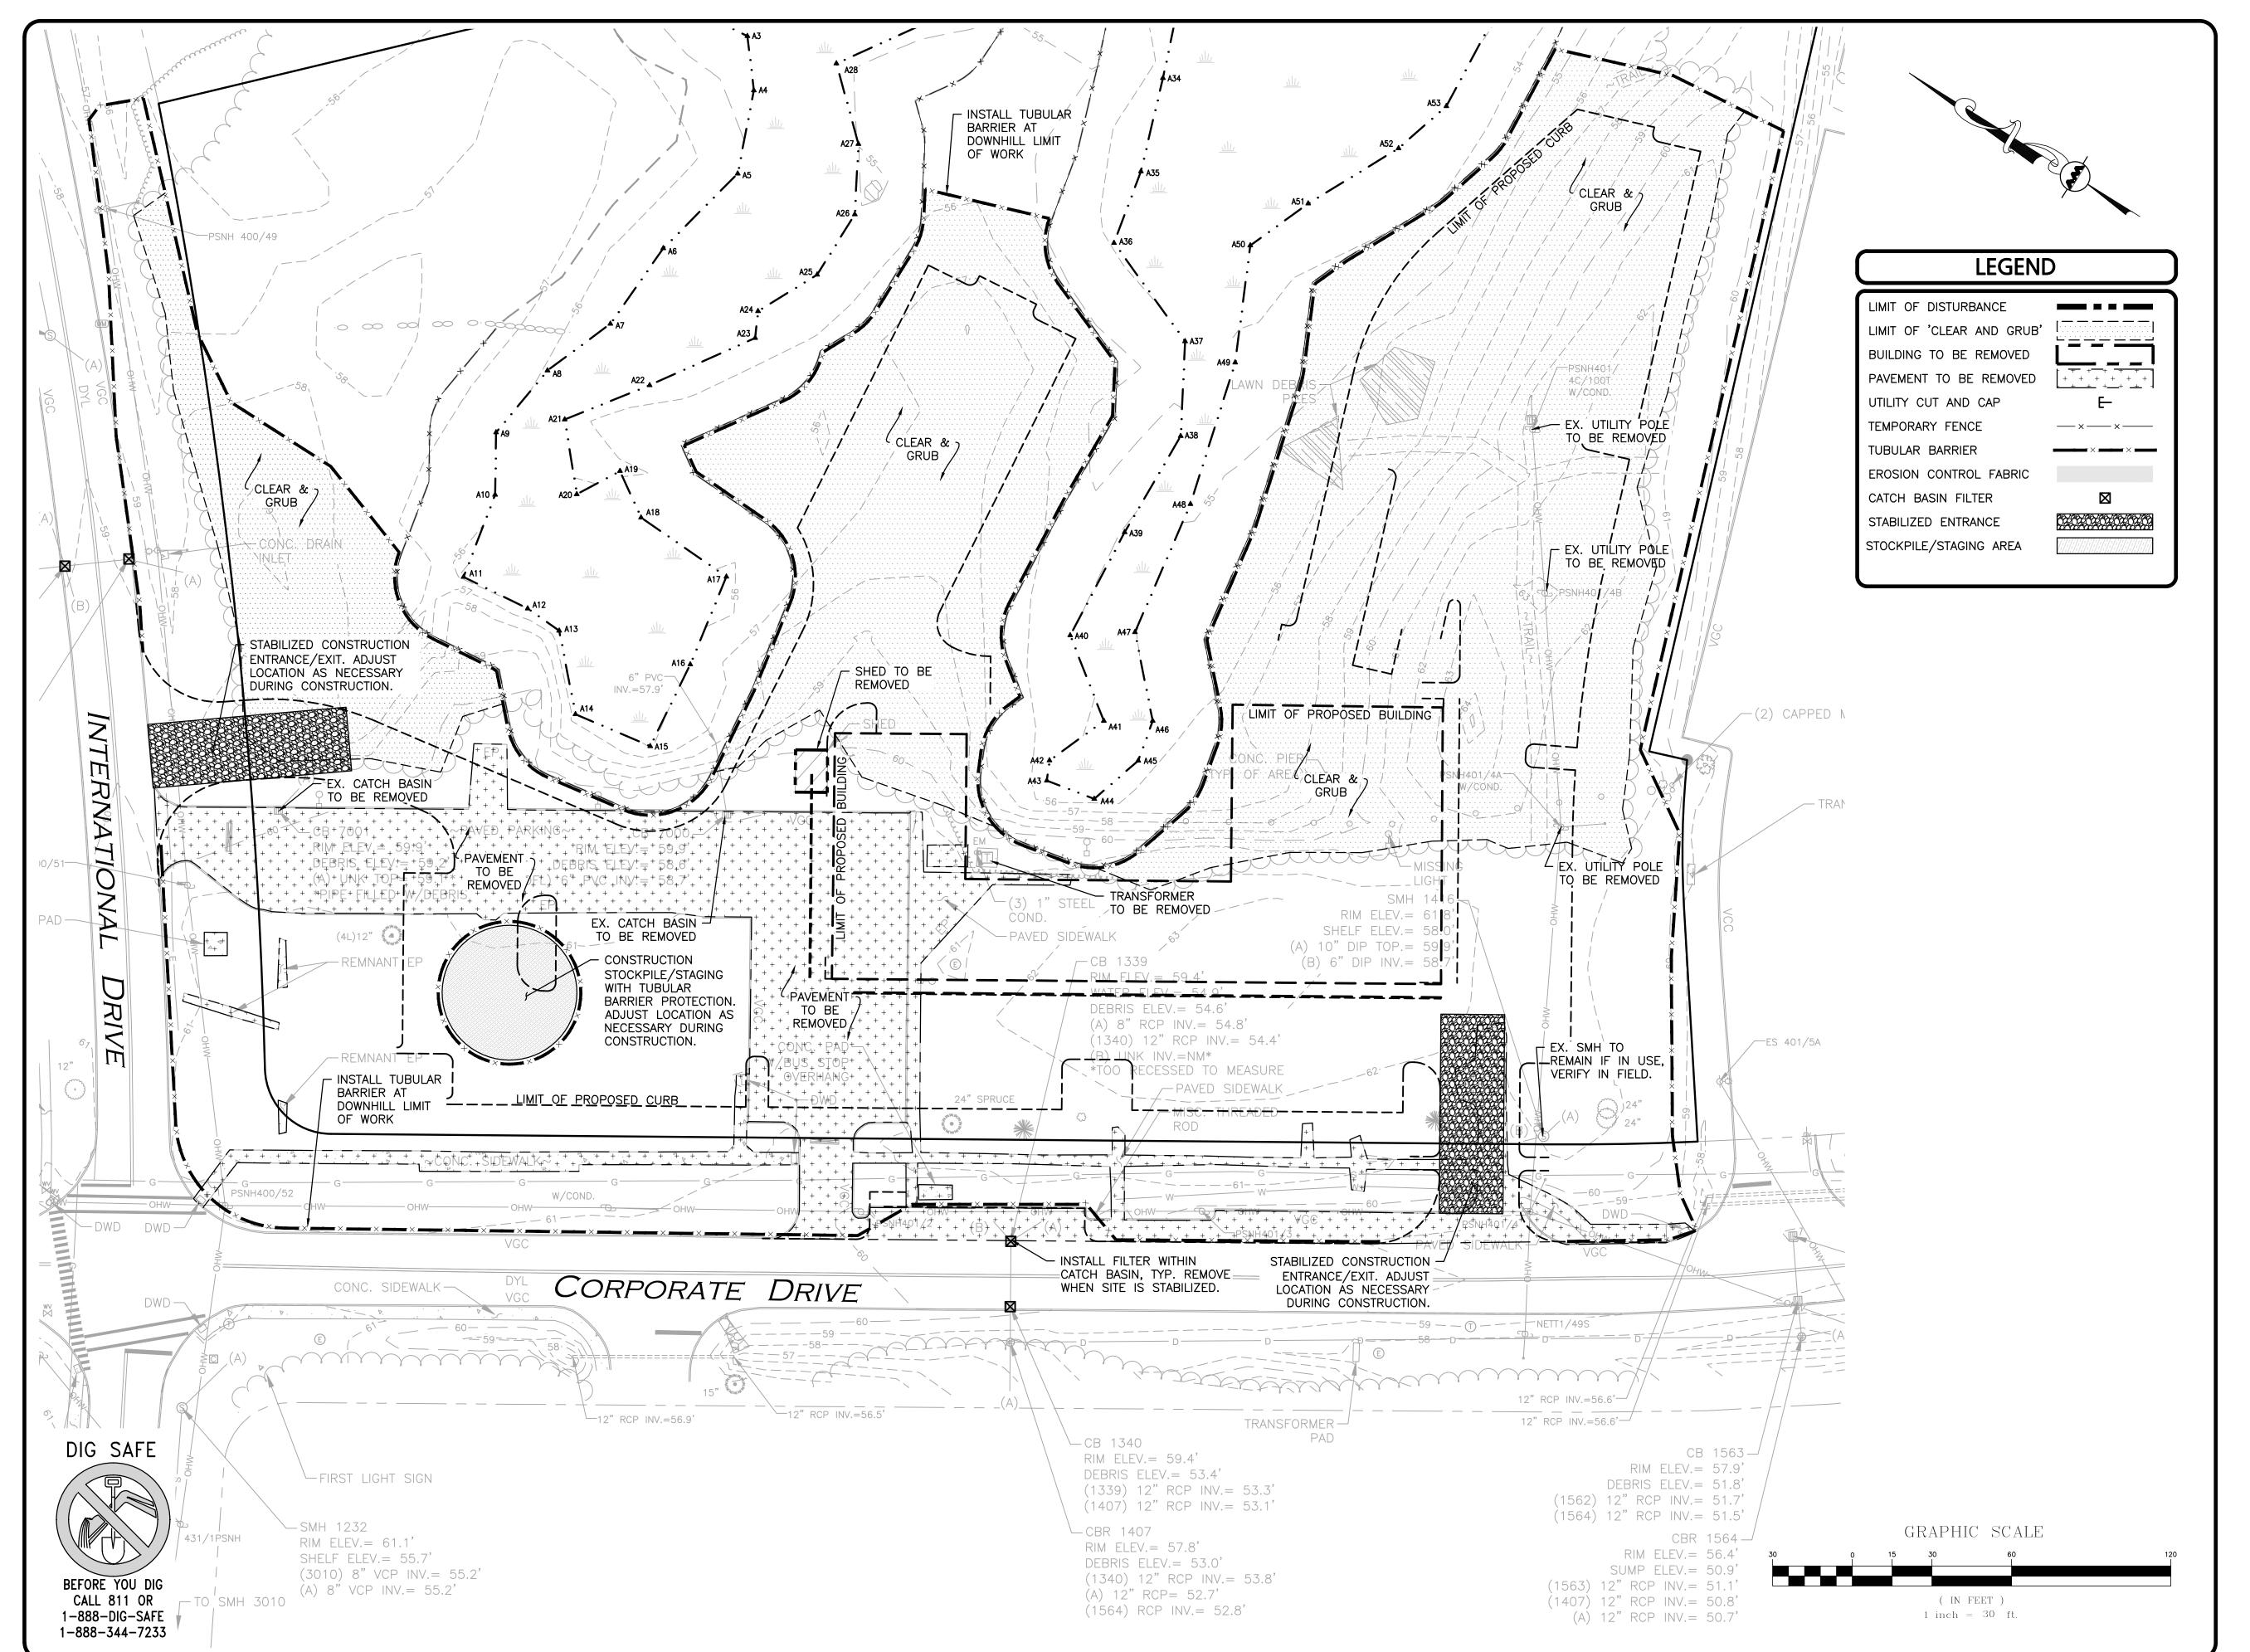
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REV DATE DESCRIPTION

APPICANT:

APEX DESIGN BUILD 9550 W. HIGGINS ROAD. SUITE 170 ROSEMONT, IL 60018

PROJE

SURGICAL CENTER
360 CORPORATE DRIVE
TAX MAP 315, LOT 5
PORTSMOUTH, NH 03801

PROJECT NO. 3250-01 DATE: 07-24-23

SCALE: 1" = 30' DWG. NAME: C-3250-01.dwg

DESIGNED BY: BDJ CHECKED BY:

PREPARED BY:



ASSOCIATES, INC.

nvironmental consulting • landscape architecture
w w w . a l l e n m a j o r . c o m

400 HARVEY ROAD

MANCHESTER, NH 03103

TEL: (603) 627-5500

FAX: (603) 627-5501

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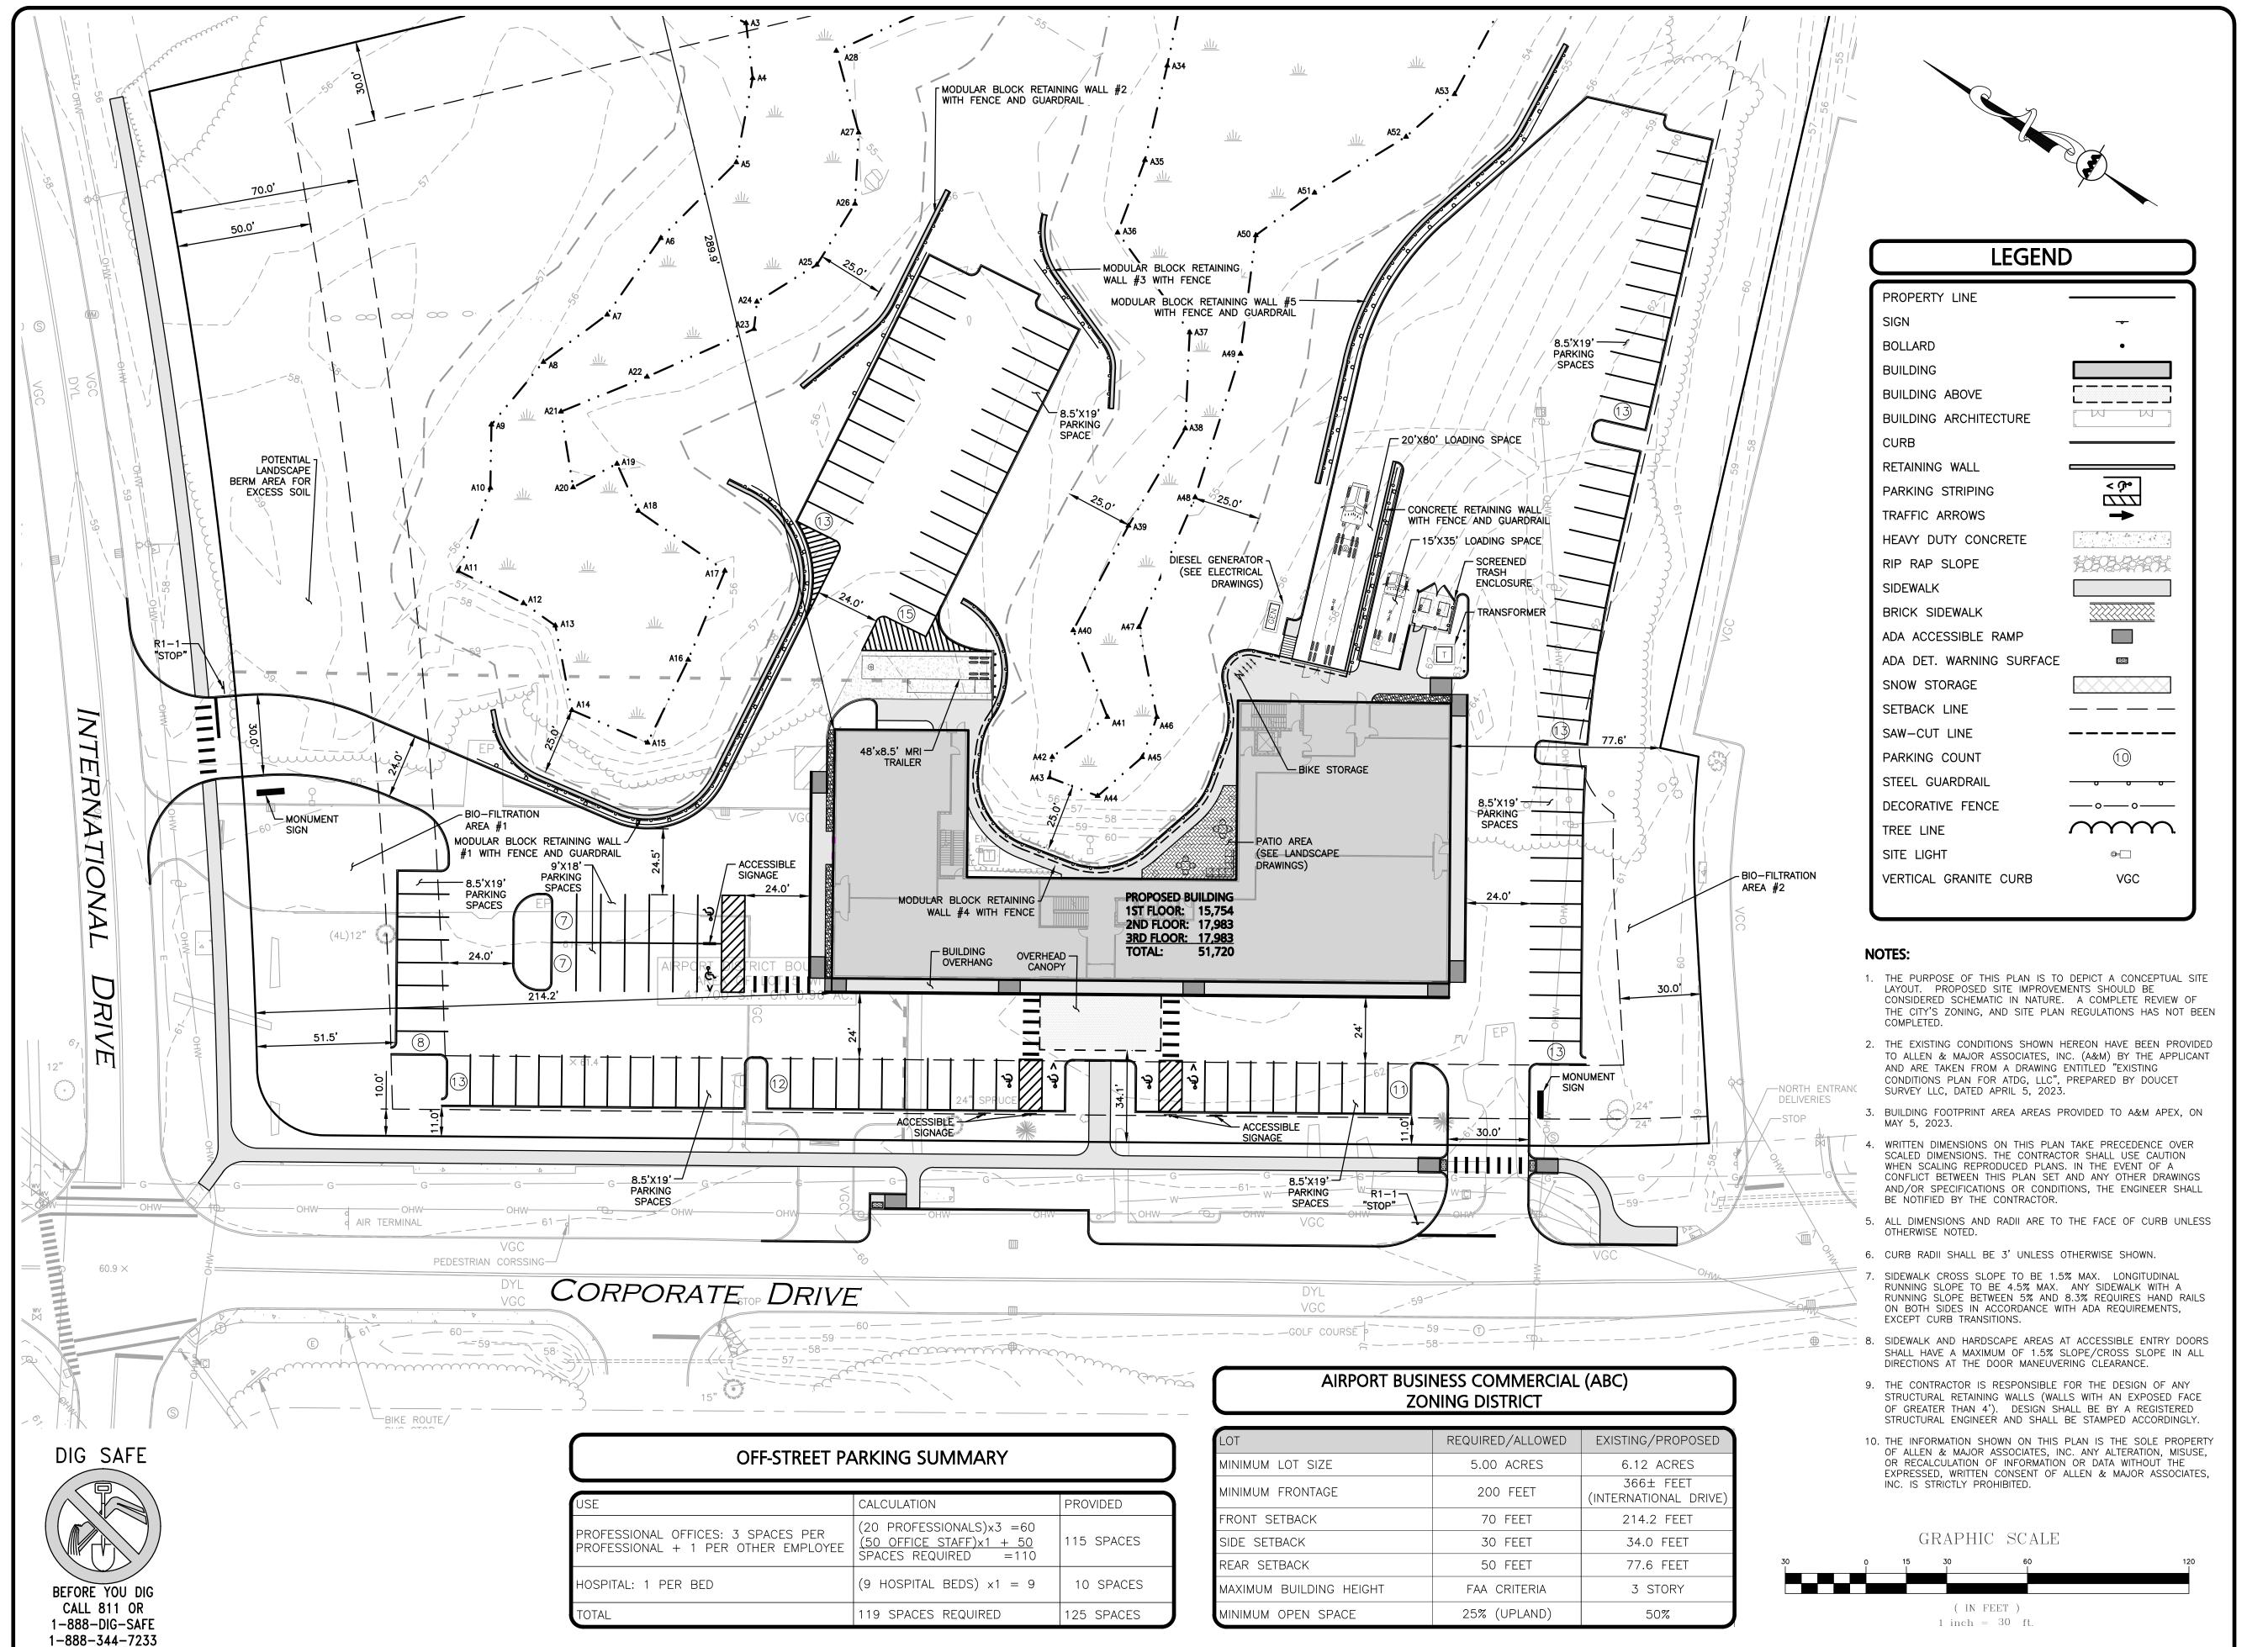
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SHEET No.

SITE PREPARATION PLAN C-101

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360 CORPORATE DRIVE
TAX MAP 315, LOT 5
PORTSMOUTH, NH 03801

PROJECT NO. 3250-01 DATE: 07-24-23

SCALE: 1" = 30' DWG. NAME: C-3250-01.dwg

DESIGNED BY: BDJ CHECKED BY: RPG

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SHEET No.

C-102

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DRAWING TITLE:

LAYOUT & MATERIALS
PLAN

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R:\PROJECTS\3250-01\CIVIL\DRAWINGS\CURRENT\C-3250-01 LAYOUT & MATERIALS



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PROJE

SURGICAL CENTER
360 CORPORATE DRIVE
TAX MAP 315, LOT 5
PORTSMOUTH, NH 03801

PROJECT NO. 3250-01 DATE: 07-24-23

SCALE: 1" = 30' DWG. NAME: C-3250-01.dwg

DESIGNED BY: BDJ CHECKED BY:



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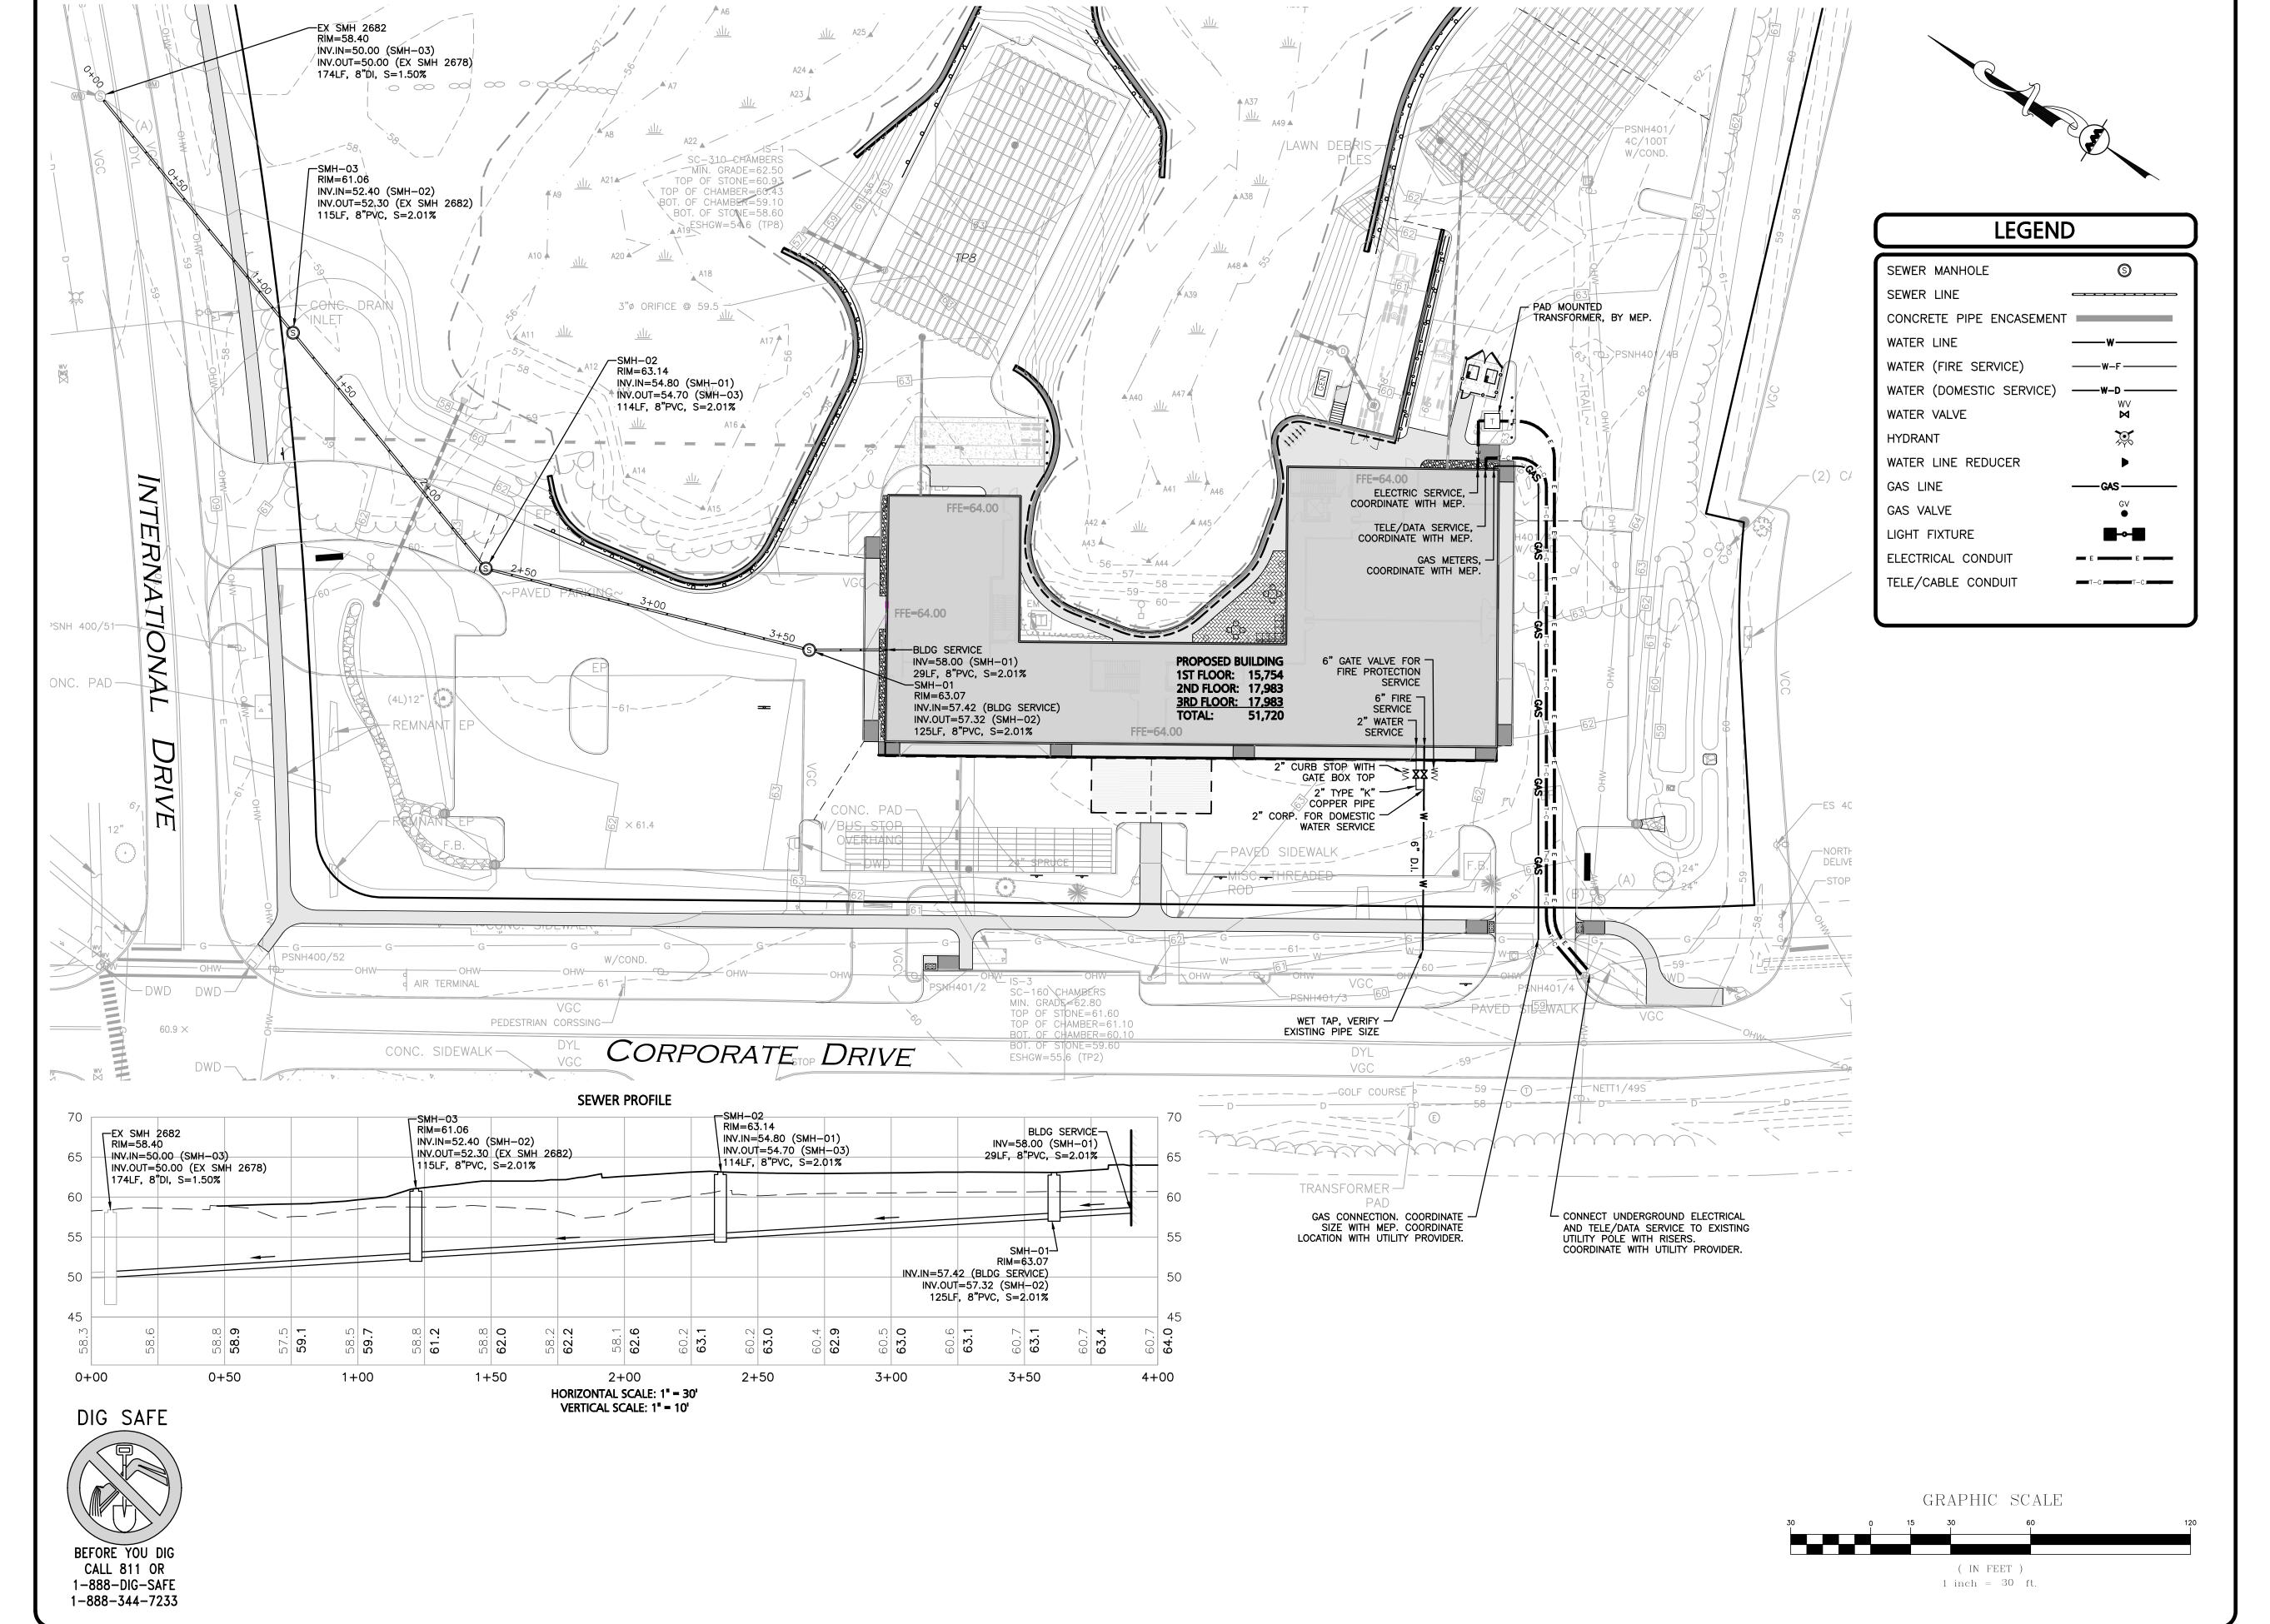
GRADING & DRAINAGE PLAN

R:\PROJECTS\3250-01\CIVIL\DRAWINGS\CURRENT\C-3250-01_GRADING & DRAINAC

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AINAGE C-103

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PROJE

SURGICAL CENTER
360 CORPORATE DRIVE
TAX MAP 315, LOT 5
PORTSMOUTH, NH 03801

PROJECT NO. 3250-01 DATE: 07-24-23

SCALE: 1" = 30' DWG. NAME: C-3250-01.dwg

DESIGNED BY:

DE



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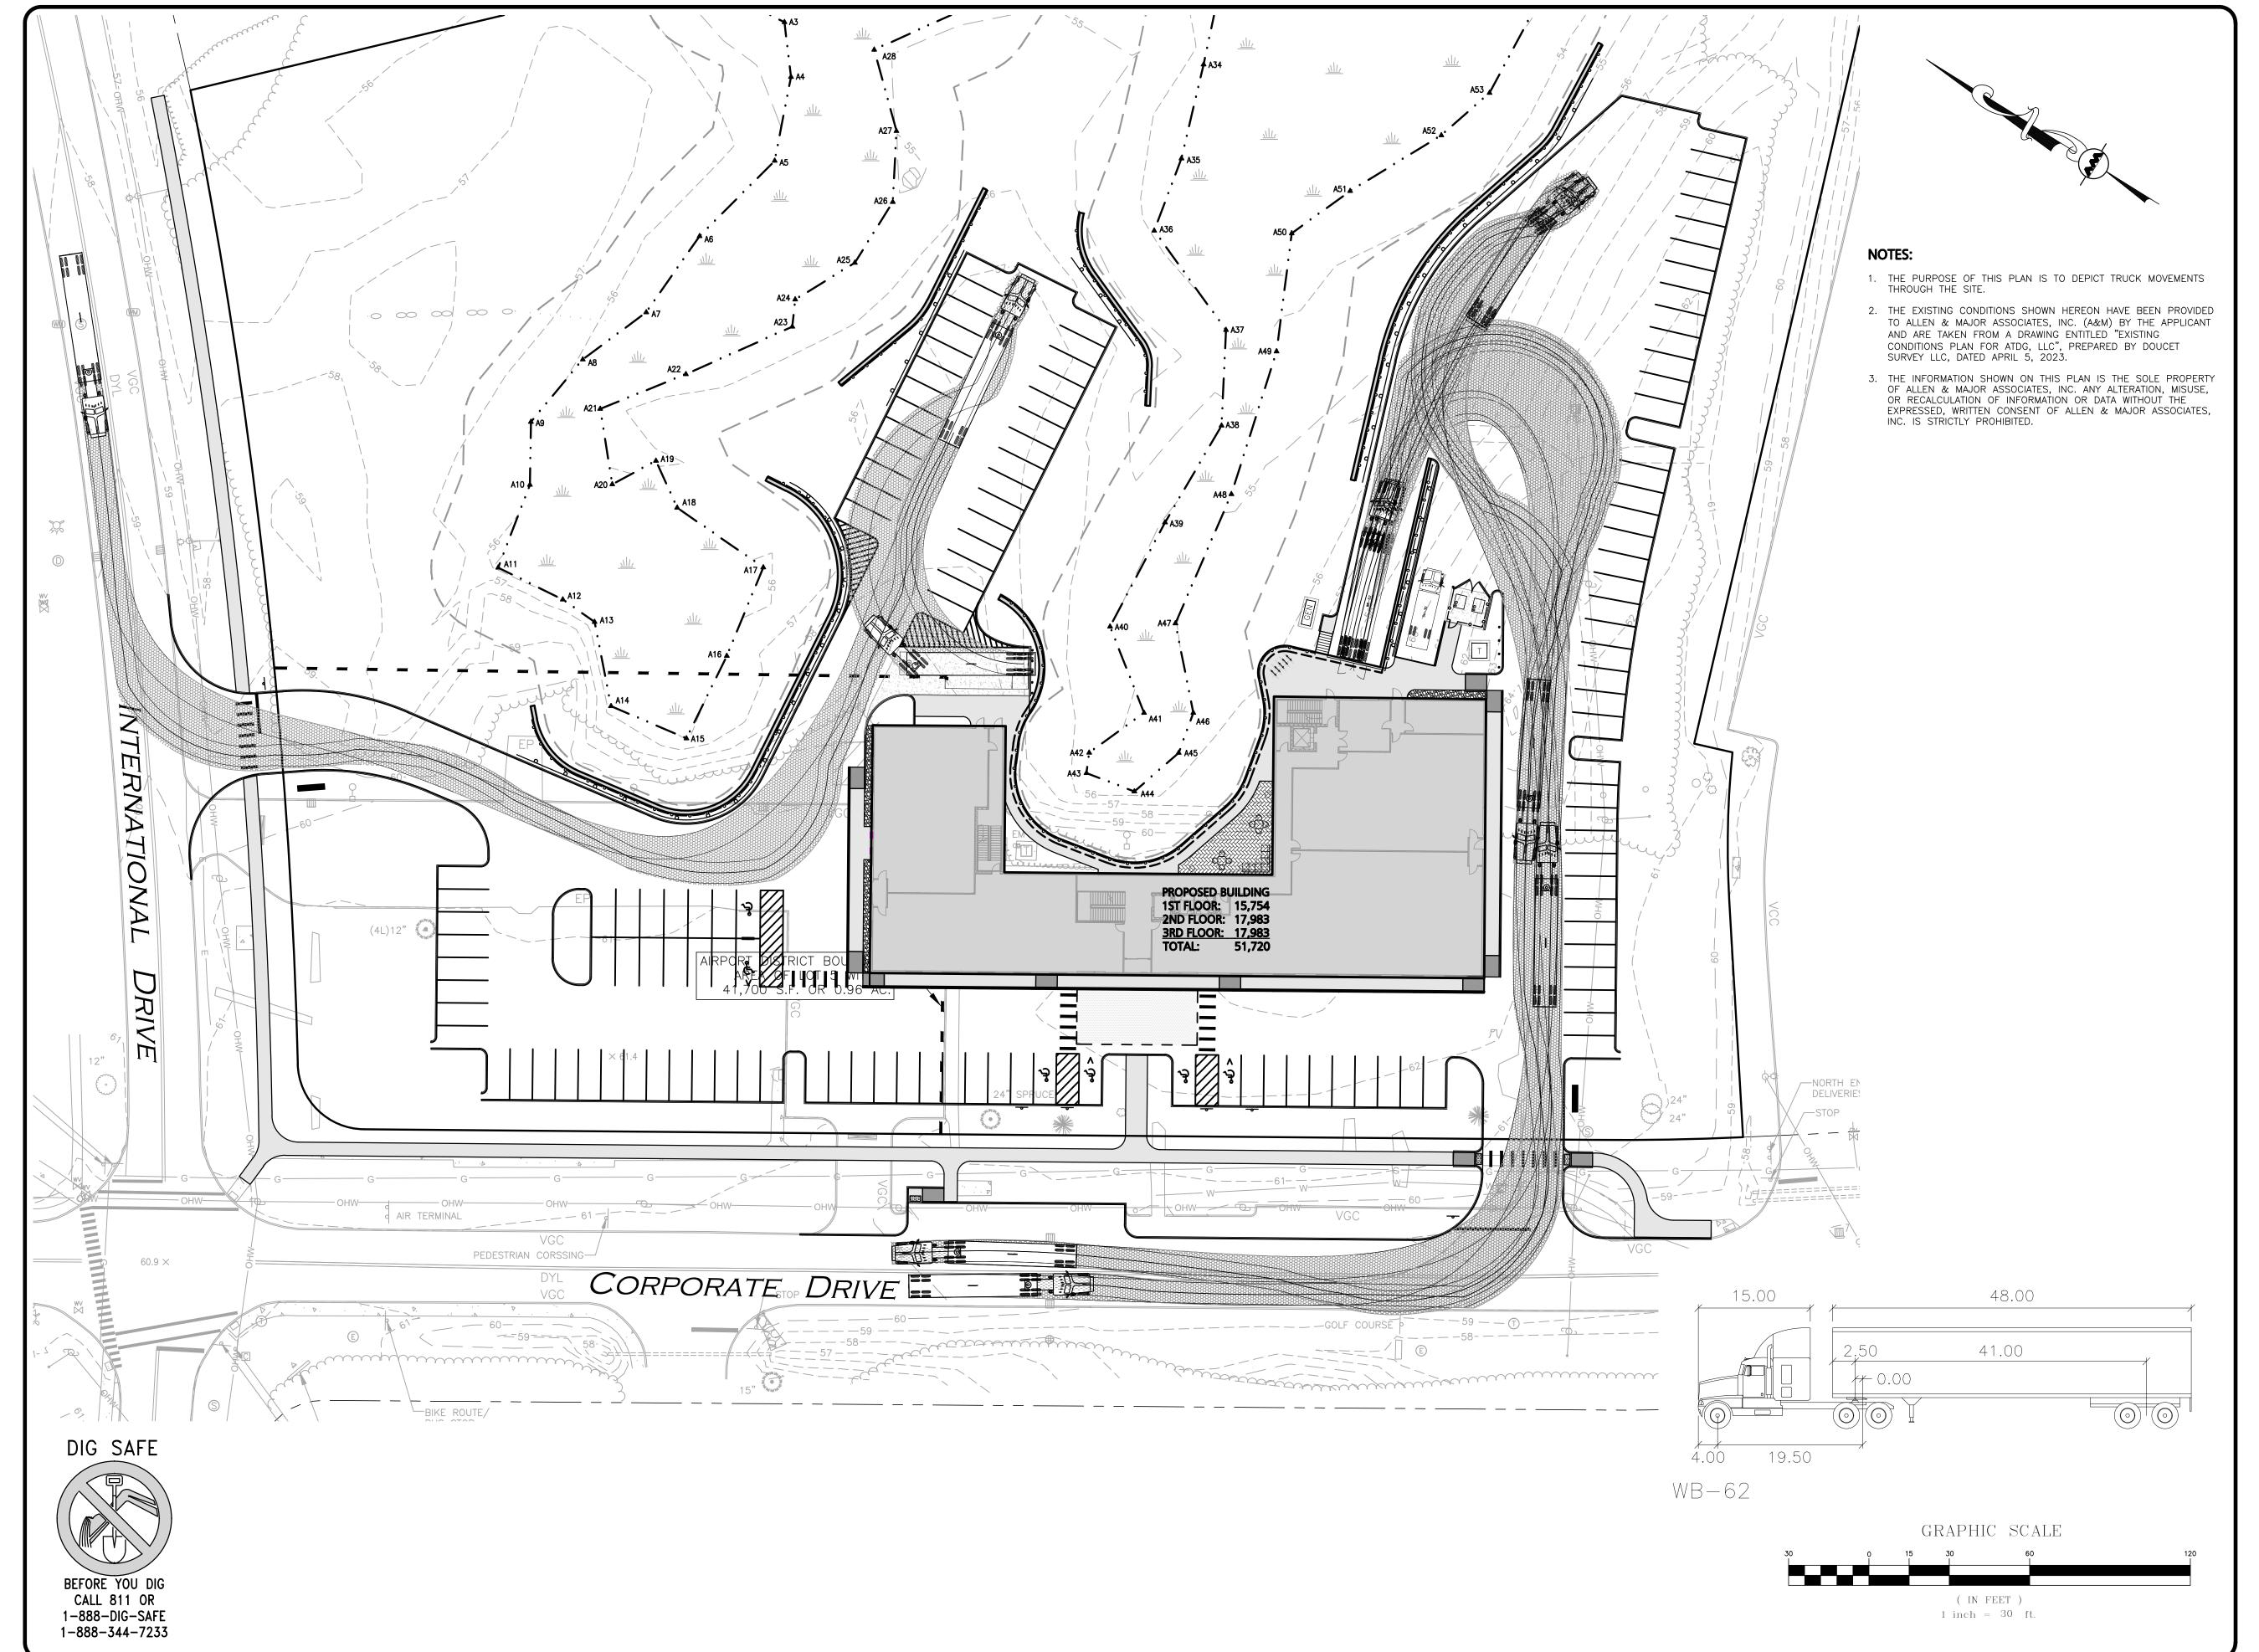
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SHEET No. C-104

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UTILITIES PLAN &

SEWER PROFILE





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APEX DESIGN BUILD 9550 W. HIGGINS ROAD. SUITE 170 ROSEMONT, IL 60018

DESIGNED BY:

SURGICAL CENTER 360 CORPORATE DRIVE **TAX MAP 315, LOT 5** PORTSMOUTH, NH 03801

3250-01 DATE: 07-24-23 PROJECT NO.

BDJ CHECKED BY:

1" = 30' DWG. NAME: C-3250-01.dwg

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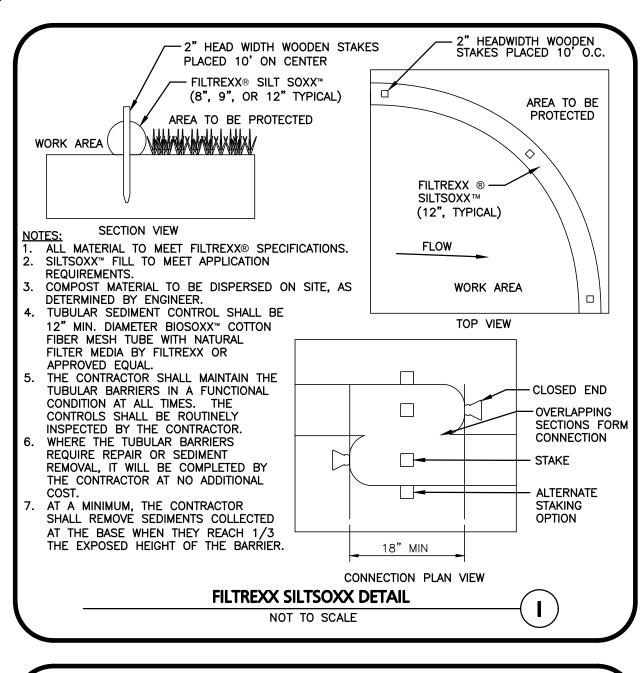
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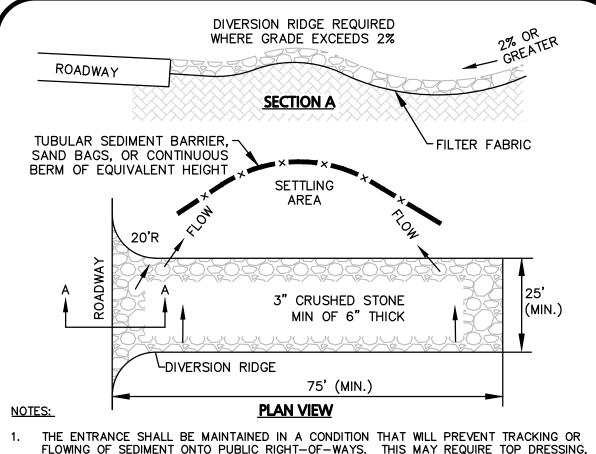
DRAWING TITLE:

SHEET No. C-105

TRUCK TURNING PLAN

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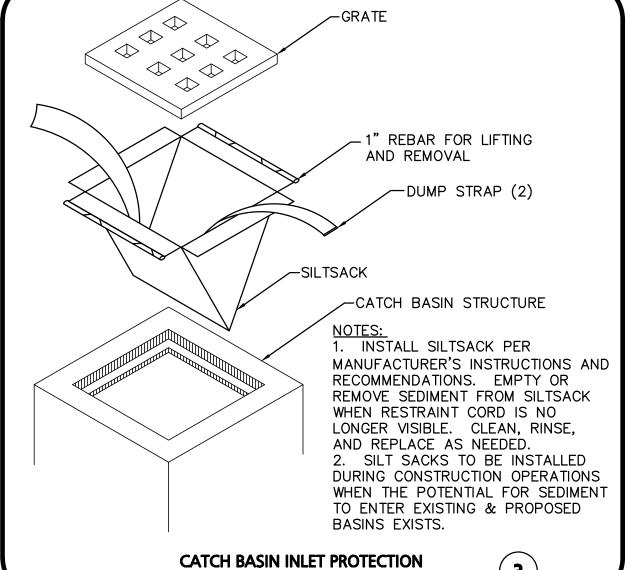




FLOWING OF SEDIMENT ONTO PUBLIC RIGHT-OF-WAYS. THIS MAY REQUIRE TOP DRESSING, REPAIR AND/OR CLEANOUT OF ANY MEASURES USED TO TRAP SEDIMENT.

WHEN WASHING IS REQUIRED, IT SHALL BE DONE ON AN AREA STABILIZED WITH CRUSHED STONE THAT DRAINS INTO AN APPROVED SEDIMENT TRAP OR SEDIMENT BASIN.

WHEN NECESSARY, WHEELS SHALL BE CLEANED PRIOR TO ENTERING THE PUBLIC STABILIZED CONSTRUCTION ENTRANCE NOT TO SCALE




EROSION CONTROL BARRIER (HAYBALES AND SILT FENCE ___ECB__ OR TUBULAR SEDIMENT CONTROL) INSTALLED DOWN SLÓPE OF PROPOSED STOCKPILE AREA PROPOSED STOCKPILE AREA PROVIDE DRAIN — SWALE TO DIRECT WATER AWAY FROM PROPOSED STOCKPILE AREA 1. SOIL AND FILL STOCKPILES EXPECTED TO REMAIN IN PLACE FOR LESS

THAN 90 DAYS SHALL BE COVERED WITH HAY AND MULCH (AT 100LBS/1,000 SF), OR WITH AN ANCHORED TARP WITHIN 7 DAYS OR PRIOR TO ANY RAINFALL.


2. SOIL AND FILL STOCKPILES EXPECTED TO REMAIN IN PLACE FOR 90 DAYS OR MORE SHALL BE SEEDED WITH WINTER RYE (FOR FALL SEEDING AT 3LB/1,000 SF) OR OATS (FOR SUMMER SEEDING AT 2LB/1,000 SF) AND THEN COVERED WITH HAY MULCH (AT 100LB/1,000 SF) OR AN ANCHORED TARP WITHIN 7 DAYS OR PRIOR TO ANY RAINFALL.

> STOCKPILE PROTECTION NOT TO SCALE

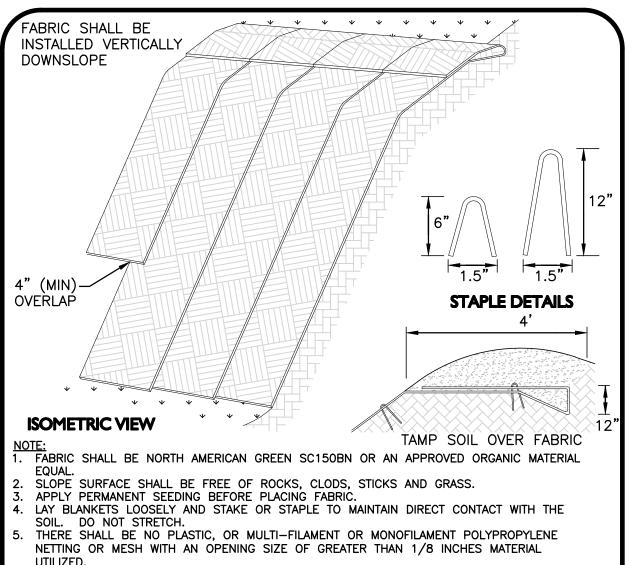

EROSION CONTROL FABRIC

NOT TO SCALE

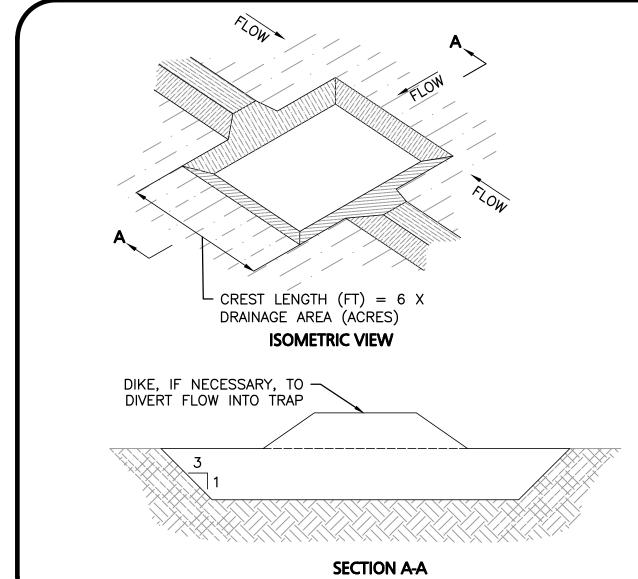


1. THE TRAP SHALL BE INSTALLED AS CLOSE TO THE DISTURBED AREA OR SOURCE OF SEDIMENT AS POSSIBLE.

NOT TO SCALE

- 2. THE MAXIMUM CONTRIBUTING DRAINAGE AREA TO THE TRAP SHALL BE LESS THAN 5 ACRES.
- 3. THE MINIMUM VOLUME OF THE TRAP SHALL BE 3,600 CUBIC FEET OF STORAGE FOR EACH ACRE OF DRAINAGE AREA.
- 4. THE SIDE SLOPES OF THE TRAP SHALL BE 3:1 OR FLATTER, AND SHALL BE STABILIZED IMMEDIATELY AFTER THEIR
- 5. THE OUTLET OF THE TRAP SHALL BE A MINIMUM OF ONE FOOT BELOW THE CREST OF THE TRAP AND SHALL DISCHARGE TO A STABILIZED AREA.
- 6. THE TRAP SHALL BE CLEANED WHEN 50% OF THE ORIGINAL VOLUME IS FILLED.
- 7. THE MATERIALS REMOVED FROM THE TRAP SHALL BE PROPERLY DISPOSED OF AN STABILIZED.

TEMPORARY EARTH OUTLET SEDIMENT TRAP NOT TO SCALE




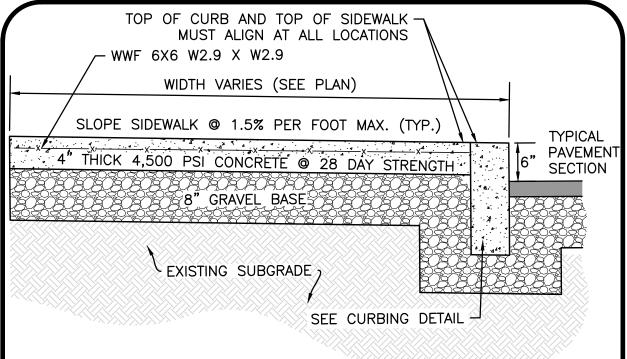



NOTES:

- SIDEWALK TO HAVE TOOLED JOINTS IN A 5' x 5' (TYP.) GRID WITH EXPANSION JOINTS 15' ON CENTER AND PREMOLDED FILLER
- 2. TOOLED JOINT 6" FROM FACE OF CURB
- 3. SEE PLAN FOR ELEVATIONS AT CURB
- SIDEWALK CROSS SLOPE TO BE 1.5% MAX & SIDEWALK LONGITUDINAL SLOPE TO BE 4.5% MAX, TYP.

CONCRETE SIDEWALK WITH CURB NOT TO SCALE

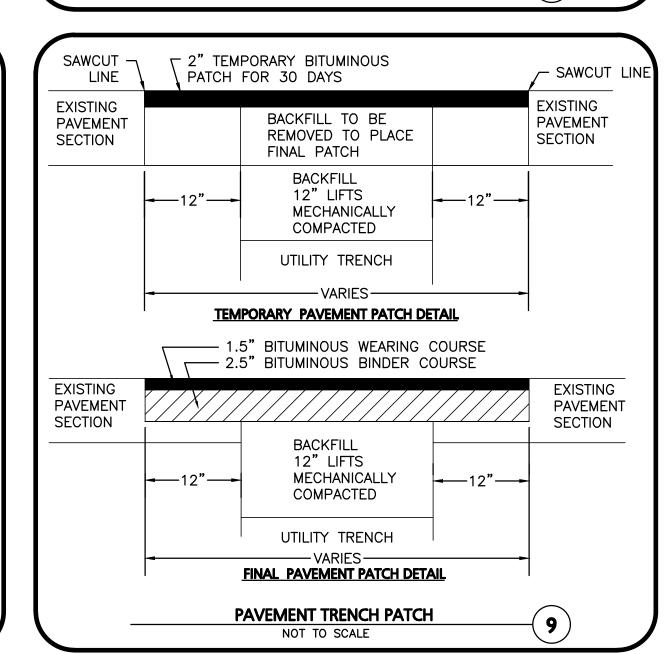

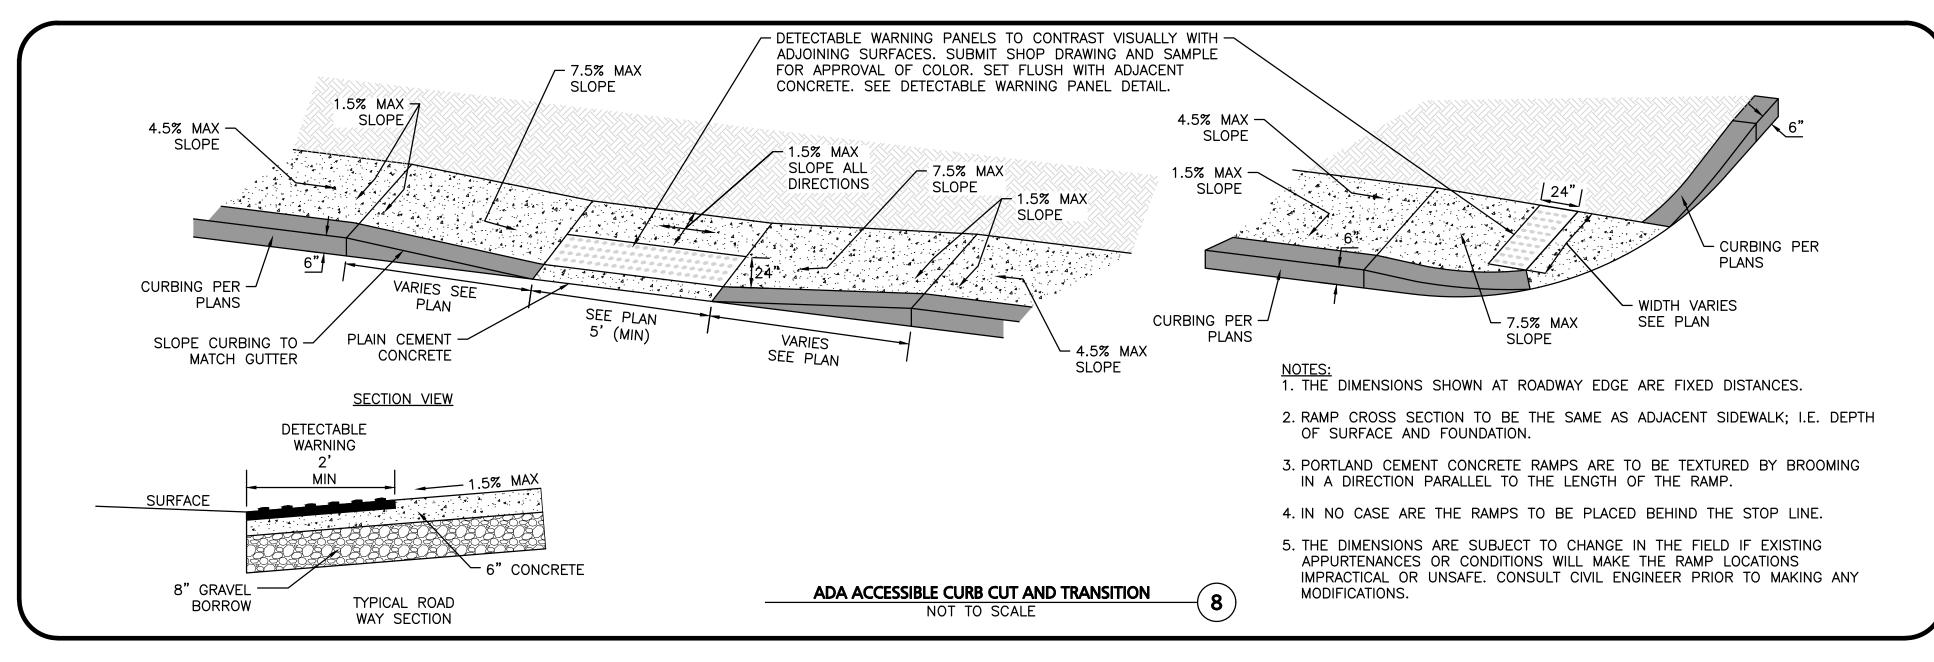

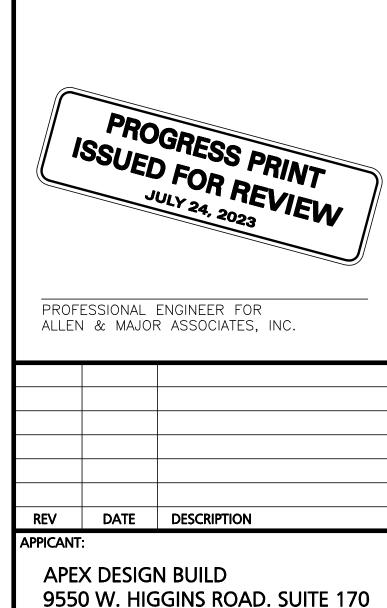

SURGICAL CENTER 360 CORPORATE DRIVE TAX MAP 315, LOT 5 PORTSMOUTH, NH 03801

ROSEMONT, IL 60018

PREPARED BY:			
DESIGNED BY:	BDJ	CHECKED BY:	RP
SCALE:	AS SHOWN	DWG. NAME: C	-3250-01.dw
PROJECT NO.	3250-01	DATE:	07-24-2



civil engineering • land surveying nvironmental consulting + landscape architecture www.allenmajor.com 400 HARVEY ROAD MANCHESTER, NH 03103

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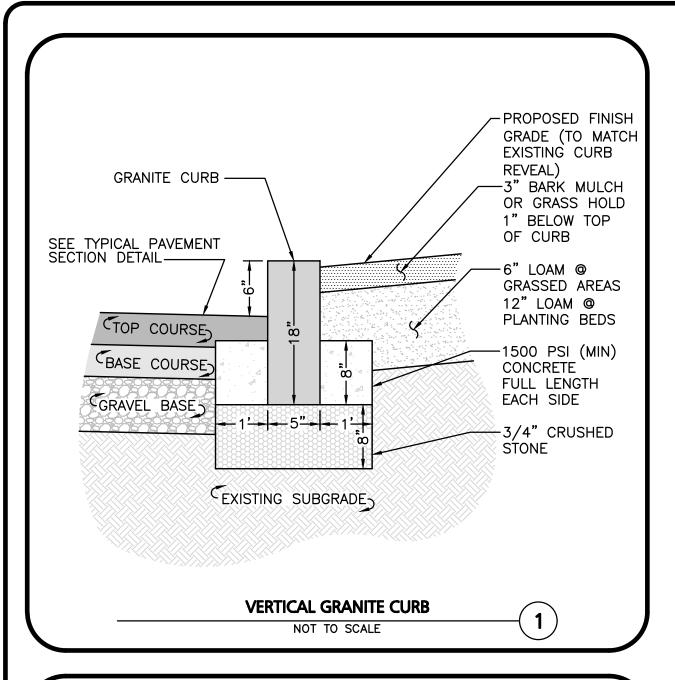
SHEET No.

C-501

DETAILS

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1'-0"

PARKIN

ACCESSIBL

SPECIFIC CODE SHALL BE REFERENCED FOR LOCAL AND STATE REQUIREMENTS.

EXPANSION JOINT MATERIAL NOT REQUIRED WITH FLEXIBLE PAVEMENT.

ACCESSIBLE PARKING SIGN POST

NOT TO SCALE

PROVIDE (1) SIGN PER HANDICAP SPACE. SEE SITE PLAN FOR EXACT LOCATION.

7.5"

-1.5" RADIUS

PER ADA

3'-6"

(4)

CONSULTANT

(TYP)

12"x18"x.080 GA.-

ALUMINUM SIGN

OF ACCESSIBILITY.

LETTERING IN WHITE

BORDER AND

PLAN AS "VAN"

FILL WITH GROUT

2" SQUARE SIGN POST

FOR HANDICAP SIGNAGE

ONLY, SET IN 6" PIPE

BOLLARD, PAINT YELLOW,

 $rac{1}{2}$ " EXPANSION JOINT-

4' DEEP x 18" DIA-

CONCRETE FOOTING


RETRO REFLECTORIZED

INTERNATIONAL SYMBOL-


ON BLUE BACKGROUND

ADDITIONAL SIGN STATING "VAN ACCESSIBLE SPACE"


WHERE INDICATED ON SITE

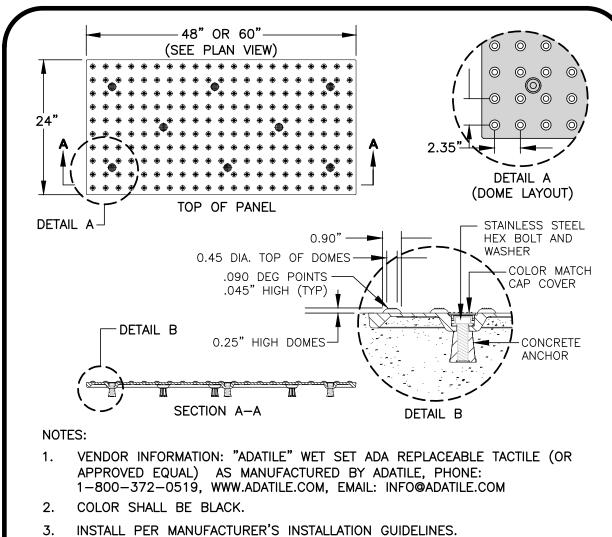

WET SET ADA REPLACEABLE TACTILE PANEL

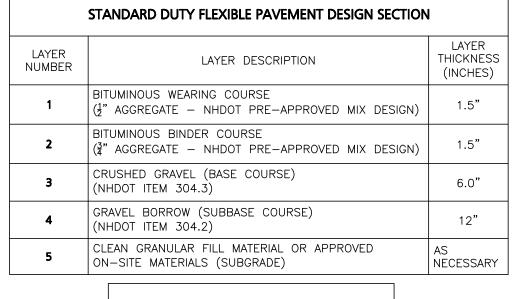


	PERCENT	PASSING B	Y WEIGHT
SIEVE SIZE	CLEAN GRANULAR FILL	BASE COURSE	SELECT GRANULAR FILL
8"	100	100	100
3"	70-100	100	70-100
<u>1</u> "	40-100	40-80	40-90
No. 4	25-100	30-70	25-80
No. 10	15-95	20-60	15-70
No. 40	10-70	10-30	5-40
No. 200	0-15	3-10	0-12

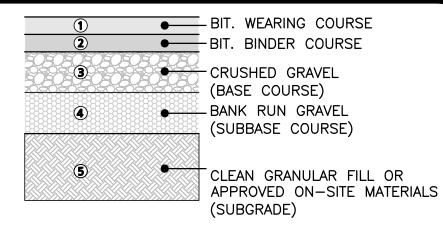

IF A GEOTECHNICAL REPORT IS PREPARED THE RECOMMENDATIONS WITHIN THAT REPORT SHALL SUPERCEDE RECOMMENDATIONS HEREIN. THE CONTRACTOR SHALL HAVE AND REVIEW A COPY OF THE GEOTECHNICAL REPORT AND COMPLY WITH THE RECOMMENDATIONS THEREIN.

- TOPSOIL SHALL BE REMOVED BENEATH ALL PAVEMENT AREAS TO EXPOSE THE NATURALLY-OCCURRING SOILS OR ACCEPTABLE ON-SITE FILL MATERIALS.
- 2. THE SUBGRADE SHOULD BE PROOFROLLED UNDER THE SUPERVISION OF A GEOTECHNICAL ENGINEER USING AT LEAST 4 PASSES OF A 10-TON VIBRATORY ROLLER. AREAS OF THE SUBGRADE THAT "WEAVE" OR "ROLL" EXCESSIVELY SHOULD BE OVEREXCAVATED AND REPLACED WITH DRIER CLEAN GRANULAR FILL MATERIAL.
- THE PAVEMENT SUBGRADE CONSISTING OF THE SPECIFIED CLEAN GRANULAR FILL SHALL BE PLACED IN 12" MAXIMUM LIFTS AND COMPACTED TO A DRY DENSITY OF AT LEAST 95 PERCENT OF THE MATERIALS MAXIMUM DRY DENSITY AS DETERMINED BY ASTM DESIGNATION D-1557.
- 4. PAVEMENT AND GRAVEL SPECIFICATIONS WITHIN THE CITY RIGHT-OF-WAY ARE TO BE DESIGNATED BY THE CITY'S DESIGN CONSULTANT FOR THE ROUNDABOUT PROJECT.

PAVEMENT SECTIONS NOT TO SCALE

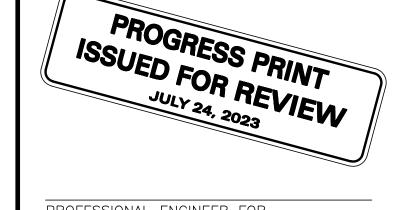

PROFESSIONAL ENGINEER FOR ALLEN & MAJOR ASSOCIATES, INC.

REV	DATE	DESCRIPTION

APPICANT:

APEX DESIGN BUILD 9550 W. HIGGINS ROAD. SUITE 170 ROSEMONT, IL 60018

SURGICAL CENTER 360 CORPORATE DRIVE **TAX MAP 315, LOT 5** PORTSMOUTH, NH 03801

PREPARED BY:			
DESIGNED BY:	BDJ	CHECKED BY:	RPC
SCALE:	AS SHOWN	DWG. NAME: C-	3250-01.dwg
PROJECT NO.	3250-01	DATE:	07-24-23



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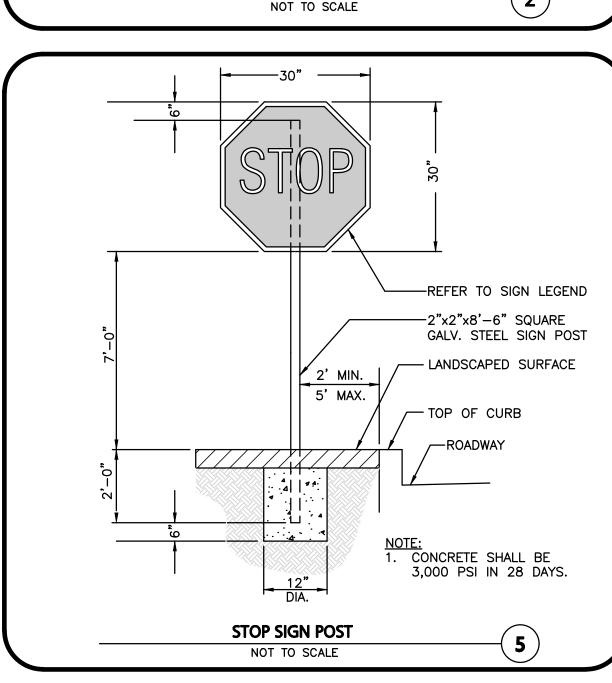
WOBURN, MA ♦ LAKEVILLE, MA ♦ MANCHESTER, NE


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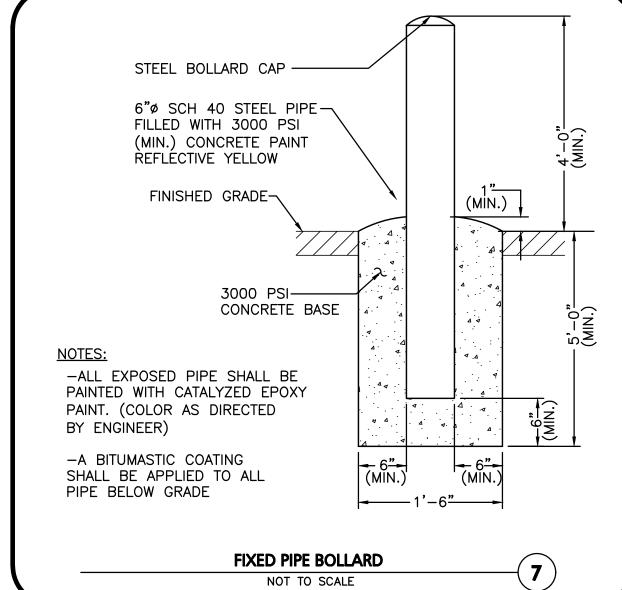
DRAWING TITLE:

C-502

SHEET No.





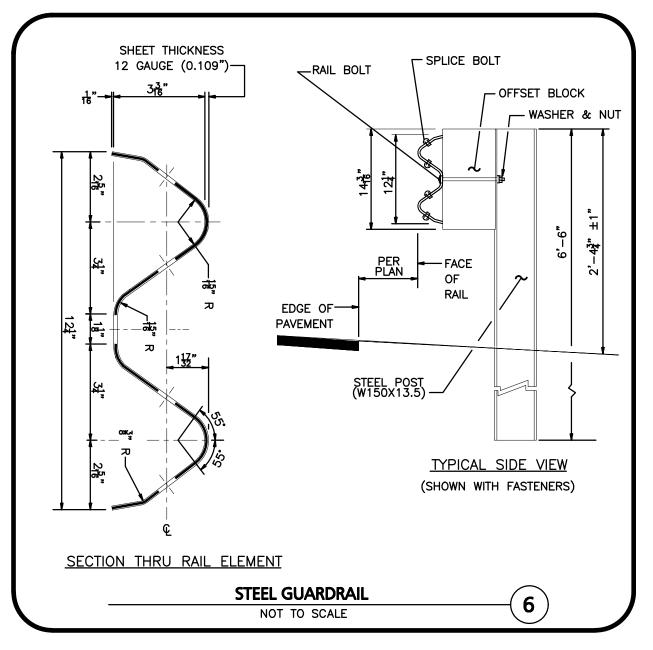

VARIES


— EQUIPMENT —


EQUIPMENT WIDTH


CRUSHED GRAVELS


EQUIPMENT WIDTH PLUS 2'-8"

MIN

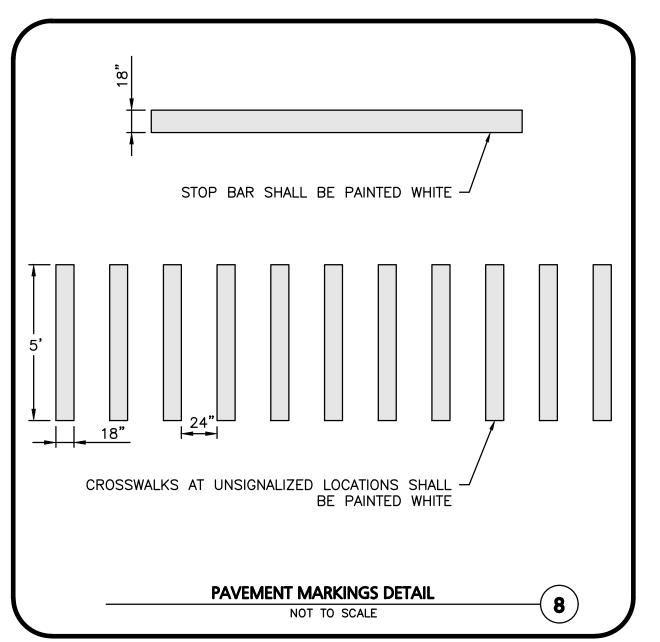

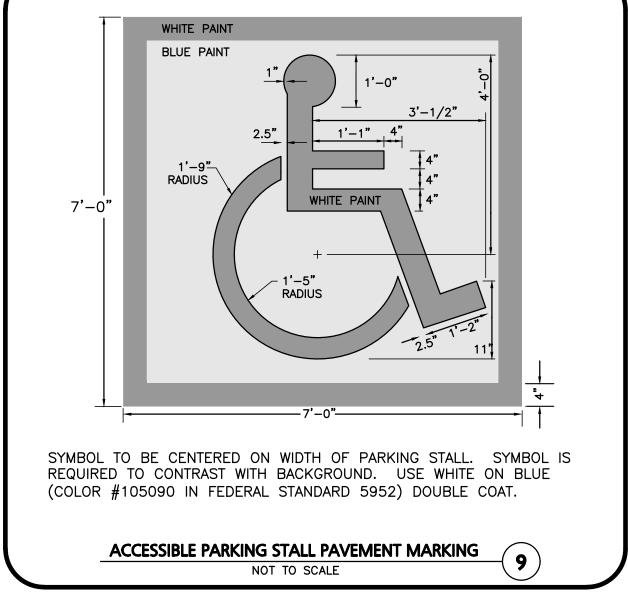

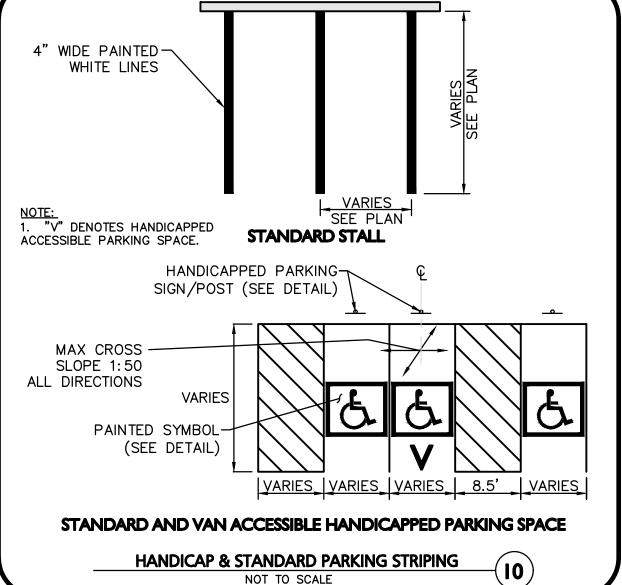

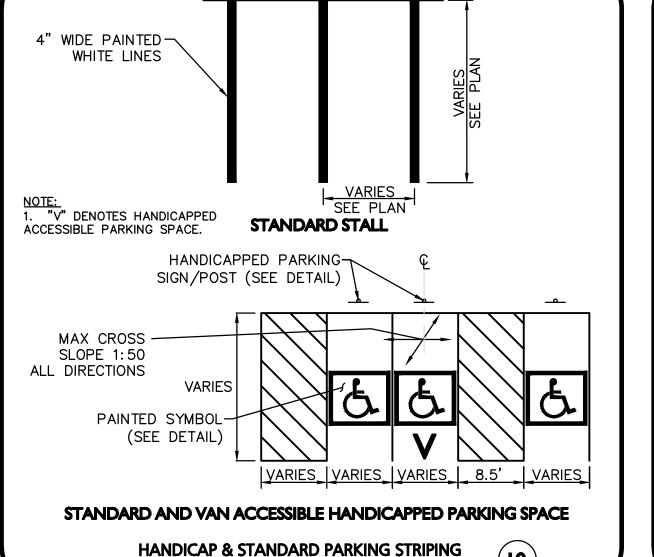

REFERENCE MECHANICAL ENGINEER'S PLANS FOR ANY PIPE, CONDUIT AND GROUND WIRE LOCATIONS TYPICAL UTILITY PAD (11) NOT TO SCALE

—EQUIPMENT PAD

SLAB (LENGTH

-6x6-W2.9xW2.9

4,500 P.S.I.


AND WIDTH VARY)

(MIN.) STRENGTH

-6" CONCRETE

DETAILS

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PROJECT NO. 3250-01 DATE: 07-24-23

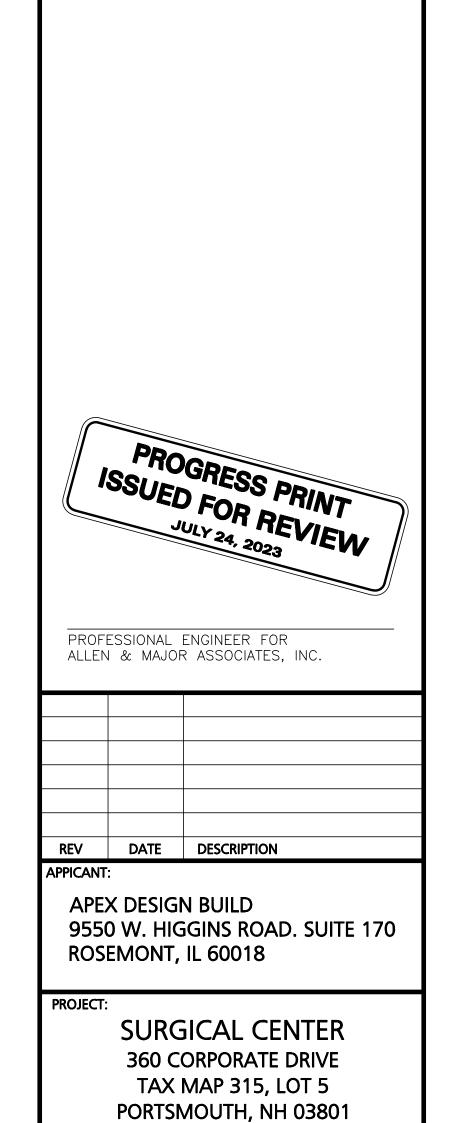BDJ CHECKED BY:

SCALE: AS SHOWN DWG. NAME: C-3250-01.dwg

EPARED BY:

ALLEN & MAJOR ASSOCIATES, INC.

civil engineering • land surveying
environmental consulting • landscape architecture
w w w . a l l e n m a j o r . c o m
400 HARVEY ROAD
MANCHESTER, NH 03103
TEL: (603) 627-5500

FAX: (603) 627-5501

WOBURN, MA ◆ LAKEVILLE, MA ◆ MANCHESTER, NH

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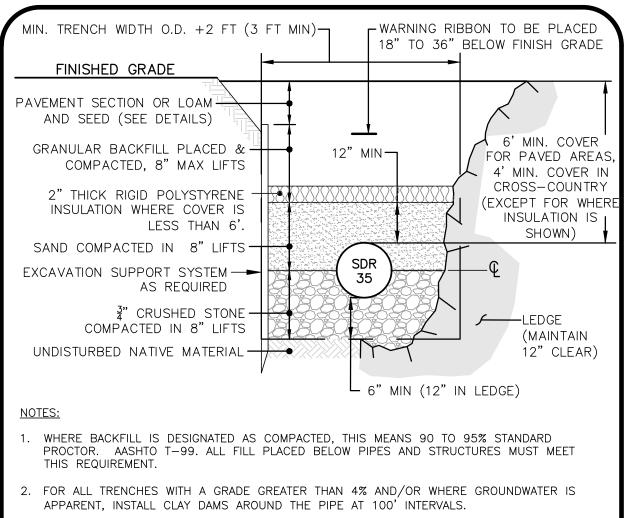
DESIGNED BY:

SHEET No.

DETAILS

C-503

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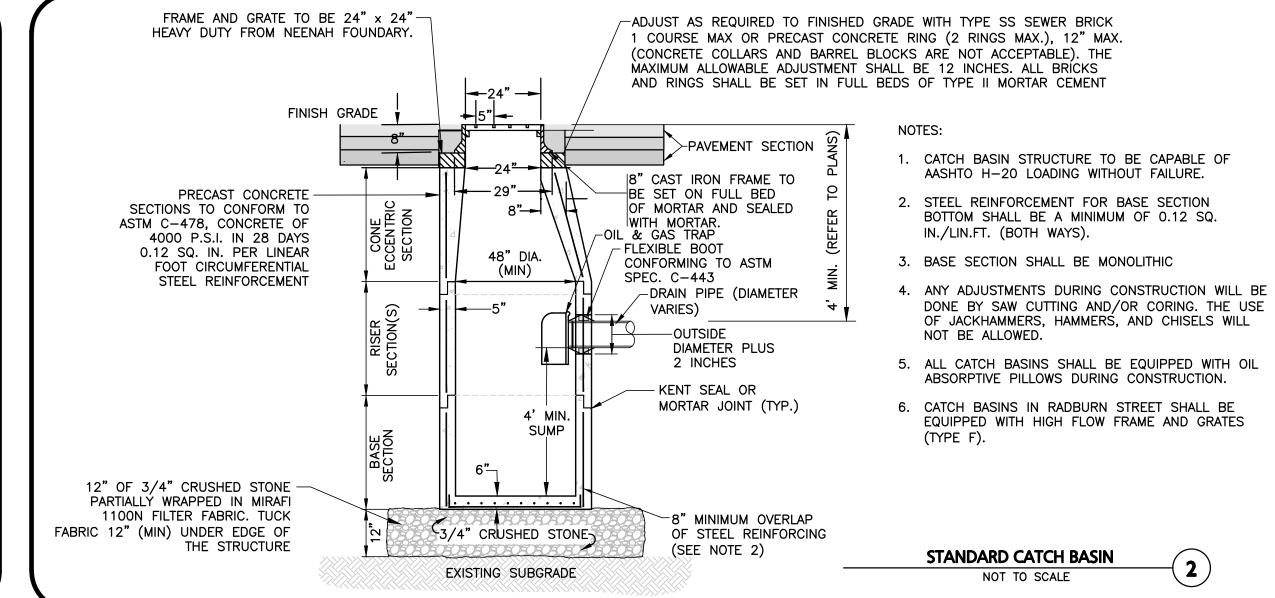
CRUSHED STONE SHALL BE CLEAN, HARD, FREE FROM COATINGS AND THOROUGHLY WASHED


WITH A GRADATION BY WEIGHT OF 100% PASSING A 1" SQUARE OPENING, AND 0 TO 5%


SEWER TRENCH DETAIL


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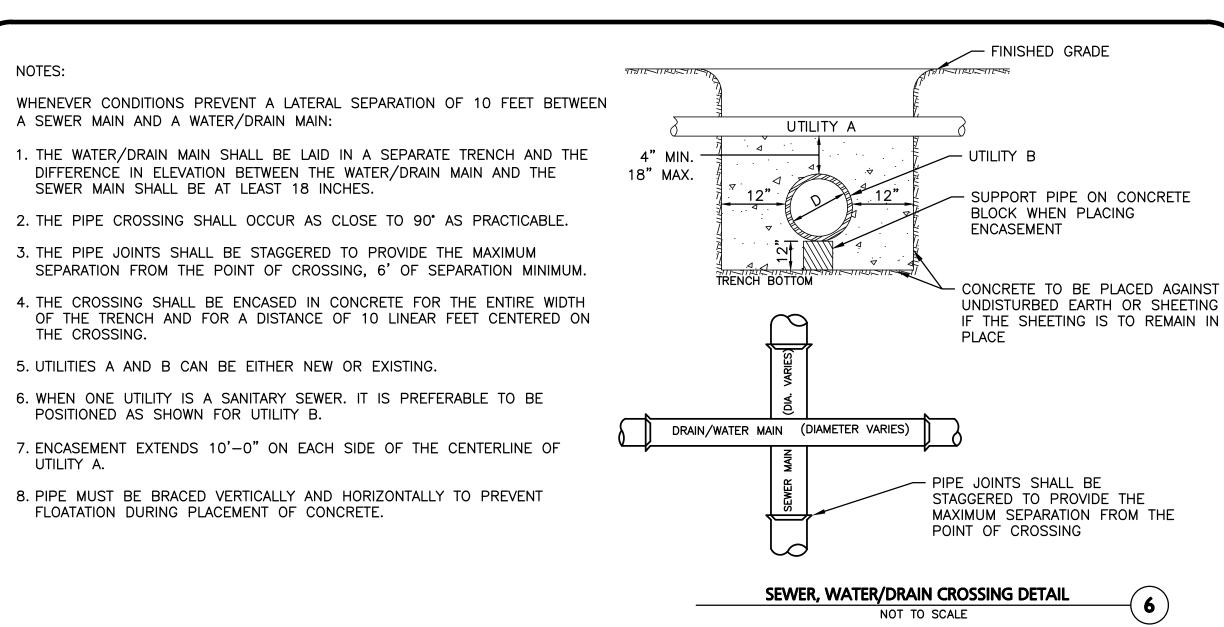
PASSING A 1 SQUARE OPENING.







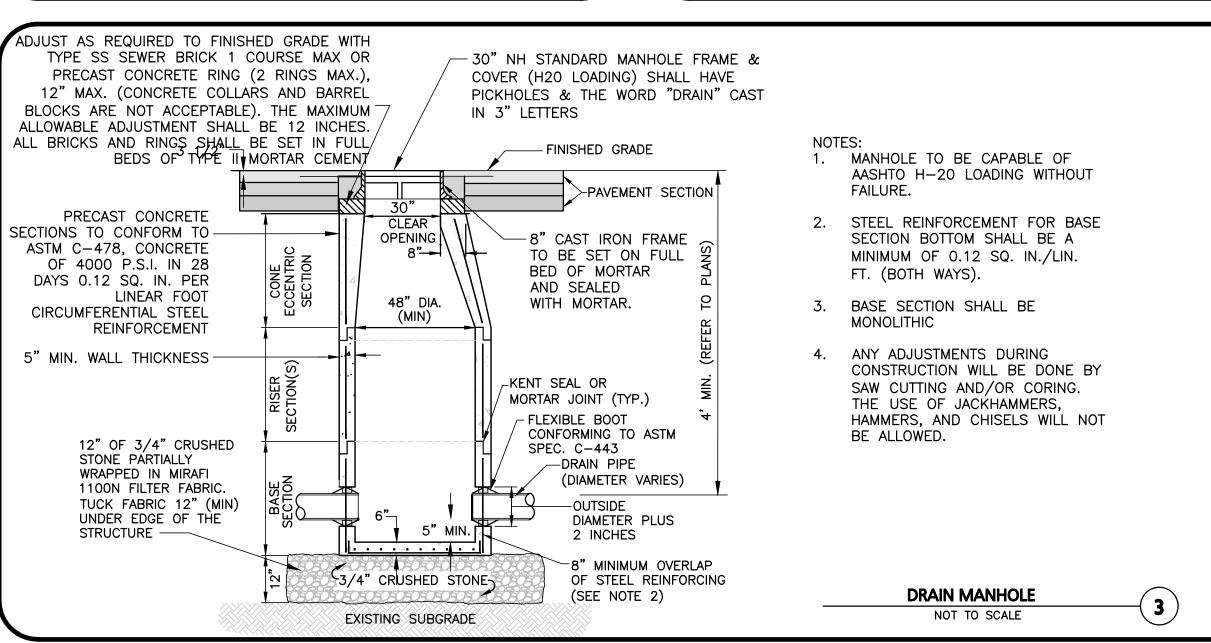

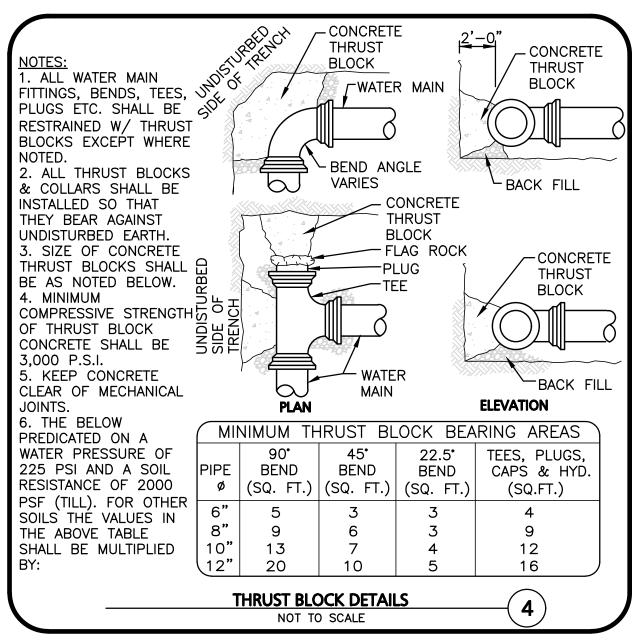

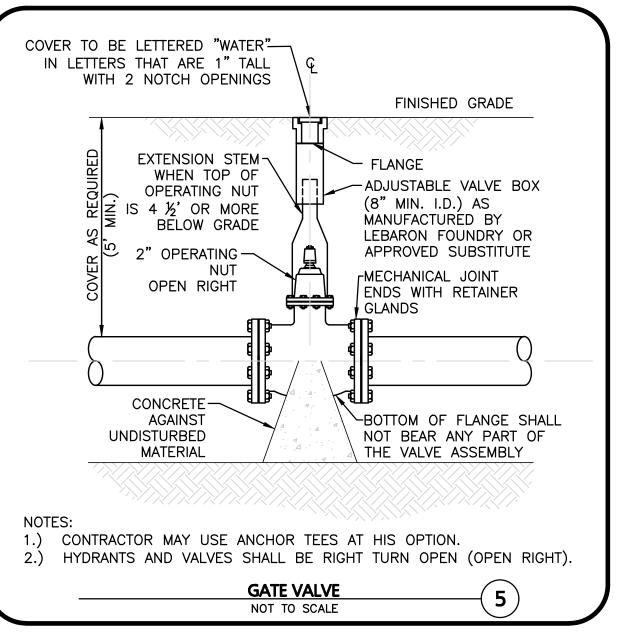

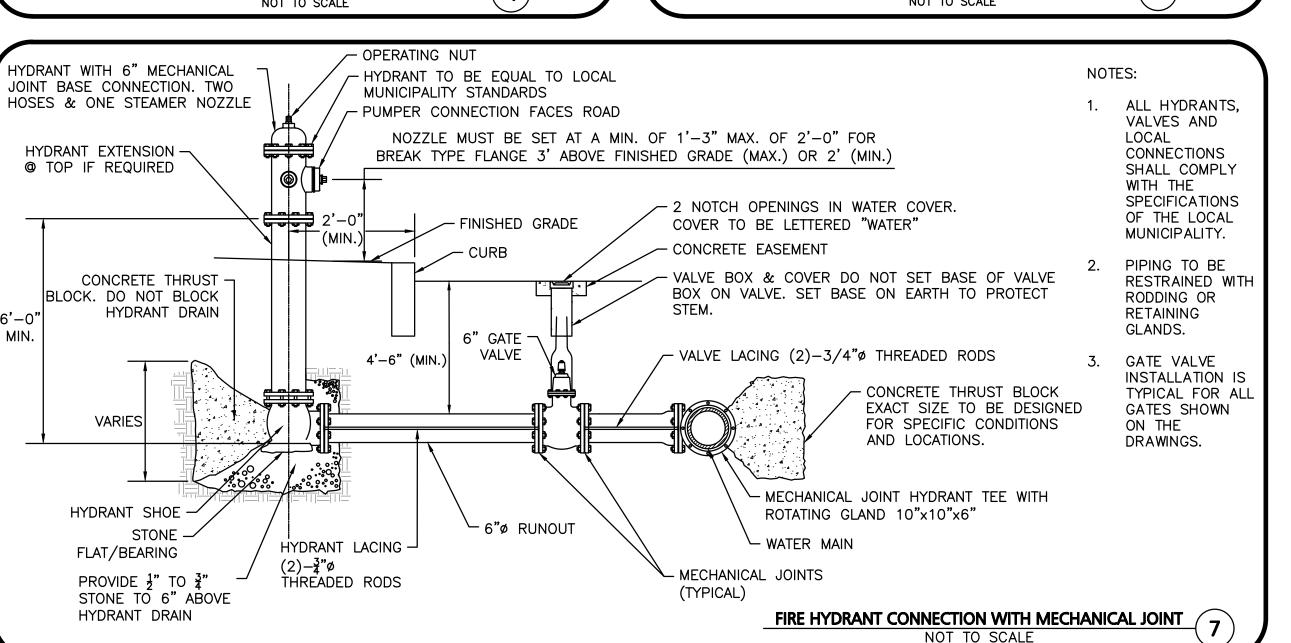

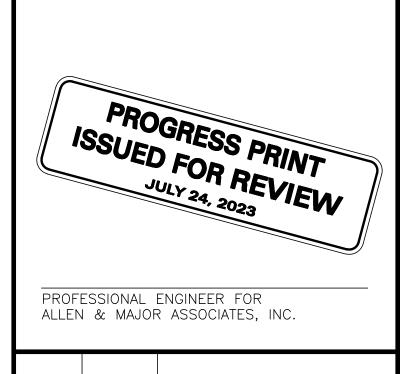

APPICANT: APEX DESIGN BUILD 9550 W. HIGGINS ROAD. SUITE 170

DATE DESCRIPTION

ROSEMONT, IL 60018

SURGICAL CENTER 360 CORPORATE DRIVE TAX MAP 315, LOT 5 PORTSMOUTH, NH 03801

PROJECT NO. 3250-01 DATE: 07-24-23 **SCALE:** AS SHOWN DWG. NAME: C-3250-01.dwg **DESIGNED BY:** BDJ CHECKED BY:



civil engineering • land surveying environmental consulting + landscape architecture www.allenmajor.com 400 HARVEY ROAD

MANCHESTER, NH 03103 TEL: (603) 627-5500 FAX: (603) 627-5501

WOBURN, MA ♦ LAKEVILLE, MA ♦ MANCHESTER, NE

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DRAWING TITLE:

DETAILS

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C-504

SHEET No.



PROFESSIONAL ENGINEER FOR ALLEN & MAJOR ASSOCIATES, INC.

REV DATE DESCRIPTION APPICANT:

> **APEX DESIGN BUILD** 9550 W. HIGGINS ROAD. SUITE 170 ROSEMONT, IL 60018

SURGICAL CENTER 360 CORPORATE DRIVE **TAX MAP 315, LOT 5** PORTSMOUTH, NH 03801

3250-01 DATE: 07-24-23 PROJECT NO.

1" = 30' DWG. NAME: C-3250-01.dwg BDJ CHECKED BY: **DESIGNED BY:**



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DRAWING TITLE:

SHEET No.

L-101

LANDSCAPE PLAN

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1-888-344-7233

- (a) LANDSCAPING
- (1) APPROPRIATE LANDSCAPING SHALL BE PROVIDED IN ACCORDANCE WITH AN APPROVED LANDSCAPING PLAN.
- (2) LANDSCAPING TREATMENT SHALL CONSIST OF NATURAL VEGETATION OR FEATURES, GROUND COVER.

SHRUBS AND TREES AS APPROPRIATE.

- (3) LANDSCAPING PLANS SHALL MEET THE REQUIREMENTS OF SECTION 405.03 OF THE PEASE DEVELOPMENT AUTHORITY SITE PLAN REGULATIONS.
- (b) SCREENING
- (1) APPROPRIATE BUFFERS SHALL BE PROVIDED AND MAINTAINED TO SCREEN THE FOLLOWING USES
- FROM ADJOINING PROPERTIES:

 a) ANY OFF-STREET PARKING OR LOADING AREA.
- b) ALL OUTDOOR AREAS OR FACILITIES FOR THE STORAGE OF FUEL, SOLID WASTE, MATERIALS
- PRODUCTS.
- c) ANY COMMERCIAL PARKING LOT.
- d) ANY PRINCIPAL USE NOT CONDUCTED WHOLLY WITHIN A BUILDING.
- 1. E) AS OTHERWISE REQUIRED BY THE BOARD.

PEASE DEVELOPMENT SITE PLAN REGULATIONS:

405.0

SCREENING AND LANDSCAPING

(a) LANDSCAPING PLAN

(1) A LANDSCAPING PLAN SHALL BE SUBMITTED AS PART OF THE SITE PLAN APPLICATION.

PLAN SHALL IDENTIFY EXISTING AND PROPOSED LANDSCAPING ELEMENTS AND SHOW LOCATION AND PLANTING AND/OR CONSTRUCTION DETAILS. WHERE EXISTING PLANTINGS ARE TO BE RETAINED, PROPOSED METHODS OF PROTECTING SUCH PLANTINGS DURING CONSTRUCTION SHALL BE INCLUDED WHERE APPLICABLE.

- (2) LANDSCAPING SHALL BE CONCEIVED IN A TOTAL PATTERN THROUGHOUT THE SITE, INTEGRATING THE VARIOUS ELEMENTS OF SITE DESIGN, PRESERVING AND ENHANCING THE PARTICULAR IDENTITY OF THE SITE, AND CREATING A PLEASING SITE CHARACTER.
- (3) LANDSCAPING MAY INCLUDE PLANT MATERIALS SUCH AS TREES, SHRUBS, GROUND COVERS, PERENNIALS, AND ANNUALS, AND OTHER MATERIALS SUCH AS ROCKS, WATER, SCULPTURE, ART, WALLS, FENCES, PAVING MATERIALS AND STREET FURNITURE.
- (4) ALL PARKING LOTS CONSTRUCTED OR REDEVELOPED AT PEASE SHALL MEET THE FOLLOWING REQUIREMENTS:
- a) SCREENING: ALL PARKING LOTS CONTAINING MORE THAN 25 PARKING SPACES SHALL BE APPROPRIATELY SCREENED FROM ADJACENT PROPERTIES AND ROADWAYS WITH LANDSCAPE BERMS AND/OR PLANTINGS IN ORDER TO MINIMIZE THE AESTHETIC IMPACT OF THE PARKING LOT.
- b) LANDSCAPED ISLANDS: ALL PARKING ROWS CONTAINING MORE THAN 10 SPACES SHALL HAVE LANDSCAPED ISLANDS THE SIZE OF A PARKING SPACE AT BOTH ENDS OF THE ROW.
- c) LENGTH OF ROWS: NO PARKING LOT SHALL CONTAIN MORE THAN 18 PARKING SPACES IN A ROW WITHOUT THE INCLUSION OF A LANDSCAPED ISLAND OF THE SAME SIZE AS THE PARKING SPACES IN THAT ROW.
- d) MULTIPLE PARKING AISLES: THERE MUST BE A 12' WIDE LANDSCAPED STRIP BETWEEN EVERY SECOND ROW OF DOUBLE STACKED PARKING.
- e)LANDSCAPE ISLANDS EXCEPT THAT THE CURBING MAY BE INTERRUPTED TO ALLOW FOR INFILTRATION OF STORMWATER.
- (B) SCREENING
- (1) SCREENING SHALL BE PROVIDED FOR ALL DEVELOPMENT OF LAND IN ORDER TO MINIMIZE ADVERSE VISUAL IMPACTS.
- (2) STRUCTURES VISIBLE FROM A PUBLIC STREET SHALL BE PARTIALLY SCREENED WITH FLOWERING OR EVERGREEN SHRUBS.
- (3) SOLID WASTE COLLECTION EQUIPMENT, PUMP STATIONS, OUTDOOR STORAGE AND OTHER OUTDOOR USES VISIBLE FROM A PUBLIC STREET SHALL BE SCREENED WITH A SOLID FENCE AND/OR EVERGREEN SHRUBS.

PLANTING SCHEDULE -TREES, SHRUBS, GROUNDCOVERS & PERENNIALS

	DECI	DUOUS TRE	EES				
I	KEY	QUANTITY	BOTANICAL NAME	COMMON NAME	MIN. SIZE	SPACING	COMMENTS
	AR	8	ACER RUBRUM 'RED SUNSET'	RED SUNSET MAPLE	2"-2.5" CAL.	AS SHOWN	B&B
	AC	3	AMELANCHIER CANADENSIS	SERVICEBERRY	6-7' HT.	AS SHOWN	B&B, MULTISTEM
	BP	4	BETULA PAPYRIFERA	PAPER BIRCH	12-14' HT.	AS SHOWN	B&B, MULTISTEM
	СК	5	CORNUS KOUSA	KOUSA DOGWOOD	2"-2.5" CAL.	AS SHOWN	B&B
(CKW	1	CORNUS KOUSA 'WOLF EYES'	WOLF EYES KOUSA DOGWOOD	2"-2.5" CAL.	AS SHOWN	B&B-SPECIMEN
	CV	4	CHIONANTHUS VIRGINICUS	WHITE FRINGE TREE	2"-2.5" CAL.	AS SHOWN	B&B
	FA	3	FRANKLINIA ALATAMAHA	FRANKLIN TREE	6-7' HT.	AS SHOWN	B&B
	FS	1	FAGUS SYLVATICA 'RIVERSII'	RIVER'S PURPLE BEECH	2"-2.5" CAL.	AS SHOWN	B&B
	МВ	2	MAGNOLIA 'BUTTERFLY'	BUTTERFLY MAGNOLIA	6-7' HT.	AS SHOWN	B&B
	QA	2	QUERCUS ALBA	WHITE OAK	2"-2.5" CAL.	AS SHOWN	B&B
)	QC	4	QUERCUS COCCINEA	SCARLET OAK	2"-2.5" CAL.	AS SHOWN	B&B
	NS	5	NYSSA SYLVATICA 'GREEN GABLE'	GREEN GABLE TUPELO	2"-2.5" CAL.	AS SHOWN	B&B
	TC	9	TILIA CORDATA 'GREENSPIRE'	GREENSPIRE LINDEN	2"-2.5" CAL.	AS SHOWN	B&B
E	EVER	GREEN TRE	EES				
	PG	6	PICEA GLAUCA	WHITE SPRUCE	7-8' HT.	AS SHOWN	B&B
	то	7	THUJA OCCIDENTALIS 'NORTH POLE'	NORTH POLE ARBORVITAE	5-6' HT.	AS SHOWN	B&B
(SHRU		PULL				
	AZ	34	AZALEA 'DELAWARE WHITE'	DELAWARE WHITE AZALEA	# 5	AS SHOWN	POT
	BG	8	BUXUS 'GREEN GEM'	GREEN GEM BOXWOOD	#5	AS SHOWN	B&B
	CA	25	CLETHRA ALNIFOLIA	HUMMINGBIRD	#7	AS SHOWN	POT
	CI	22	'HUMMINGBIRD' CORNUS ALBA 'IVORY HALO'	SUMMERSWEET IVORY HALO DOGWOOD	#7	AS SHOWN	POT
	FG	15	FOTHERGILLA GARDENII	DWARF FOTHEREGILLA	2-2.5'	AS SHOWN	B&B
F	HY	40	HYDRANGEA ARBORESCENS	INCREDIBALL HYDRANGEA	#5	AS SHOWN	B&B
	IG	 54	'INCREDIBALL' ILEX GLABRA 'SHAMROCK'	SHAMROCK INKBERRY	#5	AS SHOWN	B&B
	MP		MYRICA PENSYLVANICA	BAYBERRY	2.5'-3' HT.	AS SHOWN	B&B
	RA		RHODODENDRON 'APRIL ROSE'	APRIL ROSE	2.5'-3' HT.	AS SHOWN	B&B
	RK		PINK DOUBLE KNOCK OUT	RHODODENDRON PINK DOUBLE KNOCK OUT	#3	AS SHOWN	POT
	TM	 88	TAXUS MEDIA 'GREENWAVE'	ROSE GREENWAVE YEW	18-24"	AS SHOWN	B&B
	VD	22	VIBURNUM DENTATUM 'BLUE	BLUE MUFFIN VIBURNUM	3-4' HT.	AS SHOWN	B&B
		 NNIALS/GR	MUFFIN' ASSES	BESE WOTTHY VIBORITOR	J- + III.	AS SHOWN	<u> </u>
	AB	•	AMSONIA 'BLUE ICE'	BLUE ICE BLUESTAR	#2	24" O.C.	STAGGERED
\vdash	AH		AMSONIA HUBRICHTII	FLOWER THREAD—LEAFED BLUESTAR	#2 #2	24 O.C. 24" O.C.	STAGGERED
	PV		PANICUM VIRGATUM	SHENANDOAH SWITCH	#3	30" O.C.	STAGGERED
	DP		'SHENANDOAH' DENSTEADTIA PUNCTILOBA	GRASS HAYSCENTED FERN	#2	24" O.C.	STAGGERED
	DS		SPOROBOLUS HETEROLEPIS	PRAIRIE DROPSEED	#2	24 O.C. 24" O.C.	STAGGERED
	HO		HOSTA 'GUACAMOLE'	GUACAMOLE HOSTA	#2	24 O.C. 24" O.C.	STAGGERED
	HS		HEMEROCALLIS 'BIG TIME	BIG TIME HAPPY DAYLILLY			
	NP		HAPPY'		#2	24" O.C.	STACCERED
	RF		NEPETA 'PURRSIAN BLUE'	PURRSIAN BLUE CATMINT	#2	24" O.C.	STACCERED
	INF	29	RUDBECKIA FULGIDA FULGIDA	BLACK EYED SUSAN	#2	24" O.C.	STAGGERED

*ANNUALS / SEASONAL COLOR TO BE NORTH SHORE MIX BY PROVEN WINNERS OR EQUAL.

CONSERVATION WILDLIFE SEED MIX:

NEW ENGLAND CONSERVATION / WILDLIFE MIX
(BY NEW ENGLAND WETLAND PLANTS INC. — NEWP.COM)
APPLICATION RATE: 25 LBS/ACRE | 1750 SQ FT/LB

APPL	LICATION RATE: 25 LBS/ACRE 1/50 SQ F	I/LB	
ITEM	BOTANICAL NAME	COMMON NAME	INDICATOR
1.	ELYMUS VIRGINICUS	VIRGINIA WILD RYE	FACW
2.	CHAMAECRISTA FASCICULATA	PARTRIDGE PEA	FACU
3.	FESTUCA RUBRA	RED FESCUE	FACU
	SCHIZACHYRIUM SCOPARIUM	LITTLE BLUESTEM	FACU
5.	ANDROPOGON GERARDII	BIG BLUESTEM	FACU
6.	PANICUM VIRGATUM	SWITCH GRASS	FAC
7.	DESMODIUM PANICULATUM	PANICLEDLEAF TICK TREFOIL	FACU
8.	SORGHASTRUM NUTANS	INDIAN GRASS	FACU
	VERBENA HASTATA	BLUE VERVAIN	FACW
10.	ASCLEPIAS TUBEROSA	BUTTERFLY MILKWEED	
11.	RUDBECKIA HIRTA	BLACK EYED SUSAN	FACU
12.	HELENIUM AUTUMNALE	FALL SNEEZEWEED	FACW
13.	ASTERPILOSUS/SYMPHYOTRICHUM PILOSUM	HEATH ASTER	FACU
14.		EARLY GOLDENROD	
15.	AGROSTIS PERENNANS	UPLAND BENTGRASS	FACU

THE NEW ENGLAND CONSERVATION/WILDLIFE MIX PROVIDES A PERMANENT COVER OF GRASSES, WILDFLOWERS, AND LEGUMES. FOR BOTH GOOD EROSION CONTROL AND WILDLIFE HABITAT VALUE. THE MIX IS DESIGNED TO BE A NO MAINTENANCE SEEDING, AND IS APPROPRIATE FOR CUT AND FILL SLOPES, DETENTION BASIN SIDE SLOPES, AND DISTURBED AREAS ADJACENT TO COMMERCIAL AND RESIDENTIAL PROJECTS.

LANDSCAPE NOTES

- 1. ALL WORK SHALL BE IN ACCORDANCE WITH THE REQUIREMENTS OF THE CITY/TOWN OF PORTSMOUTH, NH. PLANTING PLAN IS DIAGRAMMATIC IN NATURE. FINAL PLACEMENT OF PLANTS TO BE APPROVED BY THE LANDSCAPE ARCHITECT IN THE FIELD.
- 2. THE CONTRACTOR SHALL BE RESPONSIBLE FOR CONTACTING ALL UTILITY COMPANIES, ANY PERMITTING AGENCIES, AND "DIG-SAFE" (1-888-344-7233) AT LEAST 72 HOURS IN ADVANCE OF ANY WORK THAT WILL REQUIRE EXCAVATION. CONTRACTOR SHALL NOTIFY THE OWNERS REPRESENTATIVE OF NAY CONFLICTS IN WRITING.
- 3. NO PLANT MATERIAL SHALL BE INSTALLED UNTIL ALL GRADING AND CONSTRUCTION HAS BEEN COMPLETED IN THE IMMEDIATE AREA.
- 4. ANY TREES NOTED AS "SEAL OR SELECTED SPECIMEN" SHALL BE TAGGED AND SEALED BY THE LANDSCAPE ARCHITECT.
- 5. ALL TREES SHALL BE BALLED AND BURLAPPED (B&B) UNLESS OTHERWISE NOTED OR APPROVED BY THE OWNER'S REPRESENTATIVE AND LANDSCAPE ARCHITECT.
- 6. CONTRACTOR SHALL VERIFY QUANTITIES SHOWN ON PLANT LIST. QUANTITIES SHOWN ON PLANS SHALL GOVERN OVER PLANT LIST.
- 7. ANY PROPOSED PLANT SUBSTITUTIONS MUST BE APPROVED IN WRITING BY OWNER'S REPRESENTATIVE AND LANDSCAPE ARCHITECT.
- 8. ALL PLANT MATERIALS INSTALLED SHALL MEET THE GUIDELINES ESTABLISHED BY THE AMERICAN STANDARD FOR NURSERY STOCK PUBLISHED BY AMERICANHORT (LATEST EDITION).
- 9. ALL PLANT MATERIALS SHALL BE GUARANTEED FOR ONE YEAR FOLLOWING DATE OF ACCEPTANCE. ANY PLANT MATERIALS WHICH DIE WITHIN THE ONE YEAR PLANT GUARANTEE PERIOD WILL BE REPLACED BY THE LANDSCAPE CONTRACTOR. OWNERS TO COORDINATE DIRECTLY WITH THE LANDSCAPE CONTRACTOR FOR REPLACEMENT PLANTINGS.
- 10. ALL DISTURBED AREAS NOT OTHERWISE NOTED SHALL RECEIVE 6" OF SUITABLE LOAM &
- 11. LAWNS WITH 3:1 OR GREATER SLOPES SHALL BE PROTECTED WITH AN EROSION CONTROL
- 12. ANY FALL TRANSPLANTING HAZARD PLANTS SHALL BE DUG IN THE SPRING AND STORED FOR FALL PLANTING.
- 13. TREES SHALL HAVE A MINIMUM CALIPER AS INDICATED ON THE PLANTING SCHEDULE TAKEN ONE FOOT ABOVE THE ROOT CROWN.
- 14. ALL PLANT BEDS AND TREE SAUCERS TO RECEIVE 3" OF PINE BARK MULCH. GROUNDCOVER AREAS SHALL RECEIVE 1" OF PINE BARK MULCH.
- 15. ALL DECIDUOUS TREES ADJACENT TO WALKWAYS AND ROADWAYS SHALL HAVE A BRANCHING PATTERN TO ALLOW FOR A MINIMUM OF 7' OF CLEARANCE BETWEEN THE GROUND AND THE LOWEST BRANCH.
- 16. ALL TREE STAKES SHALL BE STAINED DARK BROWN.
- 17. CONTRACTOR RESPONSIBLE FOR WATERING AND RESEEDING OF BARE SPOTS UNTIL A UNIFORM STAND OF VEGETATION IS ESTABLISHED AND ACCEPTED.
- 18. ALL PARKING ISLANDS PLANTED WITH SHRUBS SHALL HAVE 24" OF TOP SOIL. FINISH GRADE SHALL BE SLOPED TO SIX INCHES (6") ABOVE THE TOP OF CURB.
- 19. SOIL SAMPLES, TESTS, AND SHOP DRAWINGS SHALL BE PROVIDED TO THE LANDSCAPE ARCHITECT OR THE OWNER FOR APPROVAL PRIOR TO CONSTRUCTION.
- 20. SLOPES AT 2:1 SHOULD HAVE 6" LOAM & SEED. SEEDING OF 2:1 SLOPES SHALL OCCUR IN THE DRY & AFTER SLOPES ARE COMPACTED.
- 21. ALL LANDSCAPED AREAS WITH SHRUBS, TREES, AND PERENNIALS TO HAVE 2 FEET MINIMUM DEPTH OF TOPSOIL. TWO FEET OF TOPSOIL AROUND TREES AND SHRUBS DOES NOT INCLUDE AMENDED PLANTING SOIL WITHIN TREE / SHRUB PIT FOR FULL DEPTH OF ROOTBALLS. SEE PLANTING DETAILS FOR PLANTING DEPTH AT SHRUBS AND TREES. ALL AREAS OF LOAM AND SEED TO HAVE 6" MINIMUM DEPTH OF TOPSOIL. TOPSOIL TO BE TESTED BY CONTRACTOR, AND APPROVED BY A&M PRIOR TO PURCHASE AND OR PLACEMENT. GENERAL, DEMOLITION, AND LANDSCAPE CONTRACTORS TO COORDINATE PROPER DEPTH OF EXISTING MATERIAL REMOVAL ACROSS SITE SO THAT 2 FEET MINIMUM AND 6" MINIMUM DEPTHS OF PROPOSED TOPSOIL NOTED ABOVE ARE MET. SEE TOPSOIL DETAIL.
- 22. PRIOR TO LAYING TOPSOIL, ALL SUBSOIL (BELOW PROPOSED TOPSOIL) TO BE TILLED TO A DEPTH OF AT LEAST 18" TO REMOVE CONSTRUCTION COMPACTION AND ALLOW FOR PROPER DRAINAGE OF TOPSOILS.
- 23. ALL SEEDING TO BE COMPLETED "IN SEASON" BETWEEN APRIL 1 TO JUNE 15 OR AUGUST 15 TO OCTOBER 1, EXCEPT FOR RE-SEEDING OF BARE SPOTS. AT ALL SLOPED AREAS CONTRACTOR TO INSTALL COCONUT FIBER JUTE MESH NETTING ON ALL SLOPES 3:1 AND GREATER, HYDROSEED ALL EXPOSED AREAS, ADD SOIL STABILIZER "FLEXTERRA HP-FGM" AS MANUFACTURED BY "PROFILE" TO HYDROSEED (AT RATE OF 3,000 LBS PER ACRE). CONTRACTOR TO ALSO BE RESPONSIBLE FOR RE-GRADING AND RE-SEEDING ALL DISTURBED, ERODED, OR BARE SPOTS & UNTIL SLOPES ARE FULLY STABLE. CONTRACTOR RESPONSIBLE FOR ALL MAINTENANCE UNTIL FINAL ACCEPTANCE OF LAWN AREAS INCLUDING: WATERING, ADDING FERTILIZERS AND LIME AND MOWING.
- 24. AFTER SEEDING, ALL AREAS TO BE LIGHTLY MULCHED WITH WEED FREE STRAW & CONTINUALLY WATERED EVERY DAY SO THAT SEED IS KEPT MOIST UNTIL SEED IS ESTABLISHED & APPROVED BY A&M LANDSCAPE ARCHITECT (USE NO HAY).
- 25. IF THERE IS NO PROPOSED IRRIGATION SYSTEM AFTER PLANTINGS & LAWNS & SEEDED AREAS HAVE BEEN INSTALLED, LANDSCAPE CONTRACTOR RESPONSIBLE TO TEMPORARILY WATER ALL INSTALLED PLANTINGS, SEEDED AREAS, & LAWN AREAS MIN. 4 TIMES A WEEK DURING INITIAL ESTABLISHMENT PERIOD OF 6 MONTHS AFTER ALL LANDSCAPING IS INSTALLED.
- 26. ALL PROPOSED LANDSCAPE AREAS INCLUDING MOWED LAWNS, TREES, SHRUB BEDS, AND PERENNIALS SHALL BE PROVIDED WITH WATER EFFICIENT UNDERGROUND IRRIGATION. DESIGN AND INSTALLATION OF IRRIGATION SYSTEM TO BE PERFORMED BY AN APPROVED IRRIGATION DESIGN BUILD CONTRACTOR OR BY AN APPROVED EQUAL TO BE DETERMINED BY THE OWNERS REPRESENTATIVE AND LANDSCAPE ARCHITECT. IRRIGATION SYSTEM IS TO BE DESIGNED FOR EFFICIENT WATER USAGE INCLUDING: USE OF DRIP IRRIGATION FOR SHRUBS AND PERENNIALS, IRRIGATION SYSTEM WITH HEAD—TO—HEAD COVERAGE, A CENTRAL SHUT—OFF VALVE, SEPARATE ZONES FOR EACH TYPE OF BEDDING AREA BASED ON WATERING NEEDS, AND A RAIN SENSOR TO SHUT OFF IRRIGATION DURING RAIN EVENTS.
- 27. SEEDING OF BIORETENTION & DETENTION AREAS & OTHER SLOPE AREAS SHALL OCCUR IN THE DRY & AFTER SLOPES ARE COMPACTED. IT IS IMPORTANT, THAT THE BIORETENTION AREAS/ DETENTION BASIN BE SEEDED AT THE BEGINNING OF THE PROJECT & PRIOR TO ANY DRAINAGE BEING DIRECTED TOWARDS THE BASIN. THE SEED AT DETENTION AREAS & OTHER SLOPED AREAS WILL NEED A MINIMUM OF 6 MONTHS TO INITIALLY ESTABLISH PRIOR TO THE DETENTION BASIN BEING UTILIZED SO THAT THERE IS NOT EROSION & SLOPE FAILURE. LIGHTLY RAKE SOIL TO ENSURE GOOD SEED—TO—SOIL CONTACT. SEE SEED MIX DETAIL NOTES.
- 28. FOR SPREADING OF THE SEED WITH DRY DETENTION BASINS, WATER LEVELS MAY BE LOWERED IN THE DETENTION AREAS BY RELYING ON DRY SEASON AND OR DRY SPELLS; OR MAY BE ACCOMPLISHED THROUGH THE USE OF DEWATERING METHODS. CONTRACTOR SHALL SUBMIT SHOP DRAWINGS OF ANY DEWATERING METHODS FOR REVIEW AND APPROVAL PRIOR TO CONSTRUCTION. WATER FROM ANY DEWATERING OPERATION SHALL BE TREATED TO REDUCE TOTAL SUSPENDED SOLIDS AND BE IN COMPLIANCE WITH STATE AND FEDERAL STANDARDS.



PROFESSIONAL ENGINEER FOR ALLEN & MAJOR ASSOCIATES, INC.

REV	DATE	DESCRIPTION

APPICANT:

APEX DESIGN BUILD 9550 W. HIGGINS ROAD. SUITE 170 ROSEMONT, IL 60018

PROJECT

SURGICAL CENTER 360 CORPORATE DRIVE TAX MAP 315, LOT 5 PORTSMOUTH, NH 03801

PROJECT NO.	3250-01	DATE:	07-24-
SCALE:	AS SHOWN	DWG. NAME: C-3	3250-01.dv
DESIGNED BY:	BDJ	CHECKED BY:	RI

ALLEN & MAJOR

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environmental consulting • landscape architecture

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DRAWING TITLE:

SHEET No.

L-401

LANDSCAPE NOTES

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JECTS\3250—01\CIVIL\DRAWINGS\CURF

(2) MIN. 2" X 2" X 8'

10'-0" FOR TREES > 3"

CAL. 8'0" FOR TREES 3" CAL

NEW OR EXISTING -

MIN.

X DIA. OF

ROOTBALL WITH SLOPED

SIDES

3 X | DIA.

ROOTBALL

WITH SLOPED SIDES

WOOD POSTS FOR

TREES UNDER 3"

6" MIN. TOPSOIL,

UNDISTURBED SOIL-

CALIPER

AND UNDER

PLANTING MIX

NOTE 2 &3.

BACK FILL SEE

ROOTBALL—

<u>NOTES</u>

- 1. TREES SHALL BEAR SAME RELATIONSHIP TO FINISH GRADE AS IT BORE TO NURSERY OR FIELD GRADE. ROOT FLARE SHALL BE 2" ABOVE FINISH GRADE. REMOVE SOIL FROM TRUNK FLARE OF TREE TO DETERMINE ACTUAL TOP OF ROOTBALL AREA.
- 2. INSTALL THREE GUYS PER TREE; EQUALLY SPACED AROUND BALL.
- 3. ATTACH GUYS AT 2/3 HEIGHT OF TREE.
- 4. BACKFILL WITH PLANTING MIX. PLANT MIX TO BE: 50% NATIVE TOPSOIL, 20% COMPOST (LEAVES & ORGANIC MATERIAL, NO ASH) 20% PEAT MOSS, 10% SAND.
- 5. ADD MYCORRHIZA SOIL ADDITIVES AND SLOW RELEASE FERTILIZER WHEN PLANT HOLES ARE 50% FILLED AND WATER THOROUGHLY AT COMPLETION.

EVERGREEN TREE DETAIL

NOT TO SCALE

NOTES:

-ARBOR TIES BY DEEP ROOTS

-REMOVE STAKES AFTER ONE

—4" EARTH SAUCER WITH

AND WIRE BASKET ENTIRELY.

-REINFORCED RUBBER HOSE

-3 POSTS FOR ALL TREES

3" CALIPER & OVER

TREE PIT

OR APPROVED EQUAL

GROWING SEASON

∕-3" BARK MULCH


BARK MULCH


CUT & REMOVE BURLAP

- 1. ALL TREES SHALL HAVE THE SAME RELATIONSHIP TO FINISH GRADE AFTER PLANTING AS THEY HAD AT THE ORIGINAL NURSERY SETTING. ROOT FLARE SHALL BE 2" ABOVE FINISH GRADE. REMOVE SOIL FROM TRUNK FLARE OF TREE TO DETERMINE ACTUAL ROOTBALL AREA.
- BACKFILL WITH PLANTING MIX. PLANT MIX TO BE: 50% NATIVE TOPSOIL,
 COMPOST (LEAVES & ORGANIC MATERIAL, NO ASH) 20% PEAT MOSS, 10% SAND.
- 3. ADD MYCORRHIZA SOIL ADDITIVES AND SLOW RELEASE FERTILIZER WHEN PLANT HOLES ARE 50% FILLED AND WATER THOROUGHLY AT COMPLETION.
- 4. SEE MATERIALS PLAN AND DETAILS PLANS FOR STREET TREE PLANTING IN WITH TREE GRATES DETAIL.

DECIDUOUS TREE PLANTING DETAIL NOT TO SCALE

CALE 3

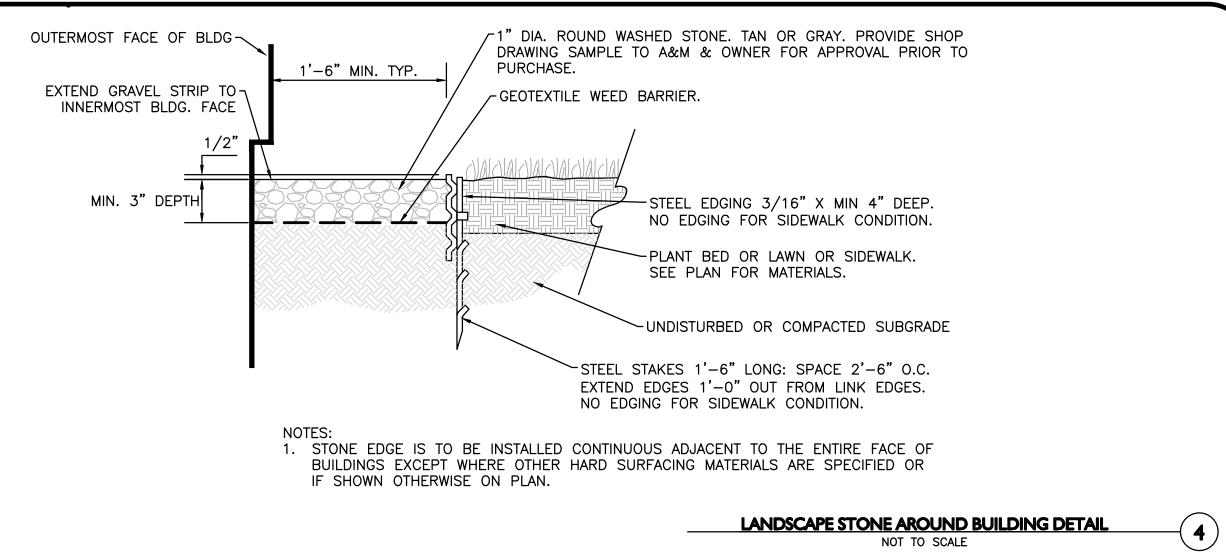

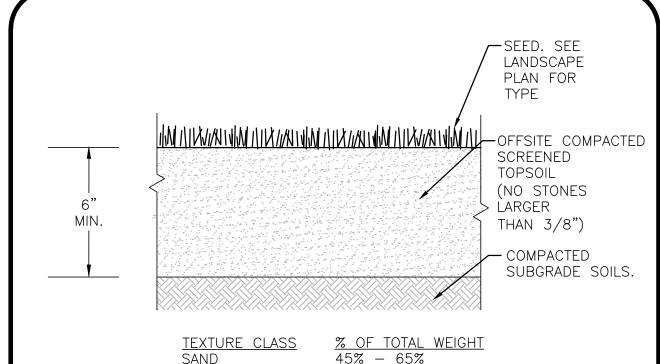

15% - 35%

5% - 20%

SIEVE% PASSING3/8"100NO. 485-100NO. 4060-85NO. 10038-60NO. 20010-3520 umLESS THAN 5%

SILT

CLAY

1. TOP OF LOAM (TOPSOIL) IS FINISH GRADE.

- 2. ALL TOPSOIL (BOTH ONSITE AND OFFSITE SOURCES) SHALL BE COMPOSED OF A NATURAL, FERTILE, FRIABLE SOIL TYPICAL OF CULTIVATED TOPSOILS OF THE LOCALITY. OFFSITE SOIL SHALL BE SUITABLE FOR THE GERMINATION OF SEEDS AND SUPPORT OF VEGETATIVE GROWTH, WITH ADDITIVES, IF REQUIRED, TO ACHIEVE PARTICLE DISTRIBUTION AND ORGANIC CONTENT BELOW. TOPSOIL SHALL BE TAKEN FROM A WELL-DRAINED, ARIABLE SITE, FREE OF SUBSOIL, LARGE STONES, EARTH CLODS, STICKS, STUMPS, CLAY LUMPS, ROOTS, OTHER OBJECTIONABLE, EXTRANEOUS MATTER OR DEBRIS NOR CONTAIN TOXIC SUBSTANCES.
- 3. THE CONTRACTOR SHALL PROVIDE THE OWNER / LANDSCAPE ARCHITECT WITH TOPSOIL TEST RESULTS (RECOMMEND UMASS AMHERST SOIL TESTING LAB) FOR APPROVAL PRIOR TO OBTAINING AND PLACING THE SOIL. IF ANY TOPSOIL IS PURCHASED OR PLACED PRIOR TO APPROVAL BY OWNER / LANDSCAPE ARCHITECT, IT IS AT CONTRACTORS RISK, AND IT CAN BE REMOVED AT NO ADDITIONAL COST TO THE OWNER. IF THE PLANTING SOIL (BOTH ONSITE AND OFFSITE SOURCES) DOES NOT FALL WITHIN THE REQUIRED SIEVE ANALYSIS, TEXTURAL CLASS, ORGANIC CONTENT, OR PH RANGE, IT SHALL BE ADJUSTED TO MEET THE SPECIFICATIONS THROUGH THE ADDITION OF SAND, COMPOST, LIMESTONE, OR ALUMINUM SULFATE TO BRING IT WITHIN THE SPECIFIED LIMITS AT NO ADDITIONAL COST TO THE OWNER.
- 4. TOPSOIL SHALL HAVE A PH VALUE BETWEEN 5.5 AND 6.5. TOPSOIL SHALL CONTAIN BETWEEN 4% AND 8% ORGANIC MATTER OF TOTAL DRY WEIGHT AND SHALL CONFORM TO THE FOLLOWING GRADATION AND TEXTURE CLASS ABOVE.

TOPSOIL FOR LAWN, TREES, SHRUBS, & PERENNIALS


NOT TO SCALE

NOTES:

1. ALL SHRUBS SHALL HAVE THE SAME RELATIONSHIP TO FINISH GRADE AFTER PLANTING AS THEY HAD AT THE ORIGINAL NURSERY SETTING. SET SHRUB 1"-2" ABOVE FINISH GRADE.

2. BACKFILL WITH PLANTING MIX. PLANT MIX TO BE: 50% NATIVE TOPSOIL, 20% COMPOST (LEAVES & ORGANIC MATERIAL, NO ASH) 20% PEAT MOSS, 10% SAND

3. ADD MYCORRHIZA SOIL ADDITIVES AND SLOW RELEASE FERTILIZER WHEN PLANT HOLES ARE 50% FILLED AND WATER THOROUGHLY AT COMPLETION.
4. SHRUB BEDS TO HAVE 24" MIN. OF CONTINUOUS PLANTING SOIL.

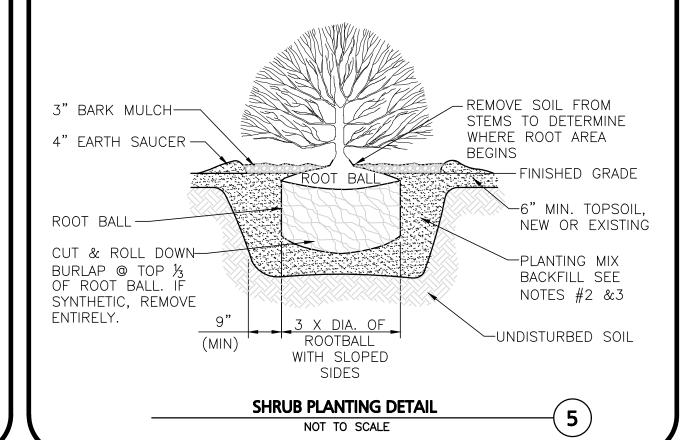

LOAM AND SEEDING NOTES:

CONTRACTOR SHALL SEED ALL DISTURBED AREAS NOT NOTED TO RECEIVE OTHER MATERIALS, AND AT AREAS SHOWN ON THE PLAN PER SPECIFICATIONS BELOW

SCIENTIFIC NAME	COMMON NAME PRO	OPORTION	PERCENT	PERCENT
	BY	WEIGHT	<u>PURITY</u>	<u>GERMINATION</u>
FESTUCA RUBRA "RUBRA"	CREEPING RED FESCUE	37%	95%	90%
PAO PRAENTENSIS "BARON"	BARON KENTUCKY BLUEGRASS	40%	85%	90%
LOLIUM PERENNE "PALMER"	PALMER PERENNIAL RYEGRASS	15%	95%	90%
FESTUCA RUBRA COMMUTATA WILMA	WILMA CHEWINGS	8%	95%	80%

1. SEED TO BE SPREAD AT MINIMUM RATE OF 5 LBS. PER 1000 SQ. FT.

2. SEEDING TO BE COMPLETED "IN SEASON" BETWEEN APRIL 1 TO JUNE 15 OR AUGUST 15 TO OCTOBER 1, EXCEPT FOR RESEEDING OF BARE SPOTS. IF UNABLE TO SEED WITHIN THESE TIMEFRAMES, CONTRACTOR TO INSTALL EROSION CONTROL MATS ON ALL SLOPES 3:1 AND OVER, HYDROSEED ALL EXPOSED AREAS, ADD SOIL STABILIZER "FLUX TERRA HP-FGM SOIL STABILIZER" AS MANUFACTURED BY "PROFILE" TO HYDROSEED (AT RATE OF 3,000 LBS PER ACRE), AT NO ADDITIONAL COST TO THE OWNER. CONTRACTOR TO COMPLETE ALL ABOVE "OUT OF SEASON" REQUIREMENTS AND THEN ALSO BE RESPONSIBLE FOR RE-GRADING AND RE-SEEDING ALL DISTURBED, ERODED, OR BARE SPOTS WITHIN NEXT CLOSEST PLANTING SEASON IN FALL OR SPRING AT NO ADDITIONAL COST TO OWNER. CONTRACTOR RESPONSIBLE FOR ALL MAINTENANCE UNTIL FINAL ACCEPTANCE OF LAWN AREAS INCLUDING: WATERING, ADDING FERTILIZERS AND LIME AND MOWING AT NO ADDITIONAL COST TO OWNER.

3. COMMERCIAL FERTILIZER SHALL BE APPLIED AT THE RATE OF 25 POUNDS PER 1000 SQ. FT. OR AS RECOMMENDED BY THE TESTING AGENCY. LIME TO BE SPREAD AT THE RATE OF 100 POUNDS PER 1000 SQ. FT OR AS RECOMMENDED BY THE TESTING AGENCY. COMMERCIAL FERTILIZER SHALL BE A COMPLETE FERTILIZER CONTAINING AT LEAST 50% OF THE NITROGEN OF WHICH IS DERIVED FROM NATURAL ORGANIZE SOURCES OF UREAFORM. IT SHALL CONTAIN THE FOLLOWING PERCENTAGES BY WEIGHT: NITROGEN (N) 10%, PHOSPHORUS (P) 6%, POTASH (K) 4%. LIME SHALL BE AN APPROVED AGRICULTURAL LIMESTONE CONTAINING NOT LESS THAN 85% OF TOTAL CARBONATES. LIMESTONE SHALL BE GROUND TO SUCH FINENESS THAT 50% WILL PASS A 100 MESH SIEVE AND 90% WILL PASS THROUGH A 20 MESH SIEVE.

4.LAWN AREAS TO BE SEEDED BY SOWING EVENLY WITH AN APPROVED MECHANICAL SEEDER AT THE RATE OF TEN POUNDS PER 1000 SQUARE

5. CONTRACTOR RESPONSIBLE FOR WATERING, MOWING, AND RESEEDING OF LAWN BARE SPOTS UNTIL A UNIFORM, HEALTHY STAND OF GRASS IS ESTABLISHED AND ACCEPTED.

PROGRESS PRINT
ISSUED FOR REVIEW

PROFESSIONAL ENGINEER FOR ALLEN & MAJOR ASSOCIATES, INC.

REV DATE DESCRIPTION

APPICANT:

APEX DESIGN BUILD 9550 W. HIGGINS ROAD. SUITE 170 ROSEMONT, IL 60018

PROJE

SURGICAL CENTER
360 CORPORATE DRIVE
TAX MAP 315, LOT 5
PORTSMOUTH, NH 03801

 PROJECT NO.
 3250-01
 DATE:
 07-24-23

 SCALE:
 AS SHOWN
 DWG. NAME: C-3250-01.dwg

DESIGNED BY:

PREPARED BY:

CHECKED BY:



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nvironmental consulting • landscape architecture
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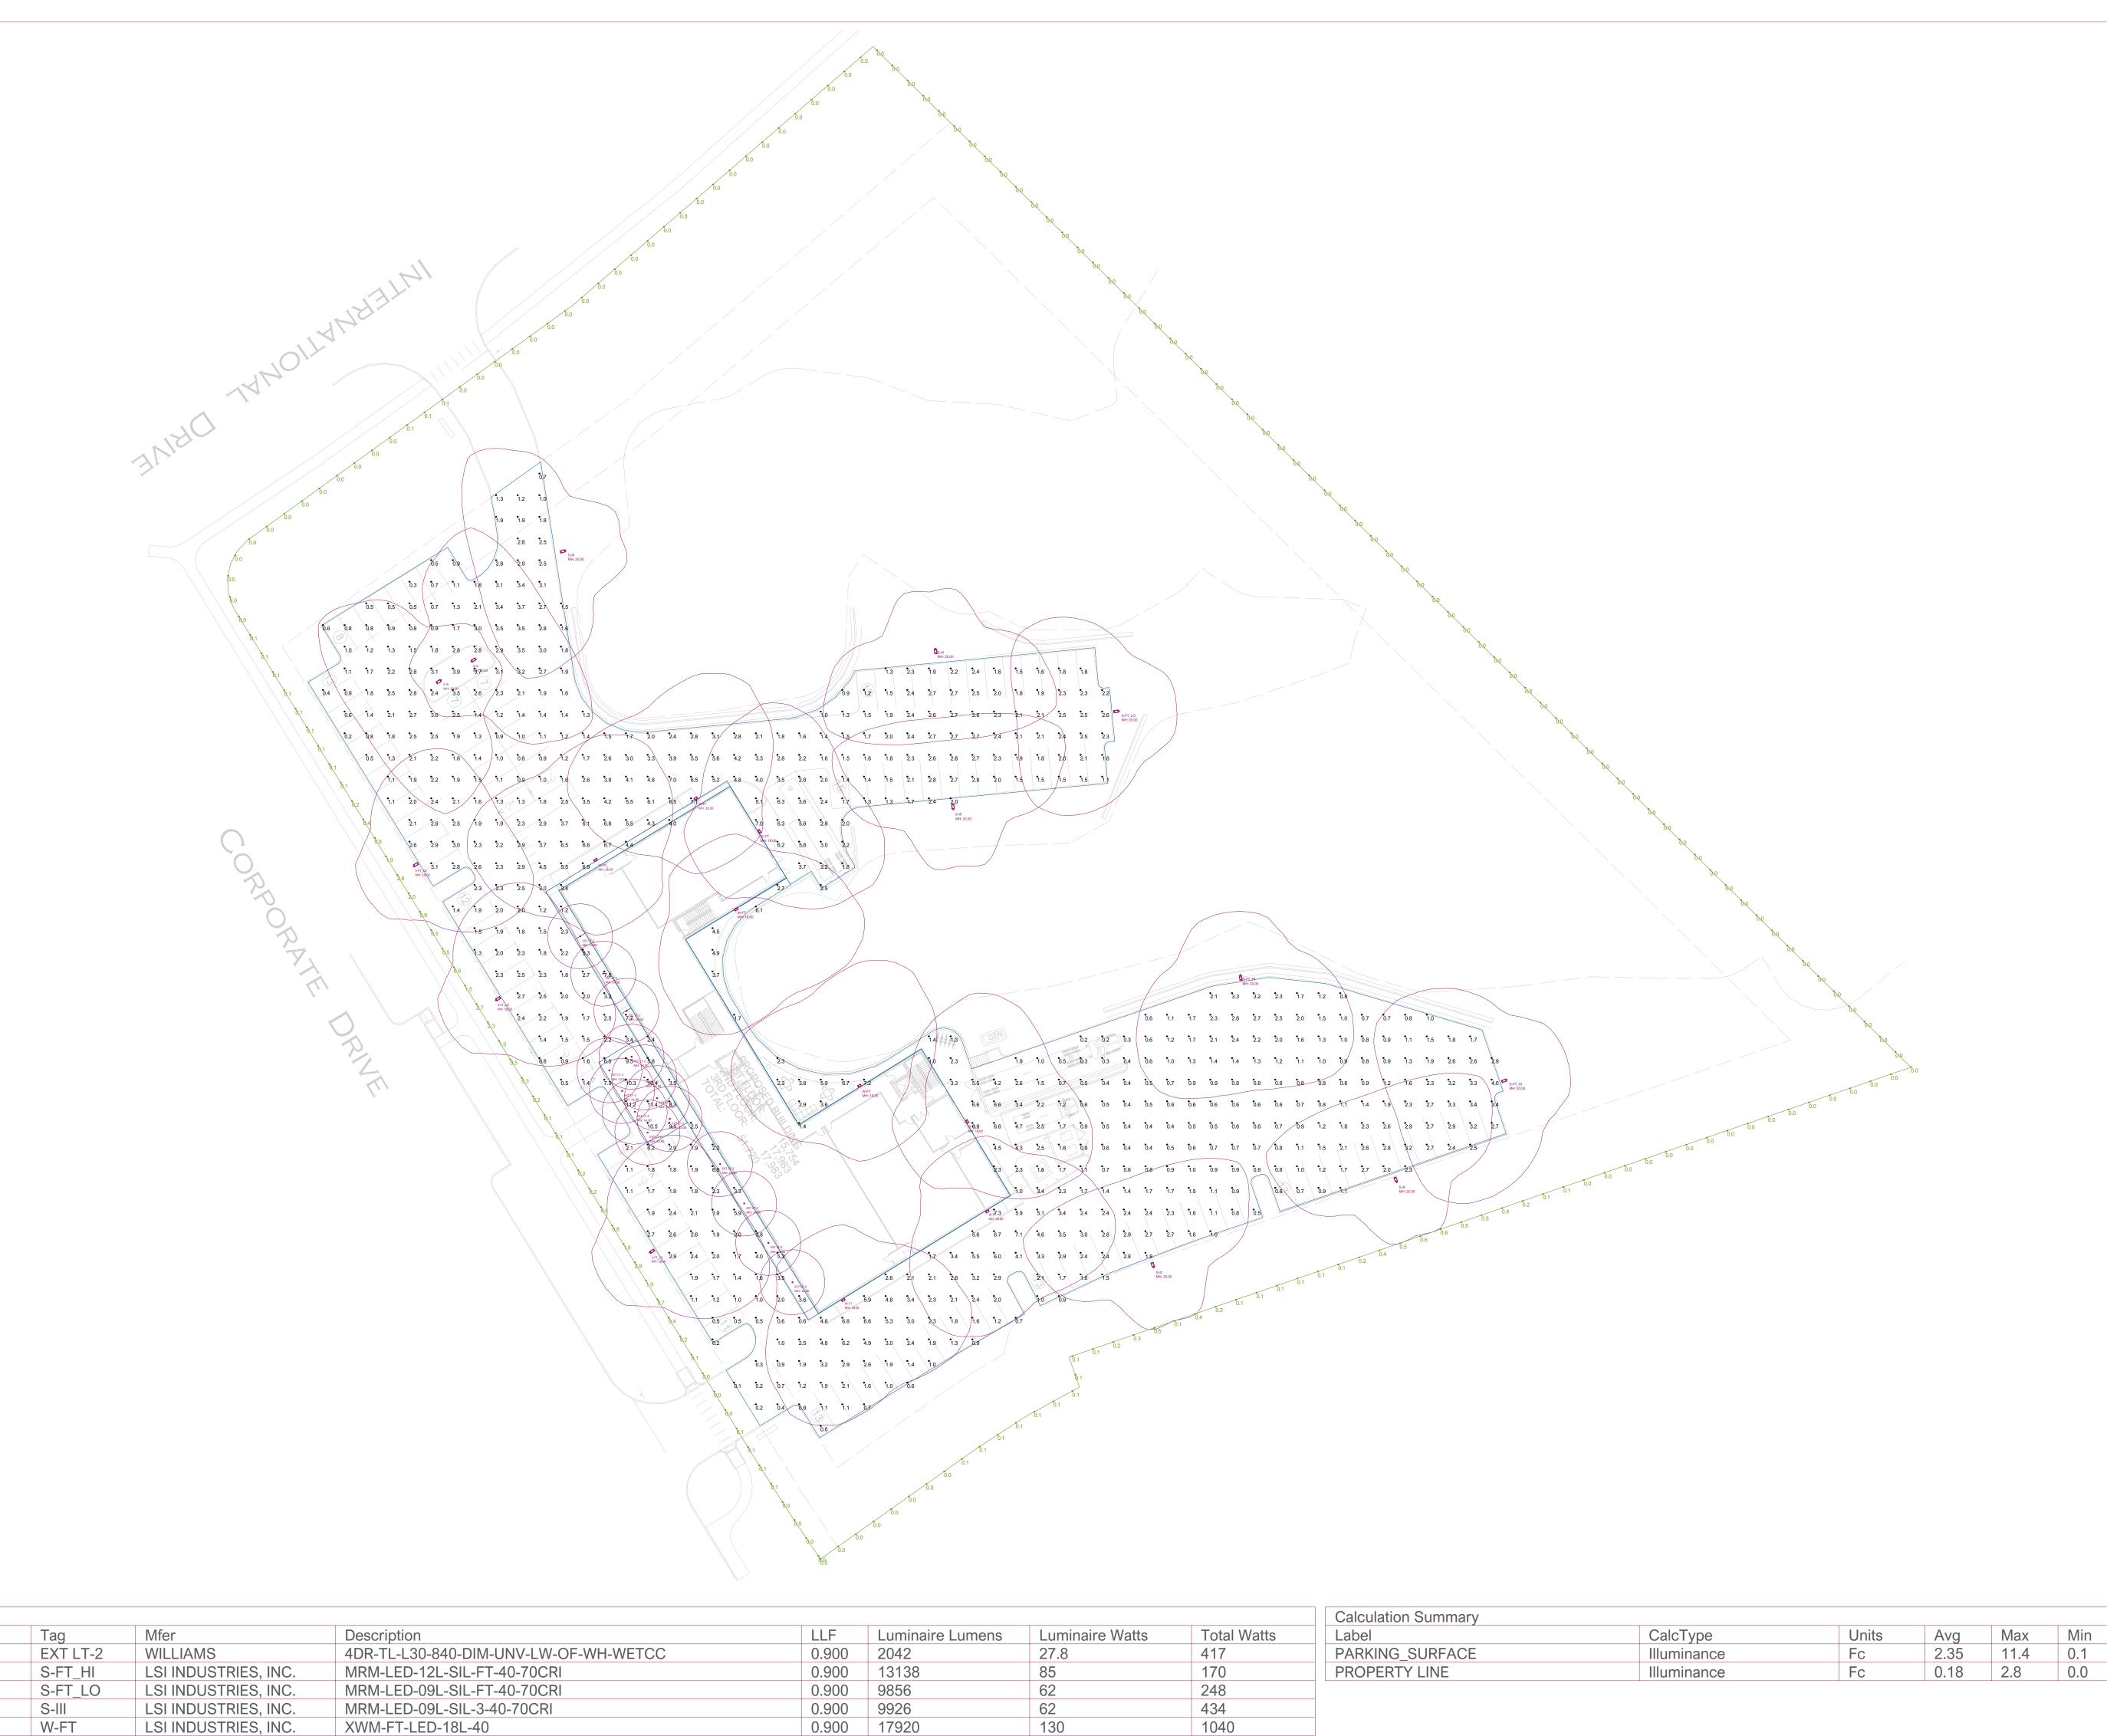
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Luminaire Schedule

15

Symbol



Photometric calculations are being provided to the recipient per the following disclaimers. This light level analysis is an estimate only, and is based on standard interior reflectance values of 0.8 ceilings, 0.5 walls, and 0.2 floors, unless otherwise specified. Any variance from reflectance values, obstructions, light loss factors or dimensional data will affect the actual light levels obtained. This analysis is a mathematical model and can only be as accurate as is permitted by the third party software and the IES files provided by our manufacturers.

Ema	Chris Collins mail: ccollins@amirep.com				
REVISIONS			•		
	DATE				
	#				

Calculation Date:6/19/2023

Max/Min

114.00

N.A.

Scale: NTS Page 1 of 1

SUBCONTRACTOR NOTES

- A. PROVIDE WEATHER BARRIER OVER ALL EXTERIOR SHEATHING PRIOR TO THE INSTALLATION OF ANY EXTERIOR FINISH MATERIAL.
- B. INSTALL PER MANUFACTURER'S SPECIFICATIONS
 AND PROVIDE ALL MANUFACTURER'S
 ACCESSORIES TO FULLY FLASH AND COUNTERFLASH AT ALL WINDOWS, DOORS, AND EXTERIOR PENETRATIONS.
- C. PROVIDE A WEATHER TIGHT BARRIER AT ALL SURFACES.
- D. COORDINATE FLASHING WITH WINDOW, DOOR,
 VENT, ETC. MANUFACTURER'S FOR A WEATHER
 TIGHT SEAL AT ALL OPENINGS.
 E. TAPE FLASH AROUND ALL OPENINGS AND ON
 WALL JOINTS PER MANUFACTURER
 REQUIREMENTS.

EXTERIOR FINISH SCHEDULE

1. EQUAL PRODUCTS ARE ACCPETABLE AFTER IT HAS BEEN SUBMITTED & APPROVED BY ARCHITECT.

2. ALL PRODUCTS TO BE INSTALLED PER MANUFACTURER REQUIREMENTS

TAG	MATERIAL	MFG.	SPECIFICATION / DESCRIPTION	LOCATION	REMARKS
EXT. AP-1	ACM PANEL	STACBOND	ACM PANEL, SEE ELEVATIONS FOR DIMENSOINS, FINISH: DUSTY GREY	PER ELEVATIONS	SEE ELEVATIONS FOR DIMENISONS
EXT. AP-2	ACM PANEL	STACBOND	ACM PANEL, SEE ELEVATIONS FOR DIMENSOINS, FINISH: ANTHRACITE GREY	PER ELEVATIONS	SEE ELEVATIONS FOR DIMENISONS
EXT. BR-1	FACE BRICK	SPAULDING BRICK	STAINED BRICK, COLOR: TBD	PER ELEVATIONS	
EXT. CP-1	METAL COPING	PACCLAD	PACCLAD PAC-TITE COPING:FLAT, FINISH: MUSKET GRAY, 4' O.C.	PER ELEVATIONS	SEE ELEVATIONS FOR DIMENISONS
EXT. CS-1	STONE SILL	ROCKCAST	BY ROCKCAST, SL-7315, FINISH:	PER ELEVATIONS	
EXT. MP-1	EXPOSED FASTNER METAL PANEL	PACCLAD	PACCLAD PETERSON M-36 WITH TRIMS, FINISH: MUSKET GREY	PER ELEVATIONS	



9550 W.Higgins Rd. 170 Rosemont, IL 60018

DR. ALEX SLOCUM

360 CORPORATE DR. PORTSMOUTH , NH 03801

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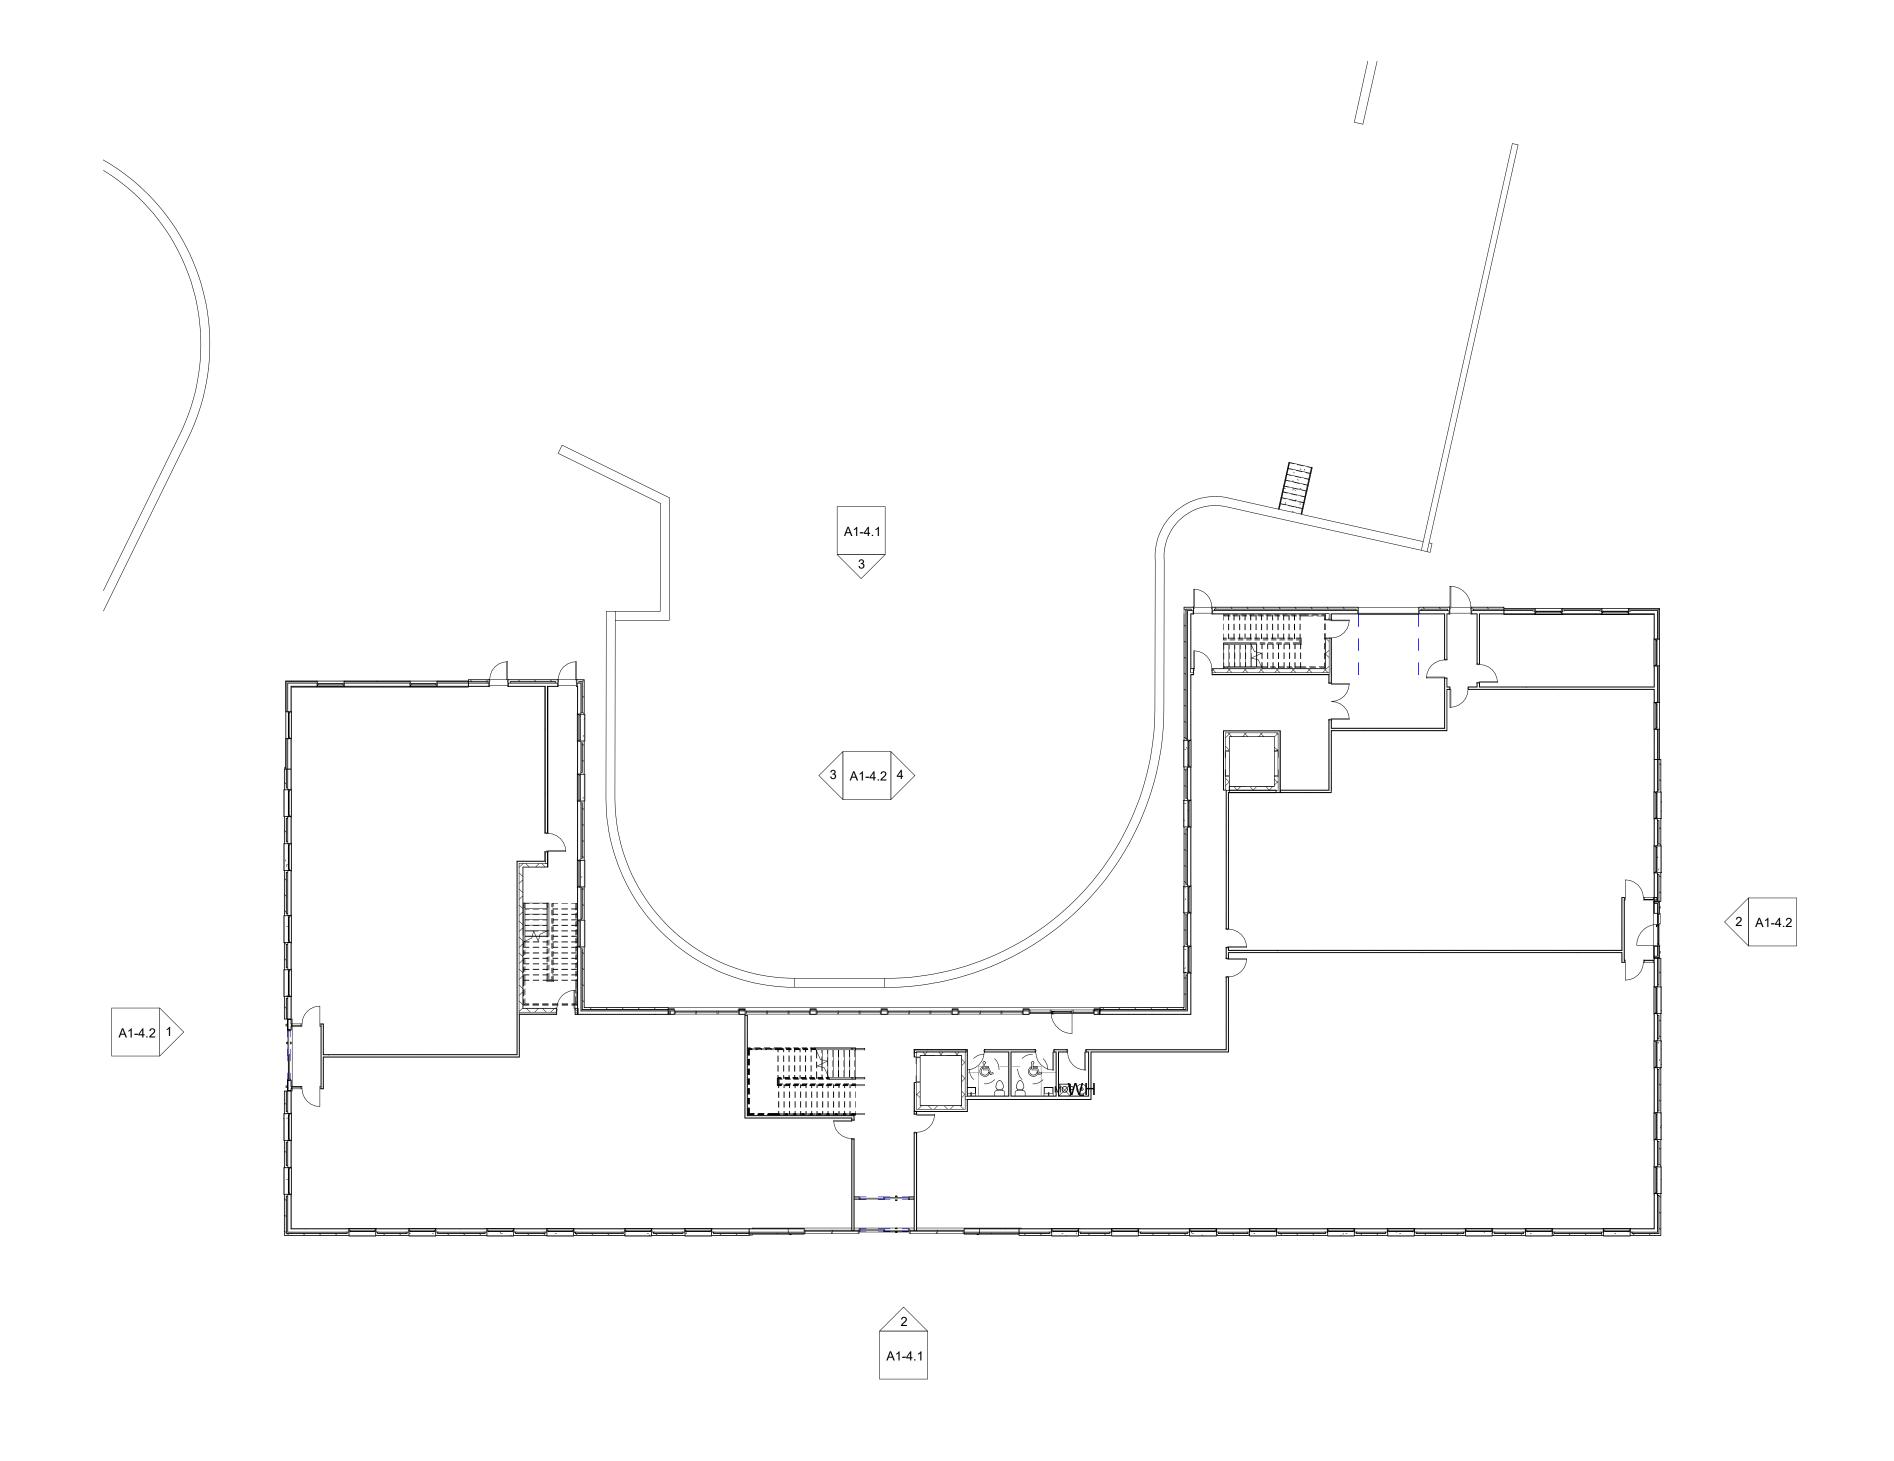
No.	Description	Date
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EXTERIOR
SCHEDULES

Project number

A1-2

12" = 1'-0"



OVERALL FLOOR PLAN - KEY PLAN

1/16" = 1'-0" NOTE: IF DRAWING IS PRINTED @ 11X17 SCALE TO BE REDUCED BY 50%



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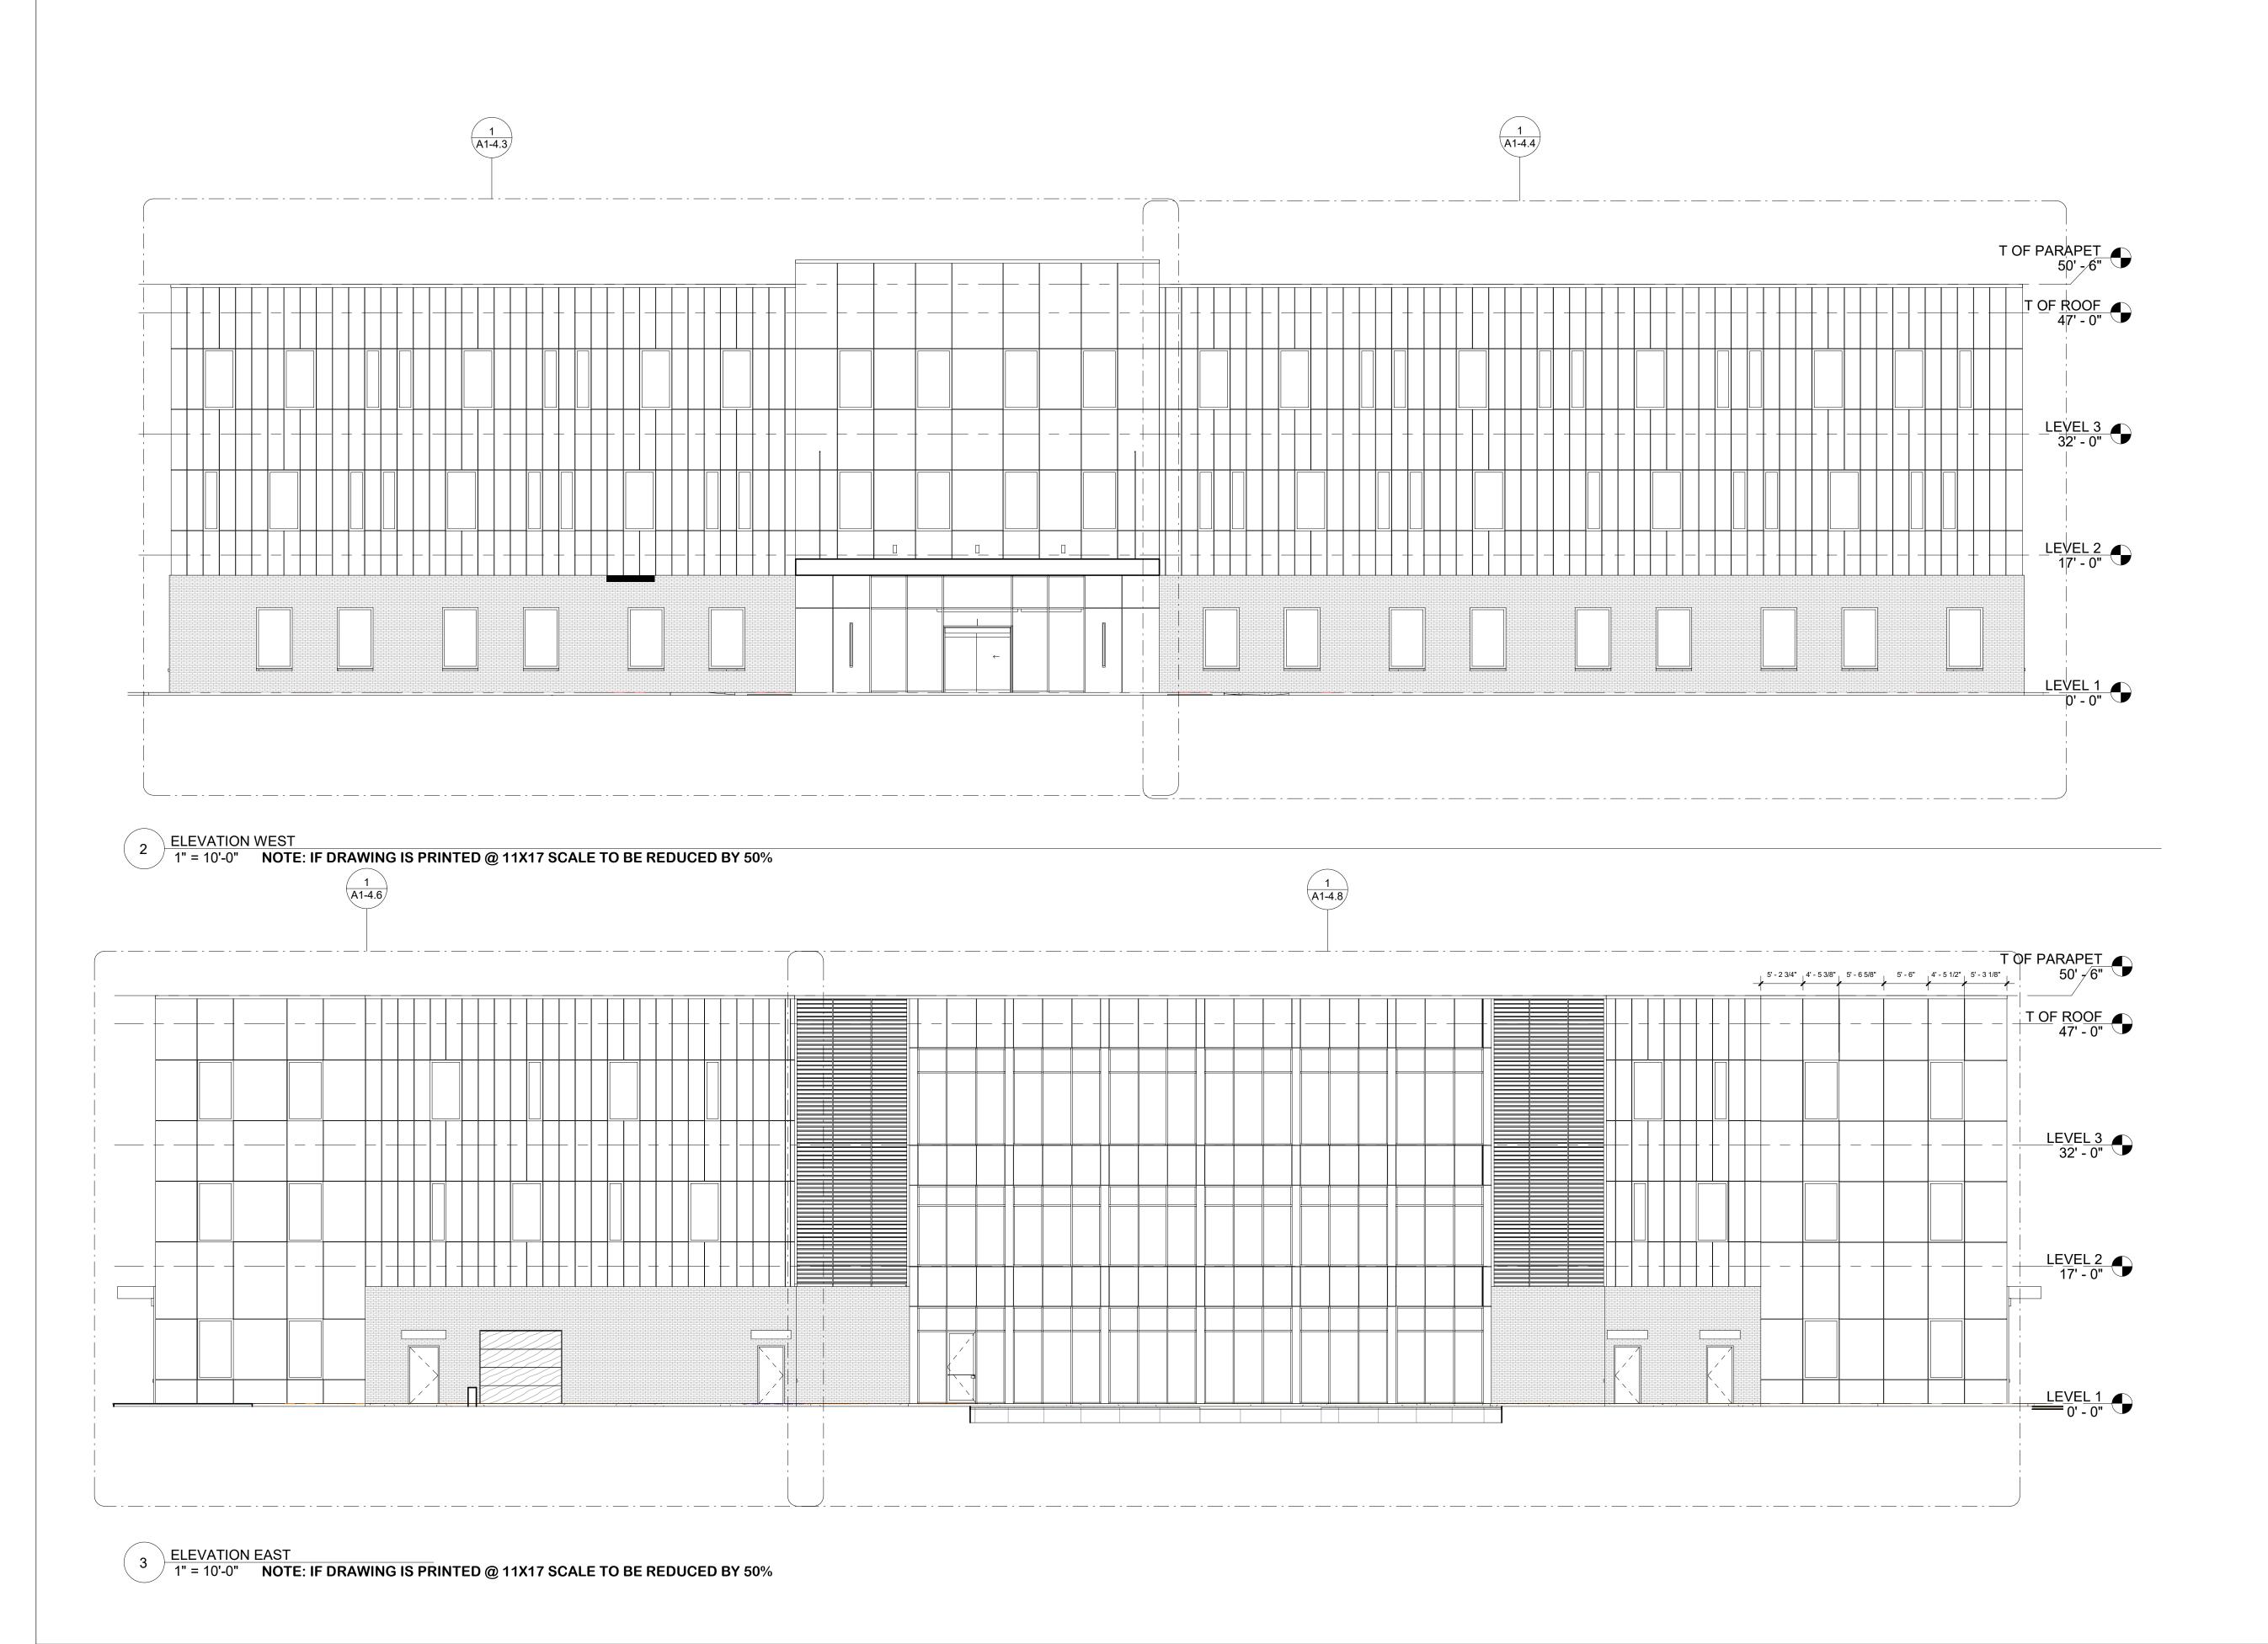
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EXTER	RIOR
VIEWS	KEY

Project number

A1-3

Scale



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9550 W.Higgins Rd. 170 Rosemont, IL 60018

DR. ALEX SLOCUM

360 CORPORATE DR. PORTSMOUTH , NH 03801

CLIENT APPROVAL

☐ APPROVED AS SHOWN

☐ APPROVED WITH CHANGES

I UNDERSTAND ANY CHANGES HEREIN WILL RESULT IN ADDITIONAL COSTS AND TIME EXTENSIONS

SIGNATURE:

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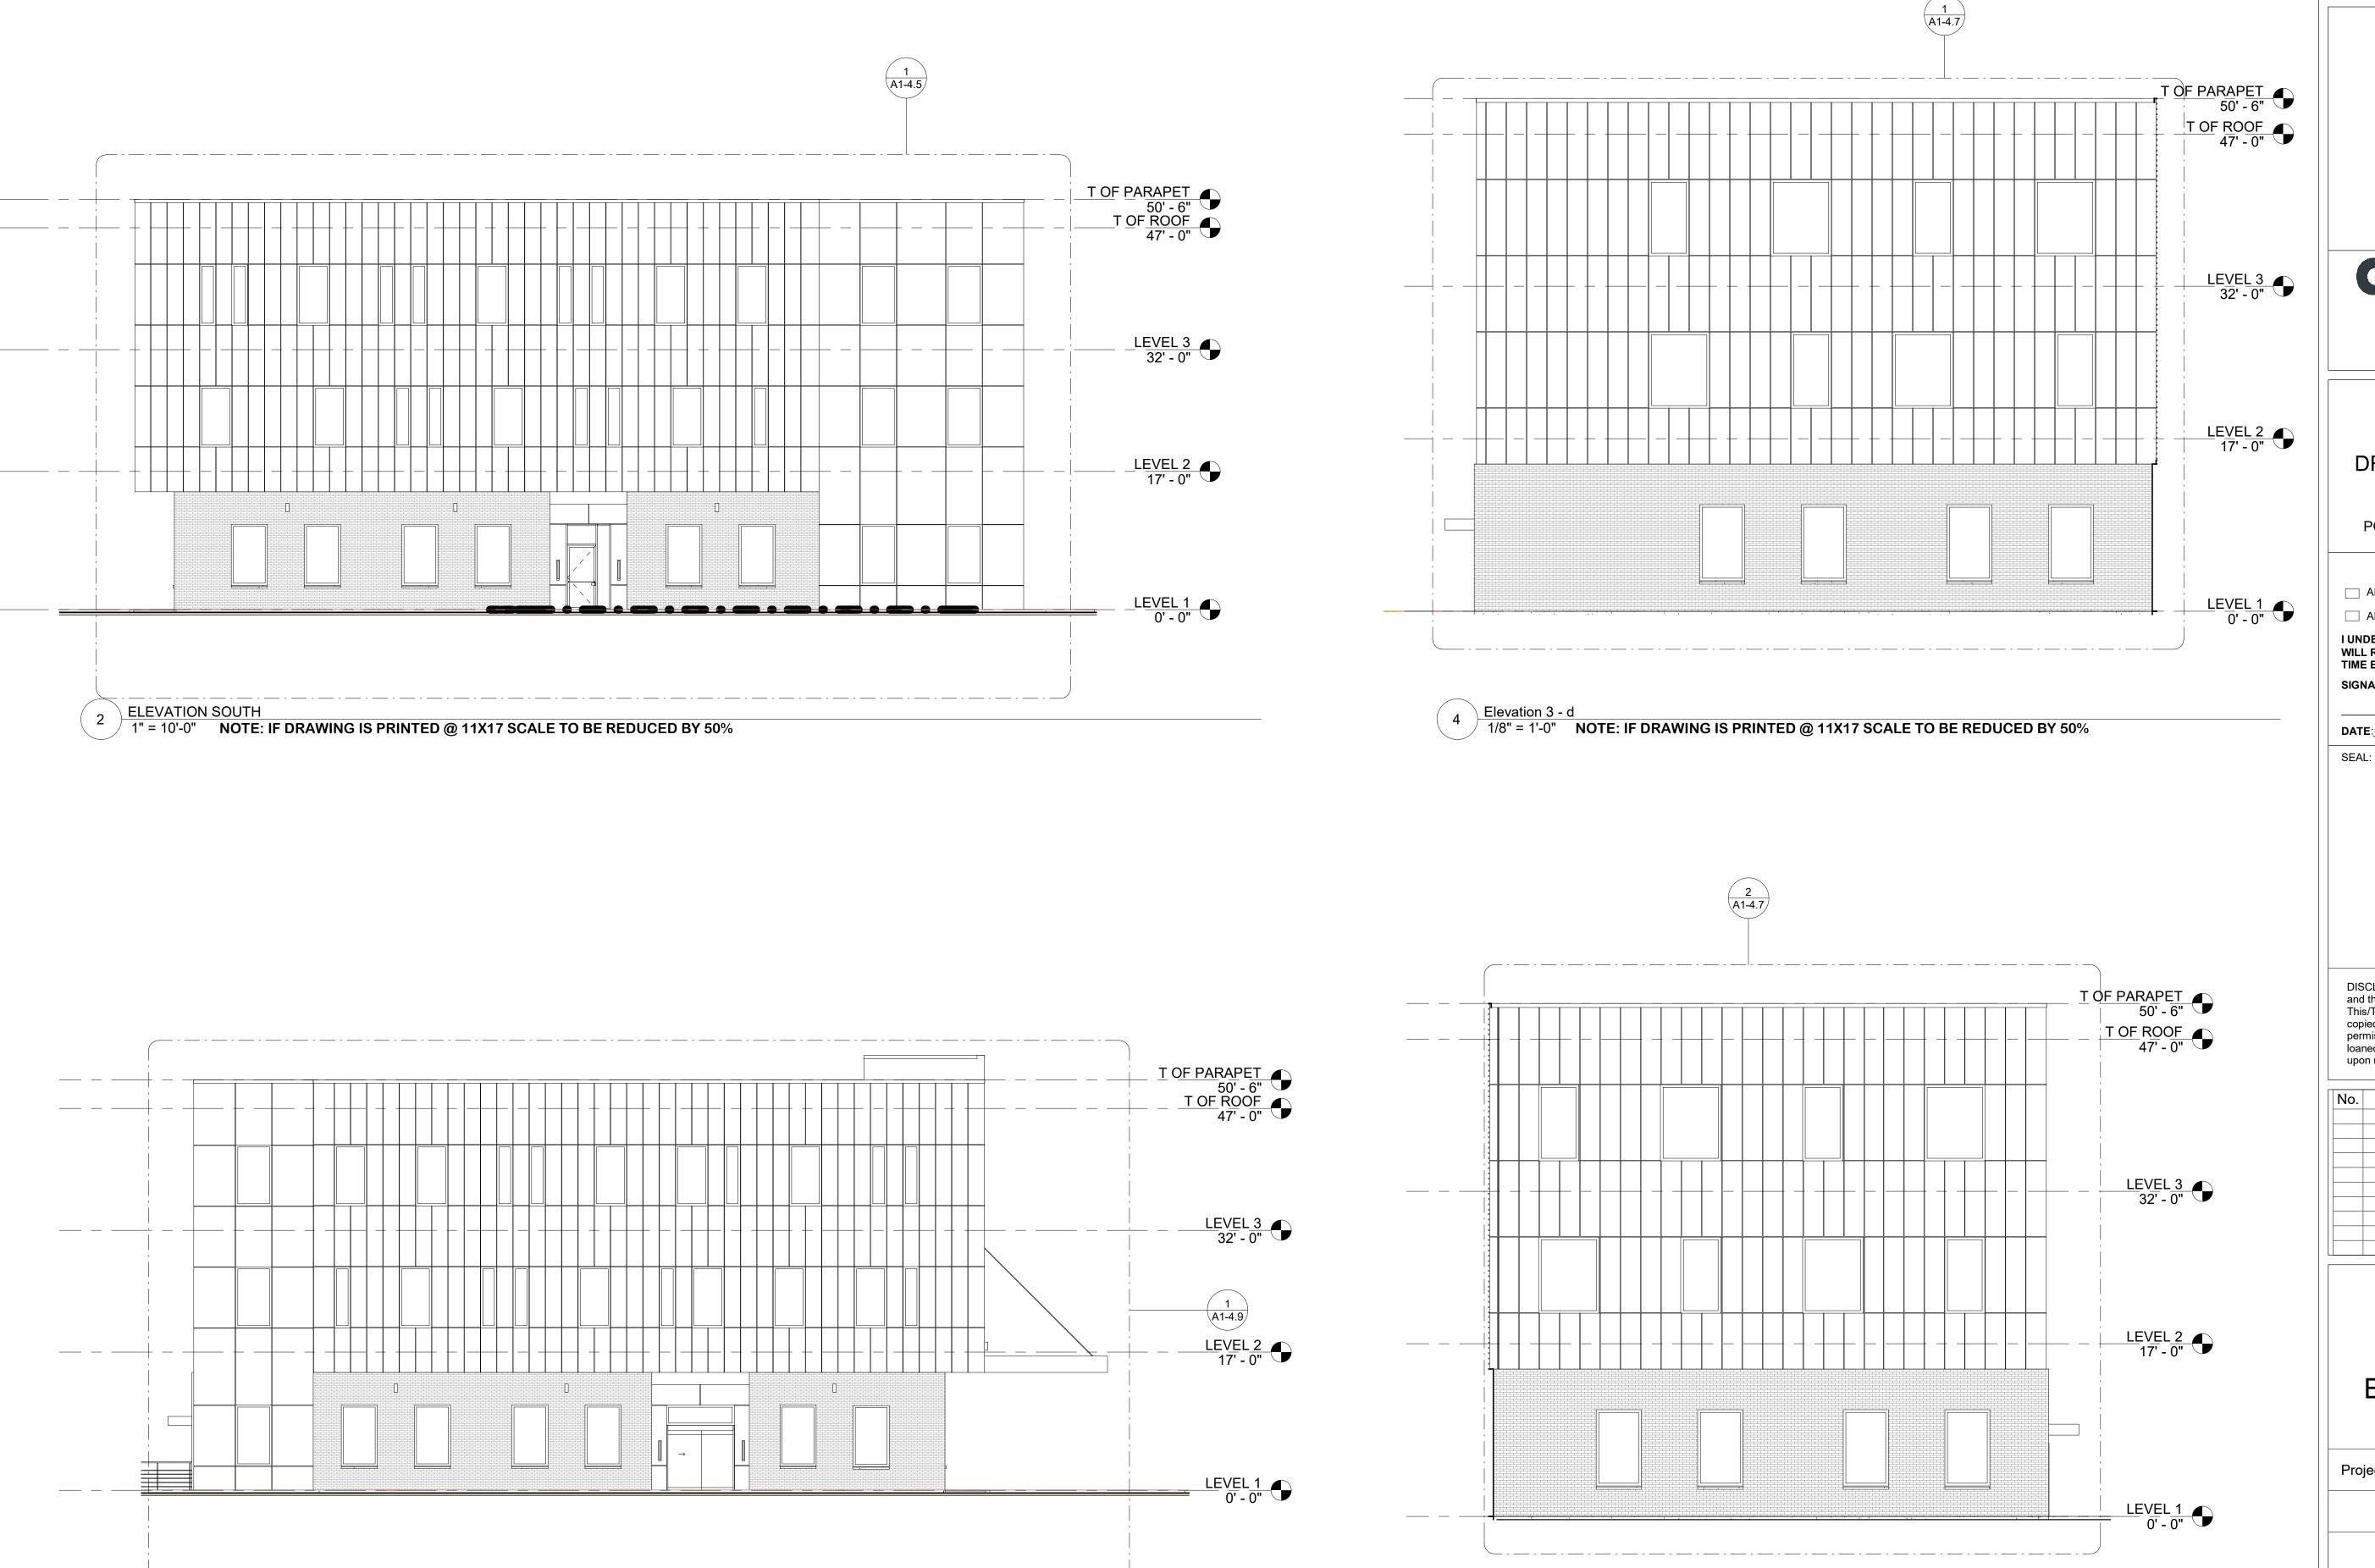
OVERALL EXTERIOR ELEVATIONS

Project number

A1-4.1

Scale

1" = 10'-0"



ELEVATION NORTH

1" = 10'-0" NOTE: IF DRAWING IS PRINTED @ 11X17 SCALE TO BE REDUCED BY 50%

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CLIENT APPROVAL

APPROVED AS SHOWN

APPROVED WITH CHANGES
I UNDERSTAND ANY CHANGES HEREIN WILL RESULT IN ADDITIONAL COSTS AND TIME EXTENSIONS
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OVERALL EXTERIOR ELEVATIONS


Project number


A1-4.2

Scale As indicated

Elevation 3 - b

1/8" = 1'-0" NOTE: IF DRAWING IS PRINTED @ 11X17 SCALE TO BE REDUCED BY 50%

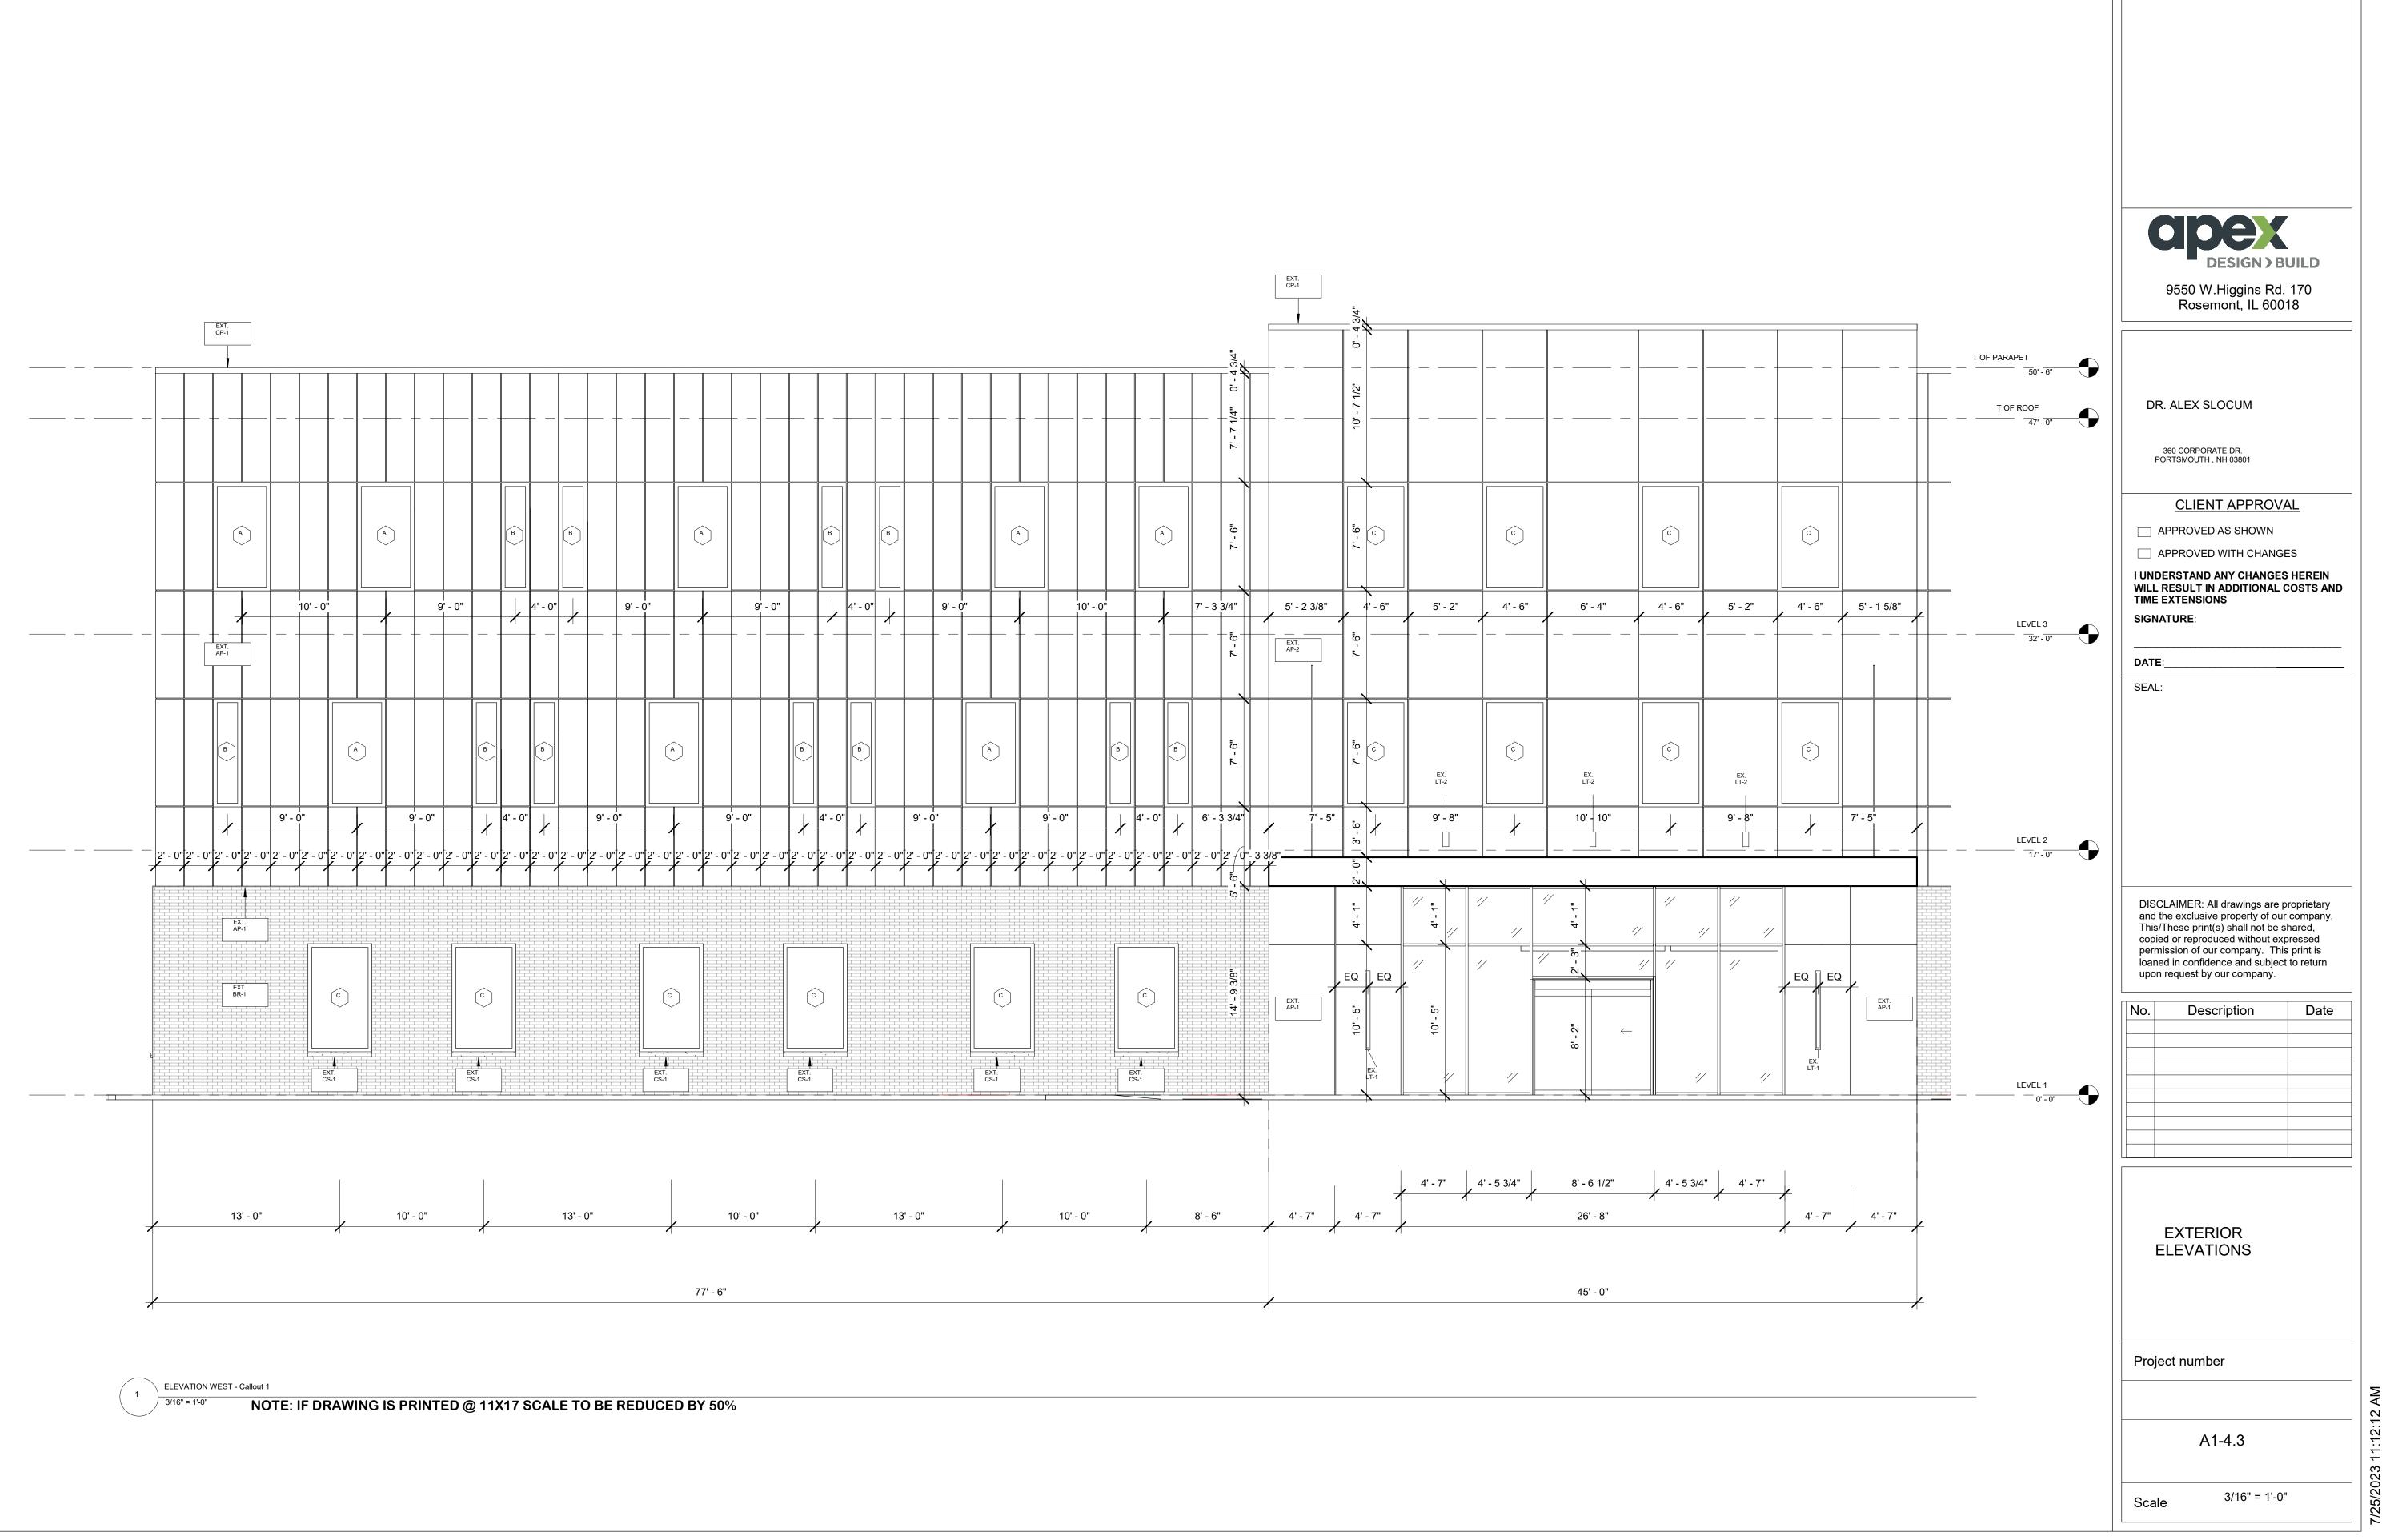

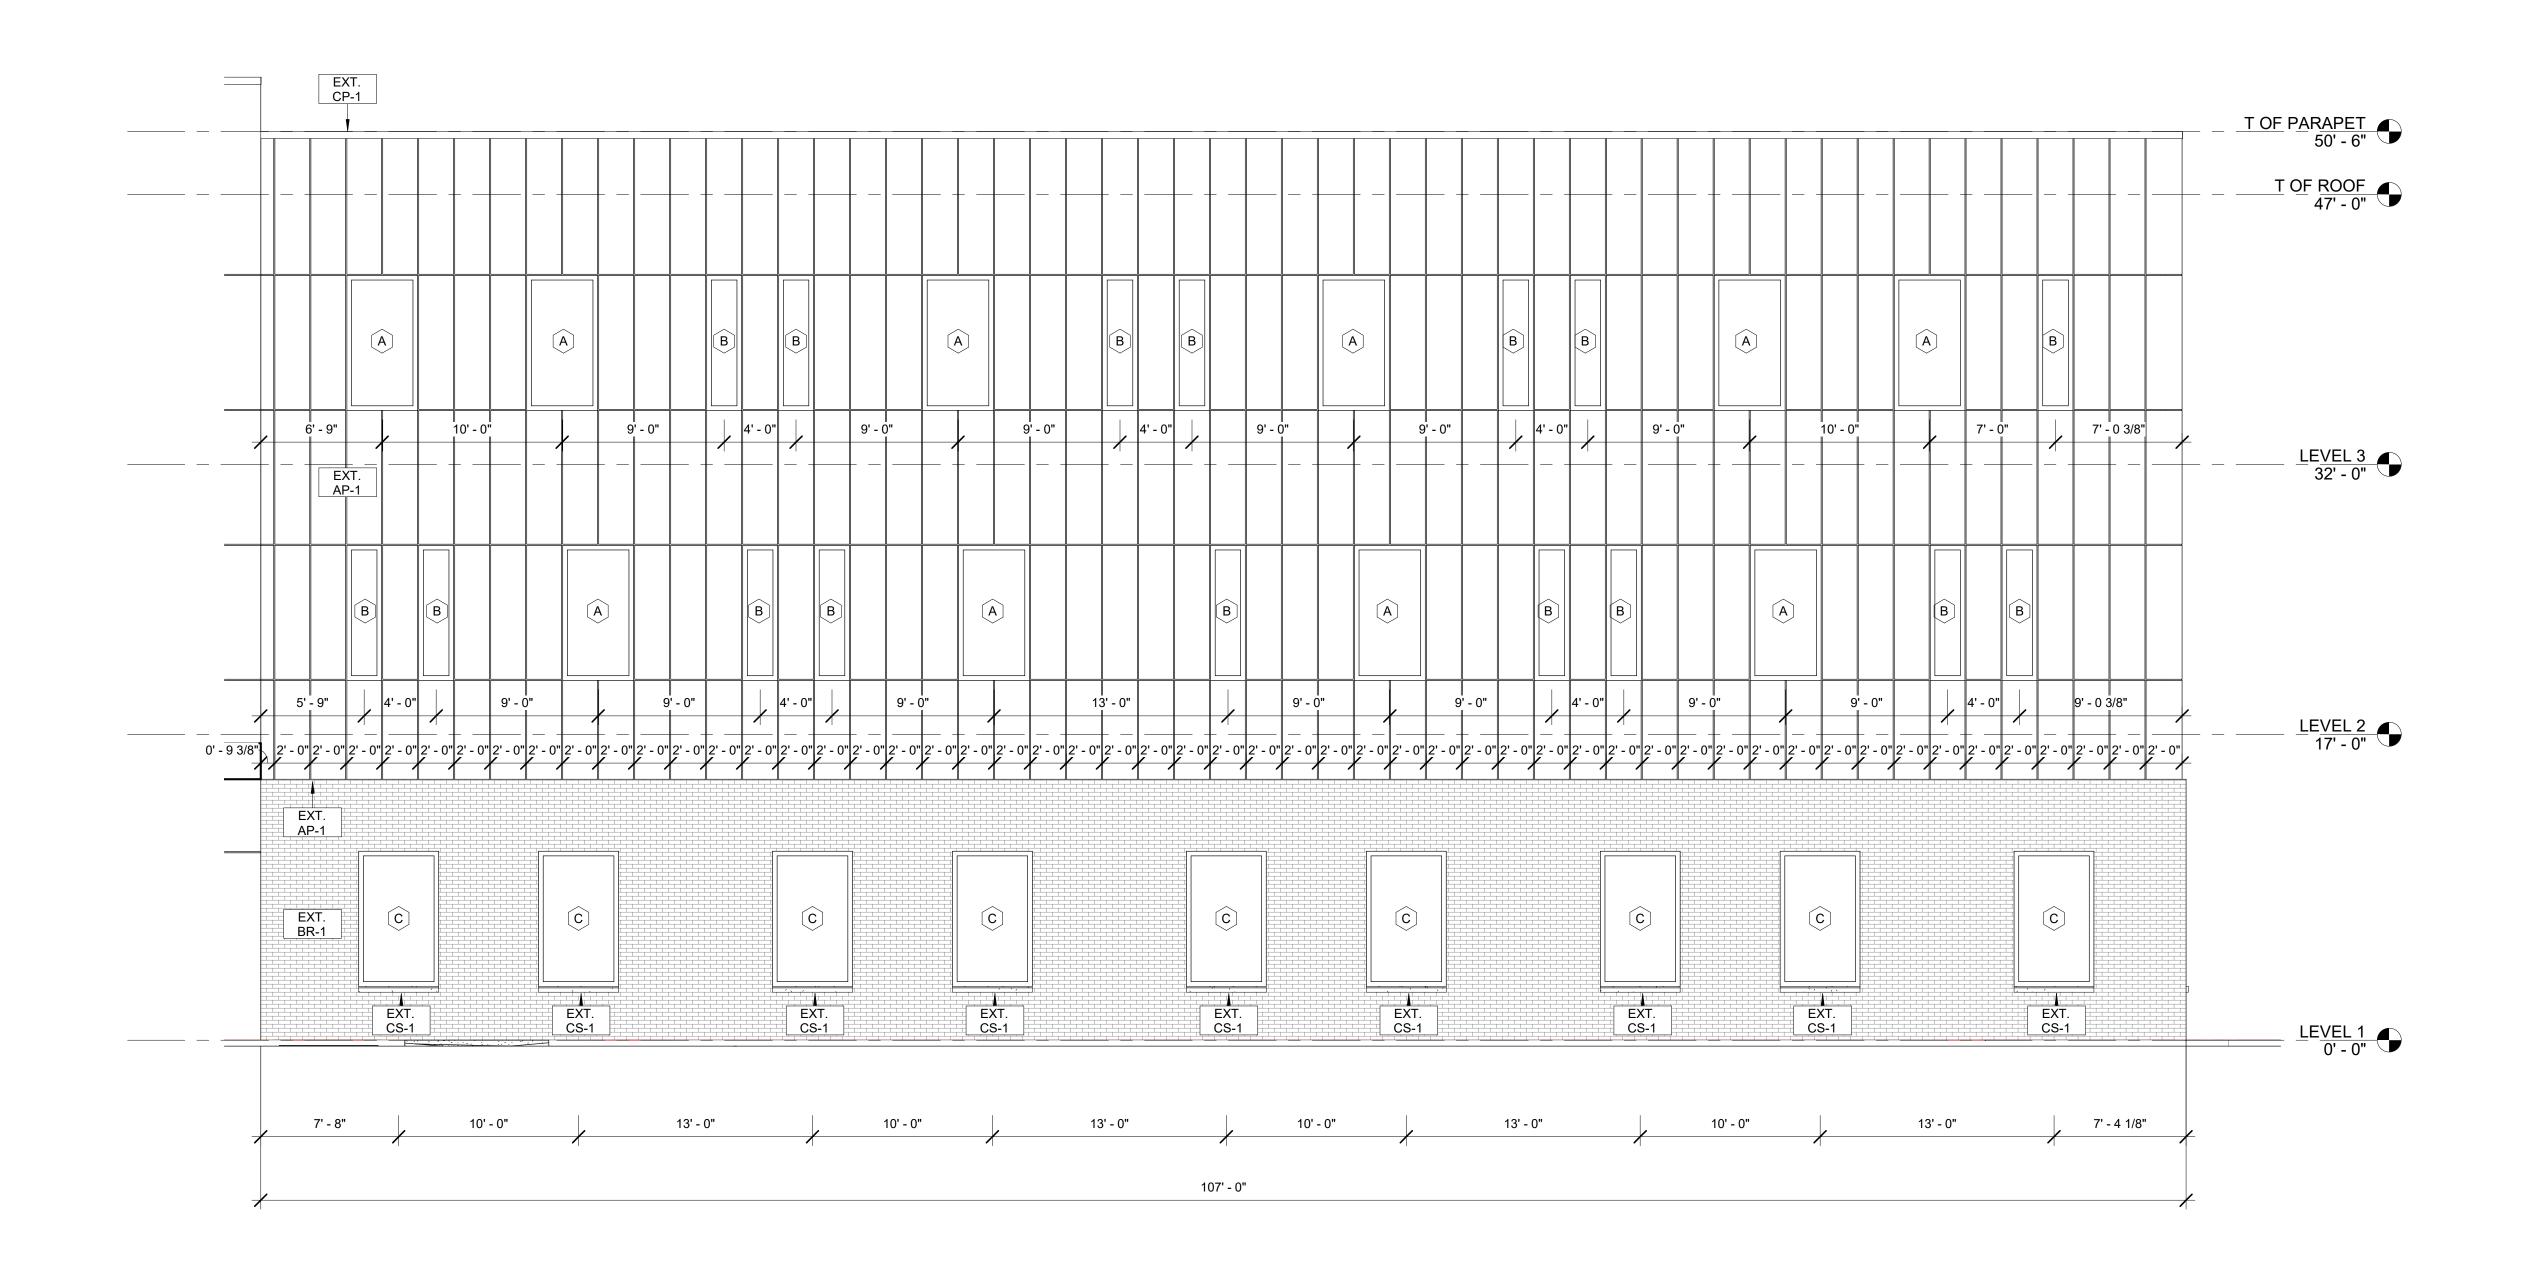

ELEVATION WEST - Callout 2
3/16" = 1'-0" NOTE: IF DRAWING IS PRINTED @ 11X17 SCALE TO BE REDUCED BY 50%

CIPEX DESIGN > BUILL

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DR. ALEX SLOCUM

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CLIENT APPROVAL

APPROVED AS SHOWN

APPROVED WITH CHANGES

I UNDERSTAND ANY CHANGES HEREIN WILL RESULT IN ADDITIONAL COSTS AND TIME EXTENSIONS

SIGNATURE:

DATE:__

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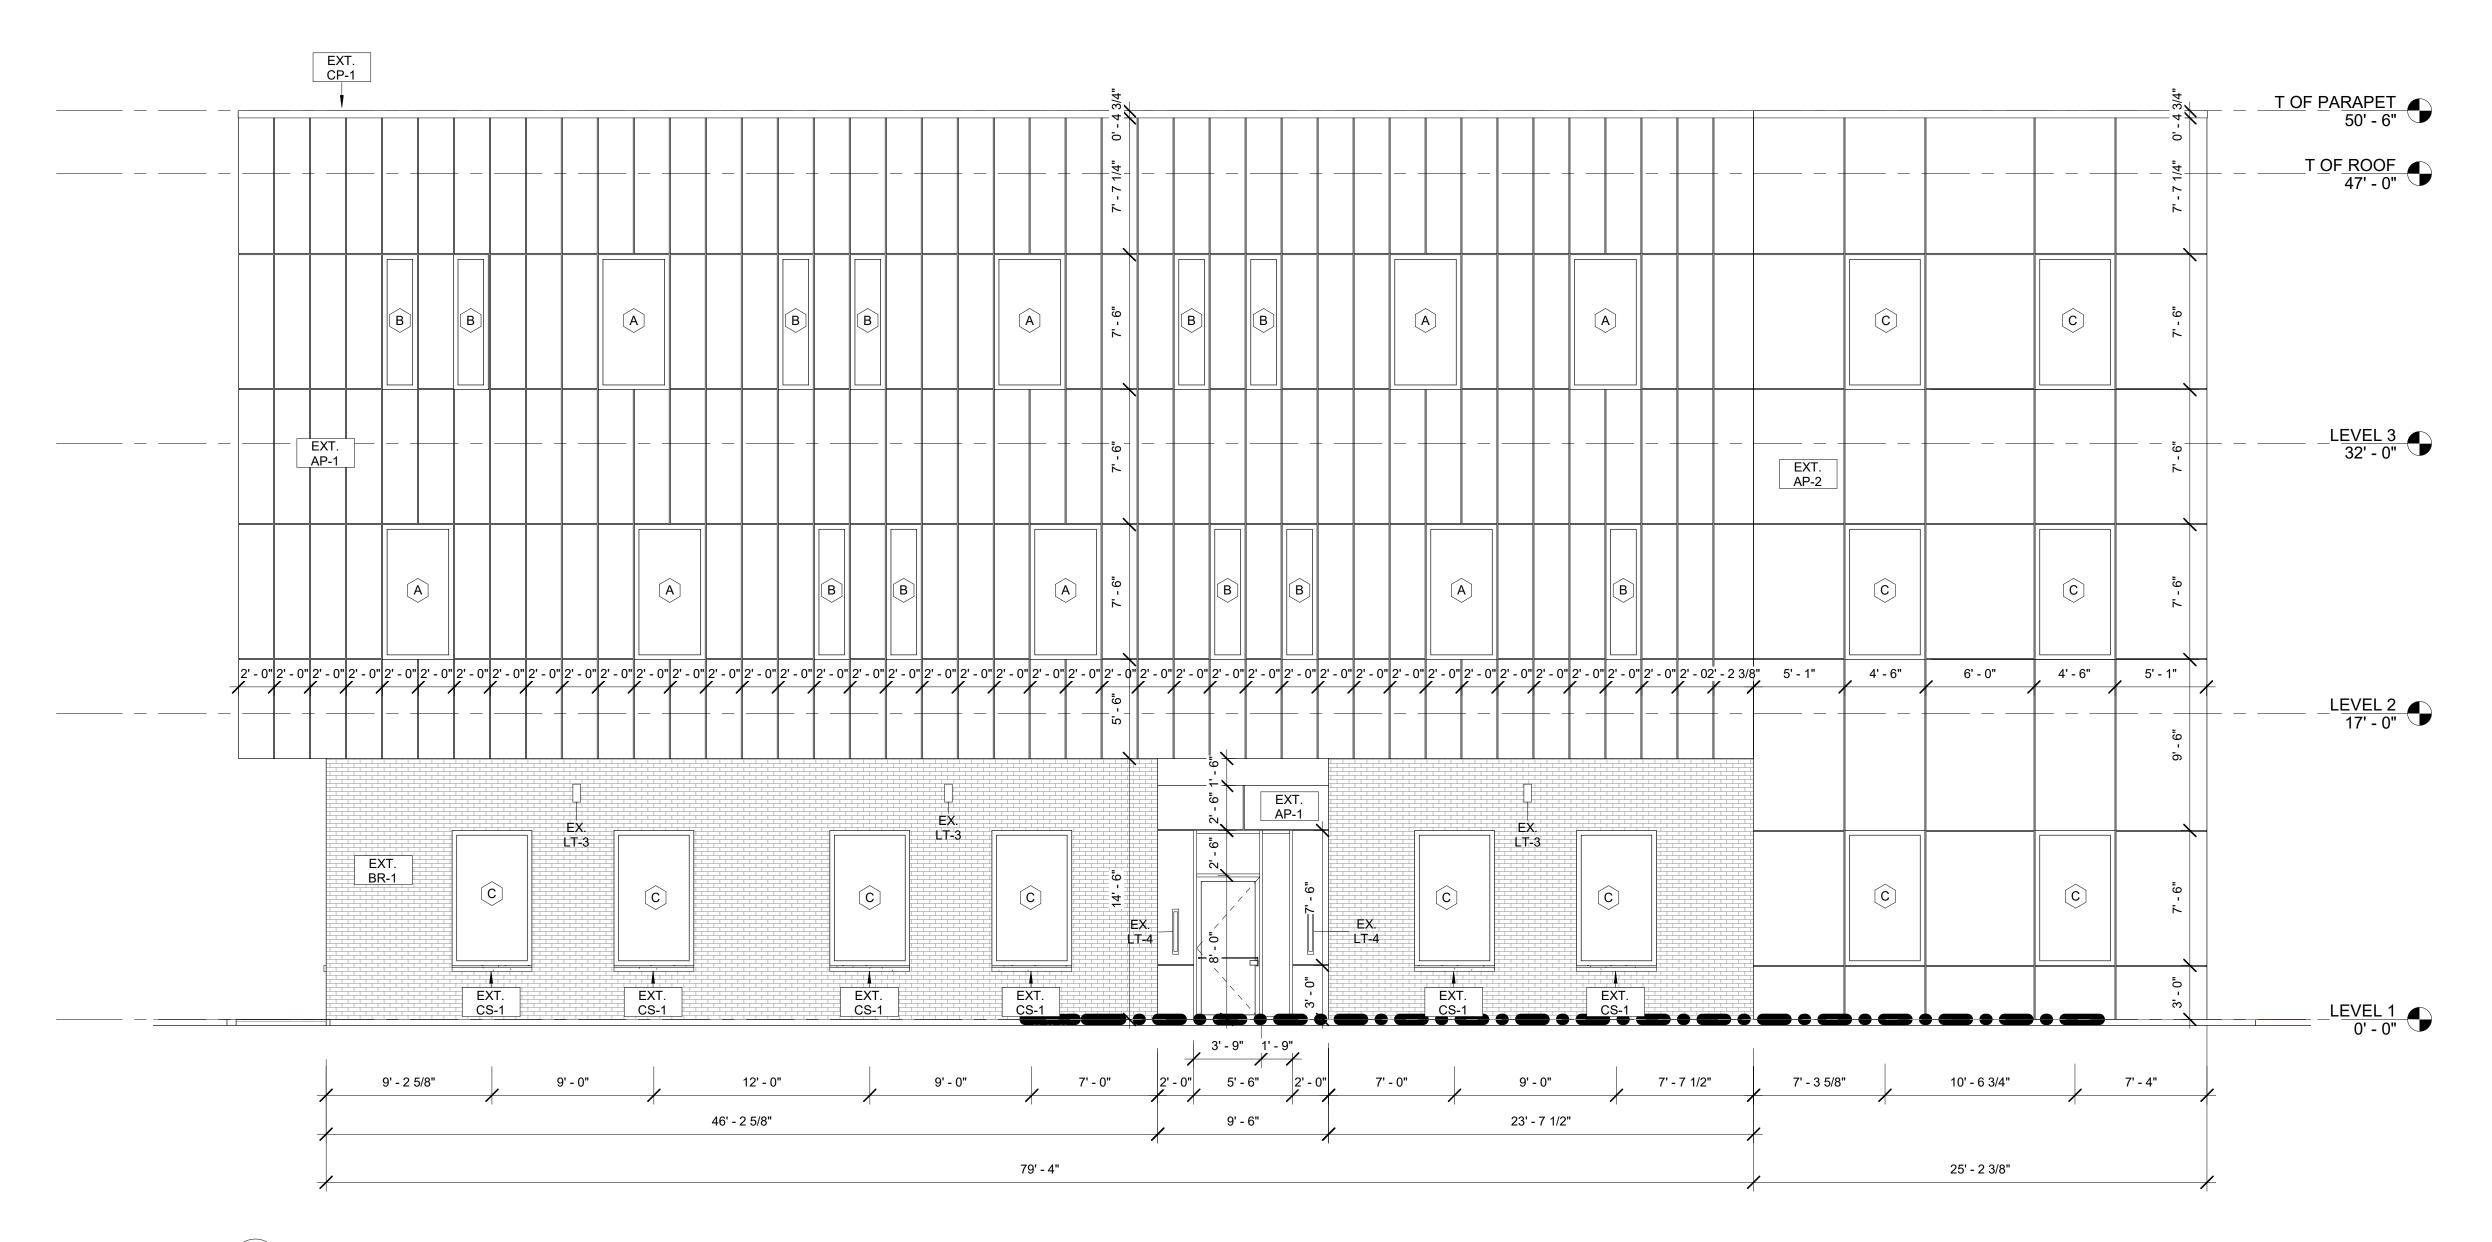
No.	Description	Date

EXTERIOR ELEVATIONS

Project number

A1-4.4

Scale



1 ELEVATION SOUTH - Callout 1
3/16" = 1'-0" NOTE: IF DRAWING IS PRINTED @ 11X17 SCALE TO BE REDUCED BY 50%



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DR. ALEX SLOCUM

360 CORPORATE DR. PORTSMOUTH , NH 03801

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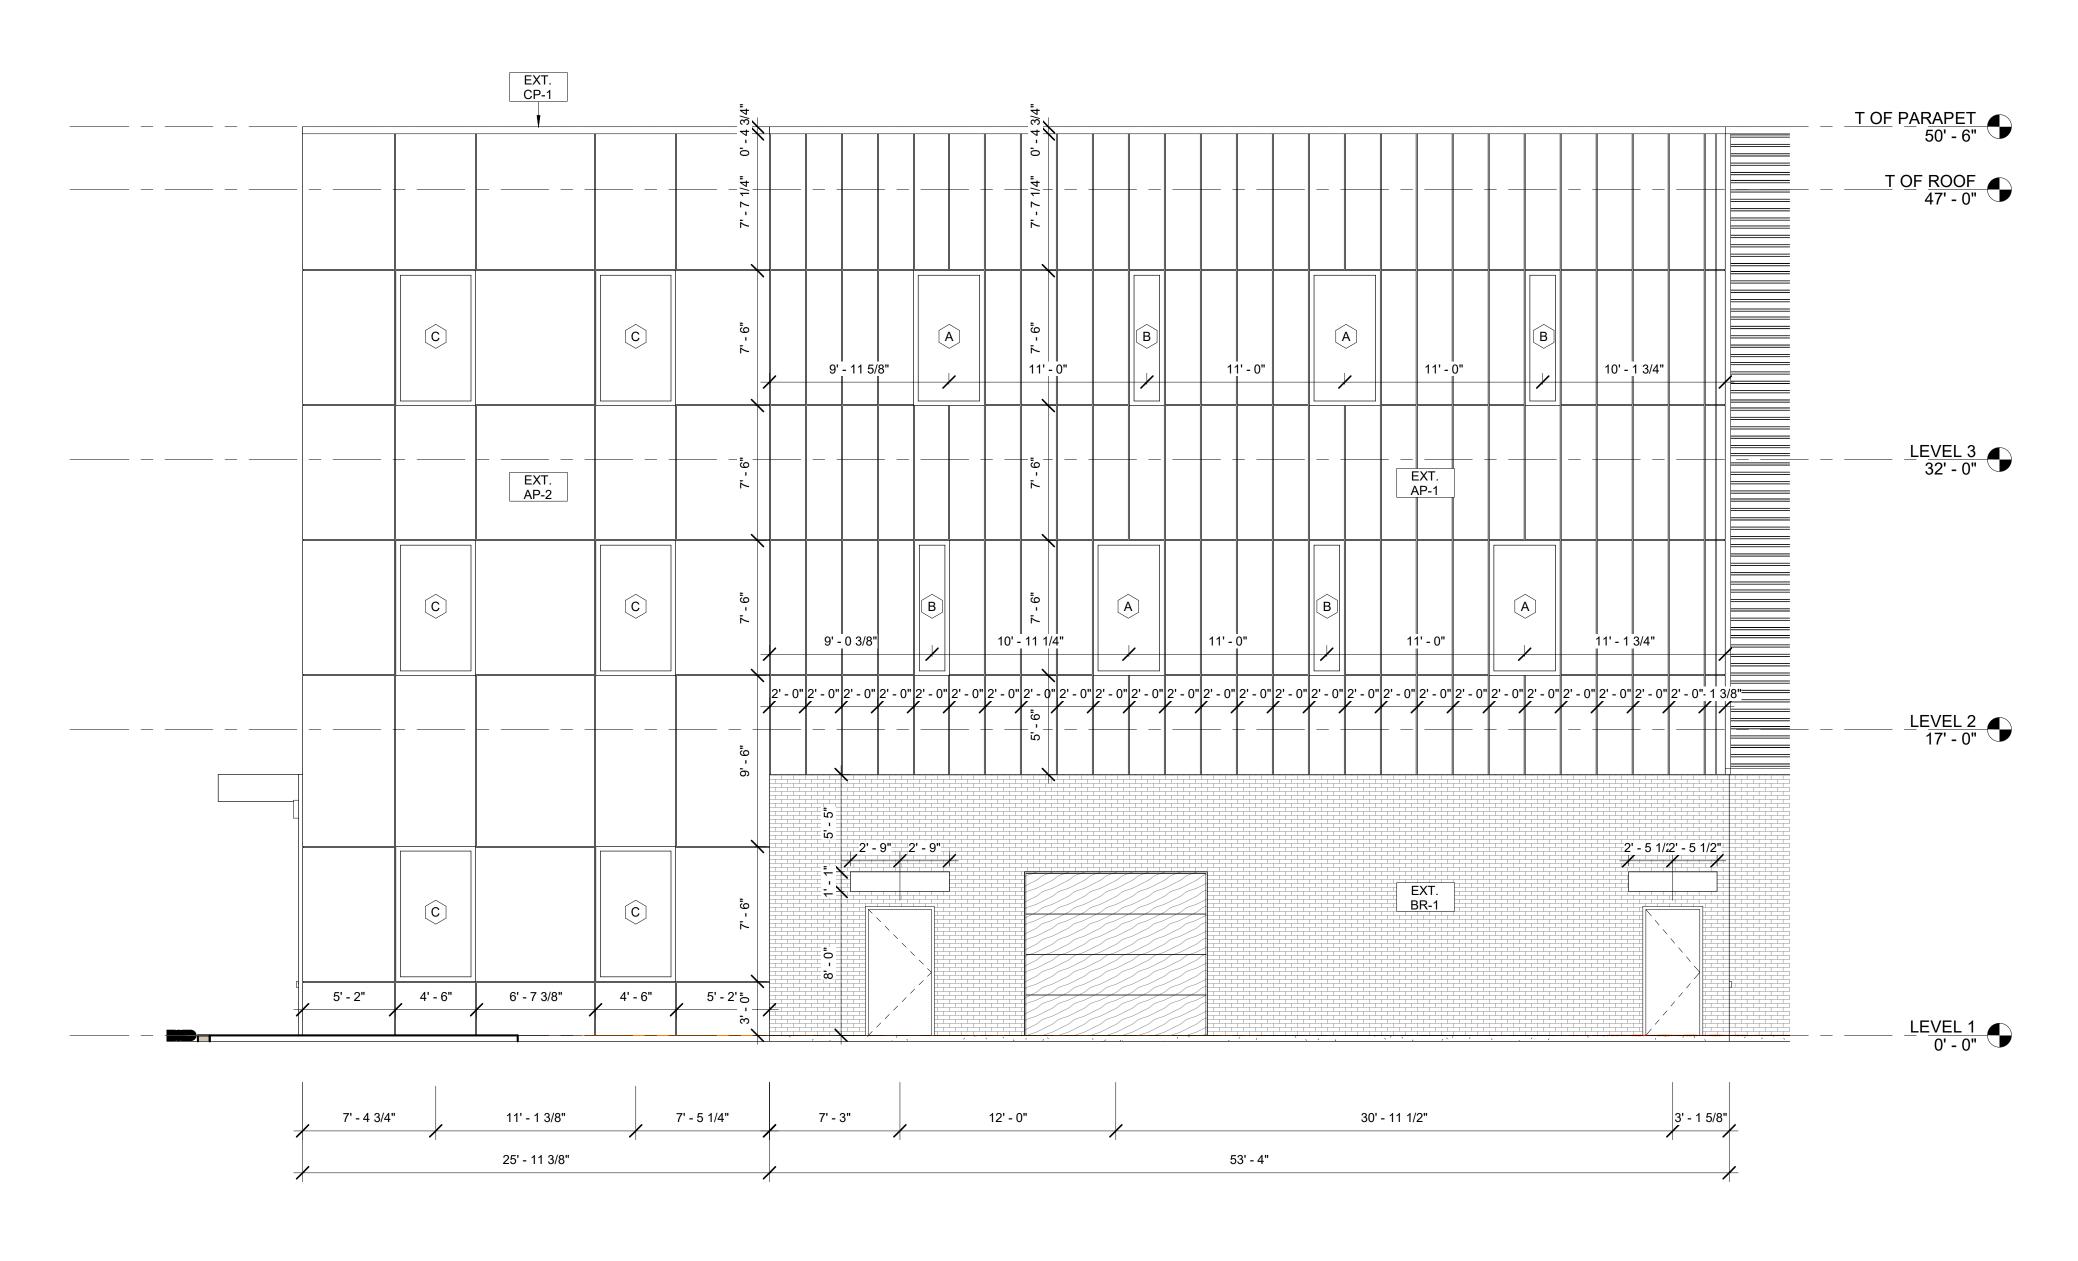
No.	Description	Date

EXTERIOR ELEVATIONS

Project number

A1-4.5

Scale



1 ELEVATION EAST - Callout 1
3/16" = 1'-0" NOTE: IF DRAWING IS PRINTED @ 11X17 SCALE TO BE REDUCED BY 50%



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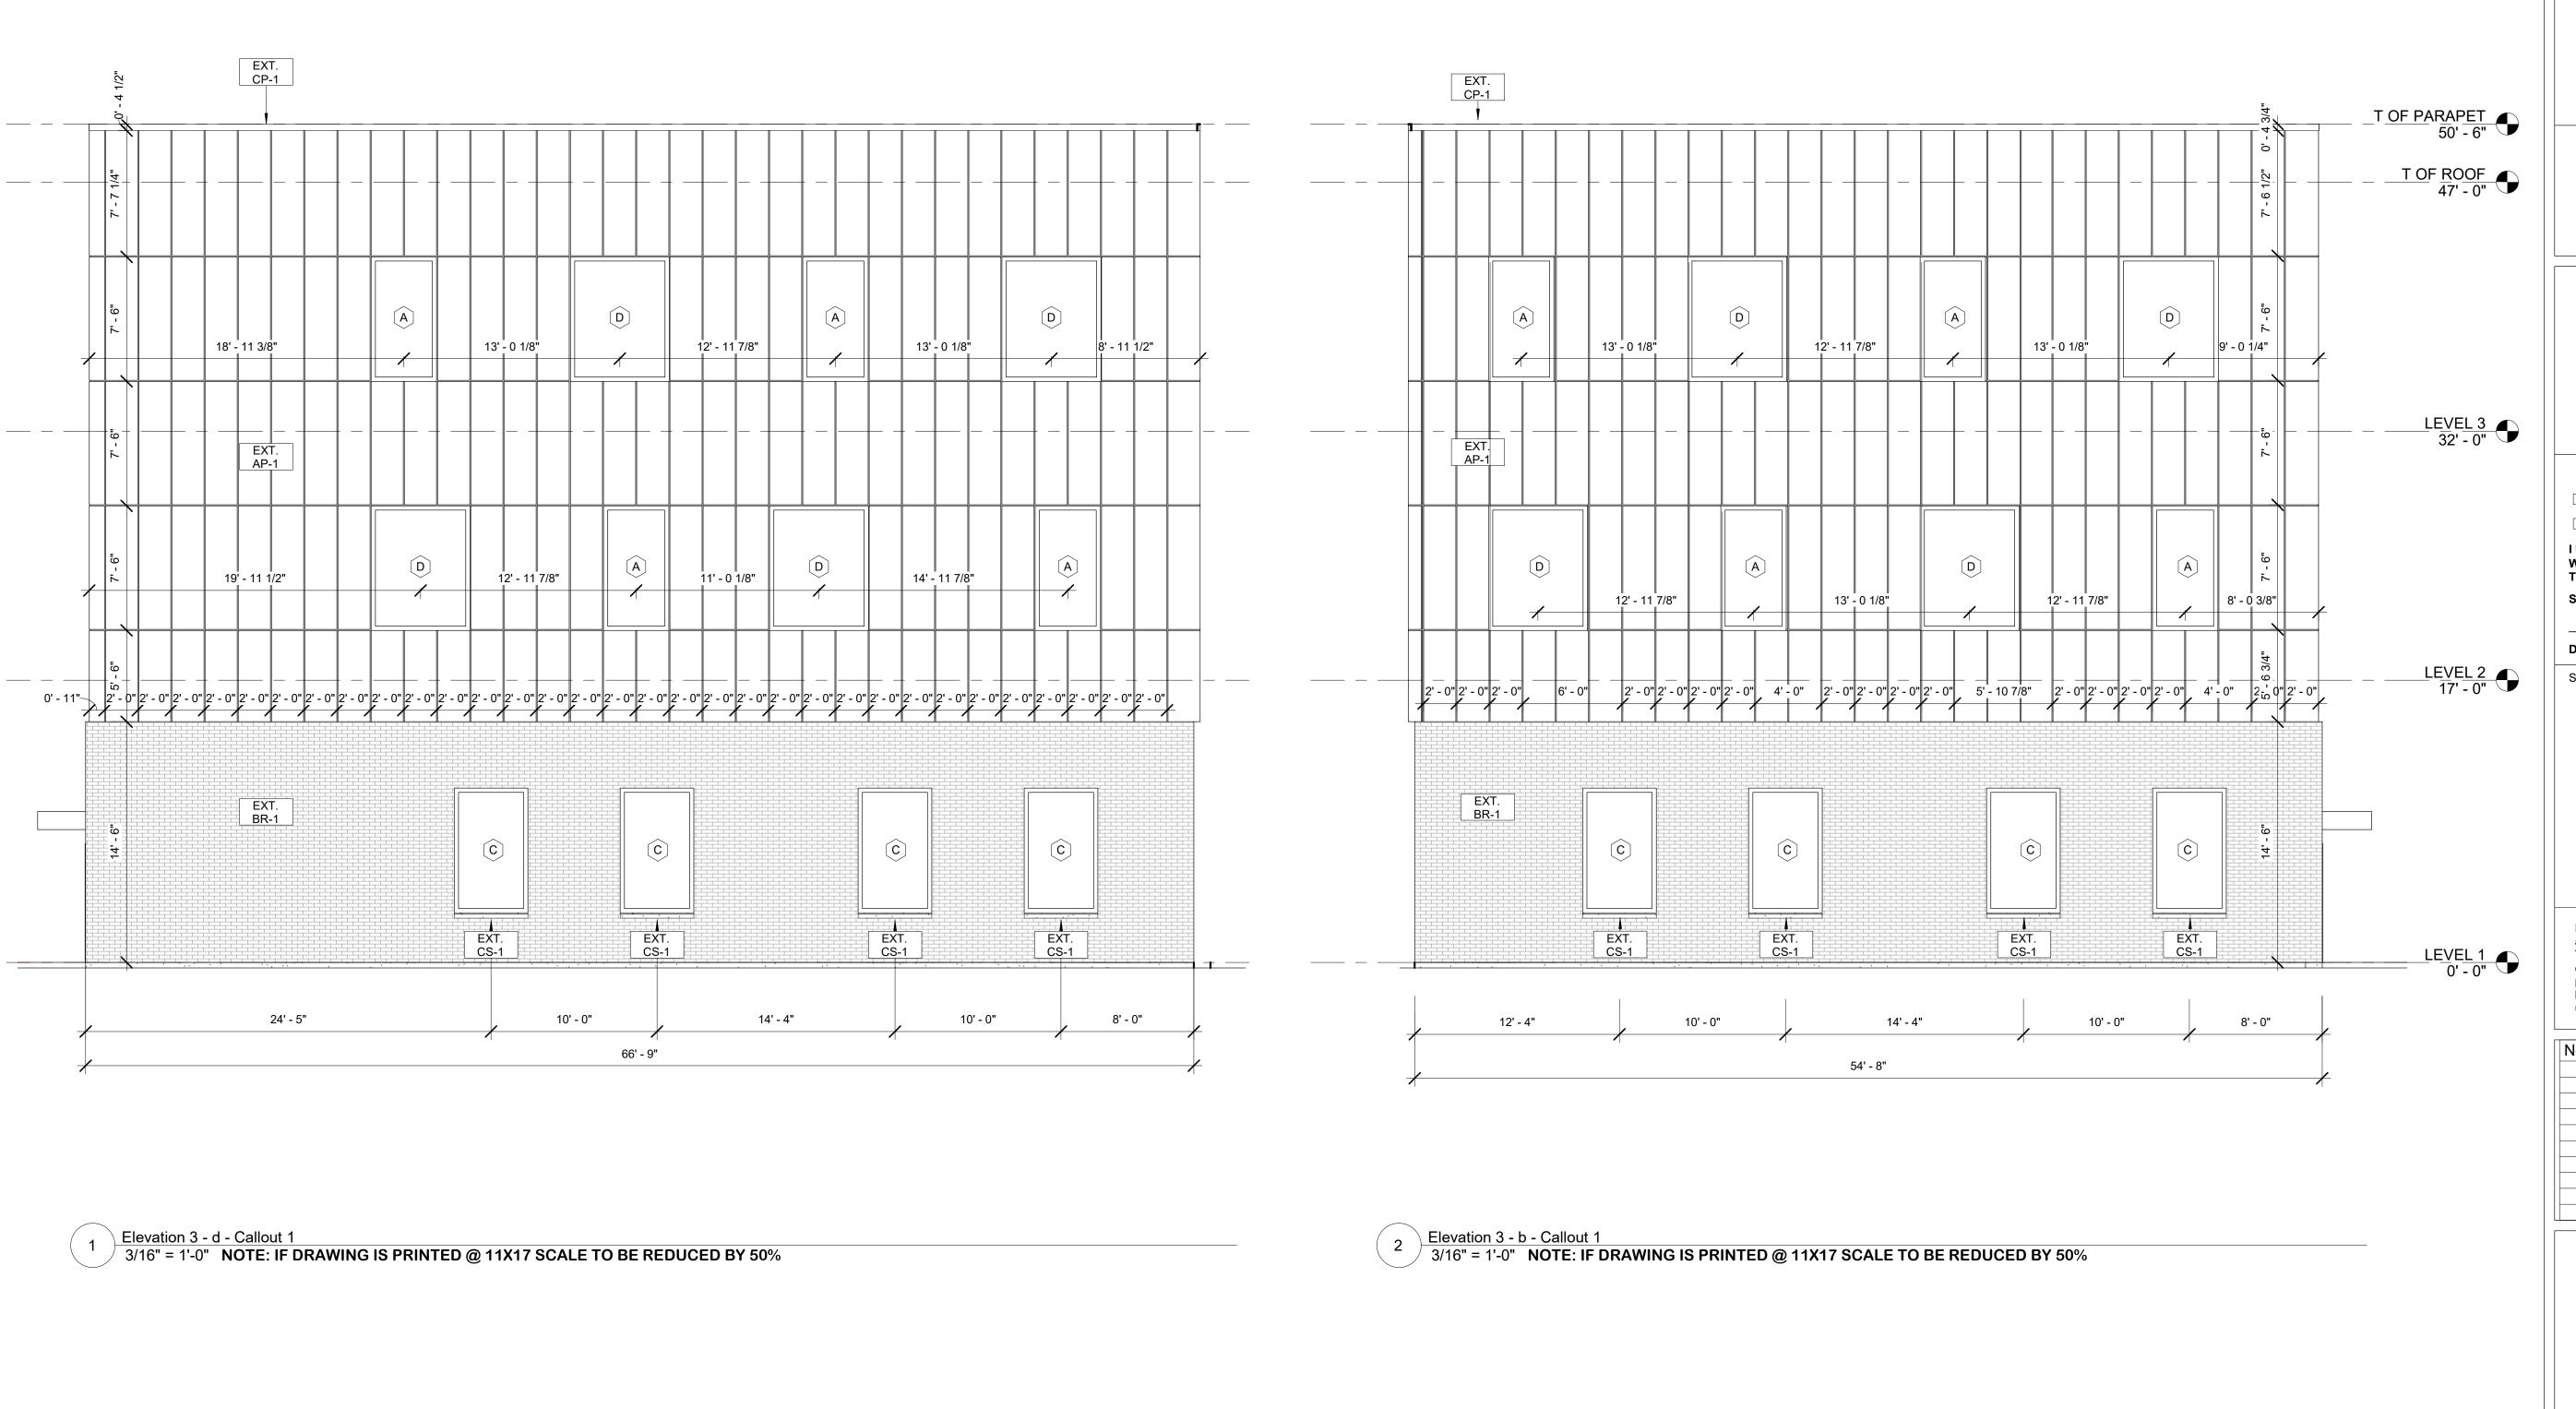
No.	Description	Date

EXTERIOR
ELEVATIONS

Project number

A1-4.6

Scale




9550 W.Higgins Rd. 170 Rosemont, IL 60018 DR. ALEX SLOCUM 360 CORPORATE DR. PORTSMOUTH , NH 03801 **CLIENT APPROVAL** APPROVED AS SHOWN ☐ APPROVED WITH CHANGES I UNDERSTAND ANY CHANGES HEREIN WILL RESULT IN ADDITIONAL COSTS AND TIME EXTENSIONS SIGNATURE: DATE:__ SEAL: DISCLAIMER: All drawings are proprietary and the exclusive property of our company. This/These print(s) shall not be shared, copied or reproduced without expressed permission of our company. This print is loaned in confidence and subject to return upon request by our company. Description Date


EXTERIOR ELEVATIONS

Project number

A1-4.7

3/16" = 1'-0"

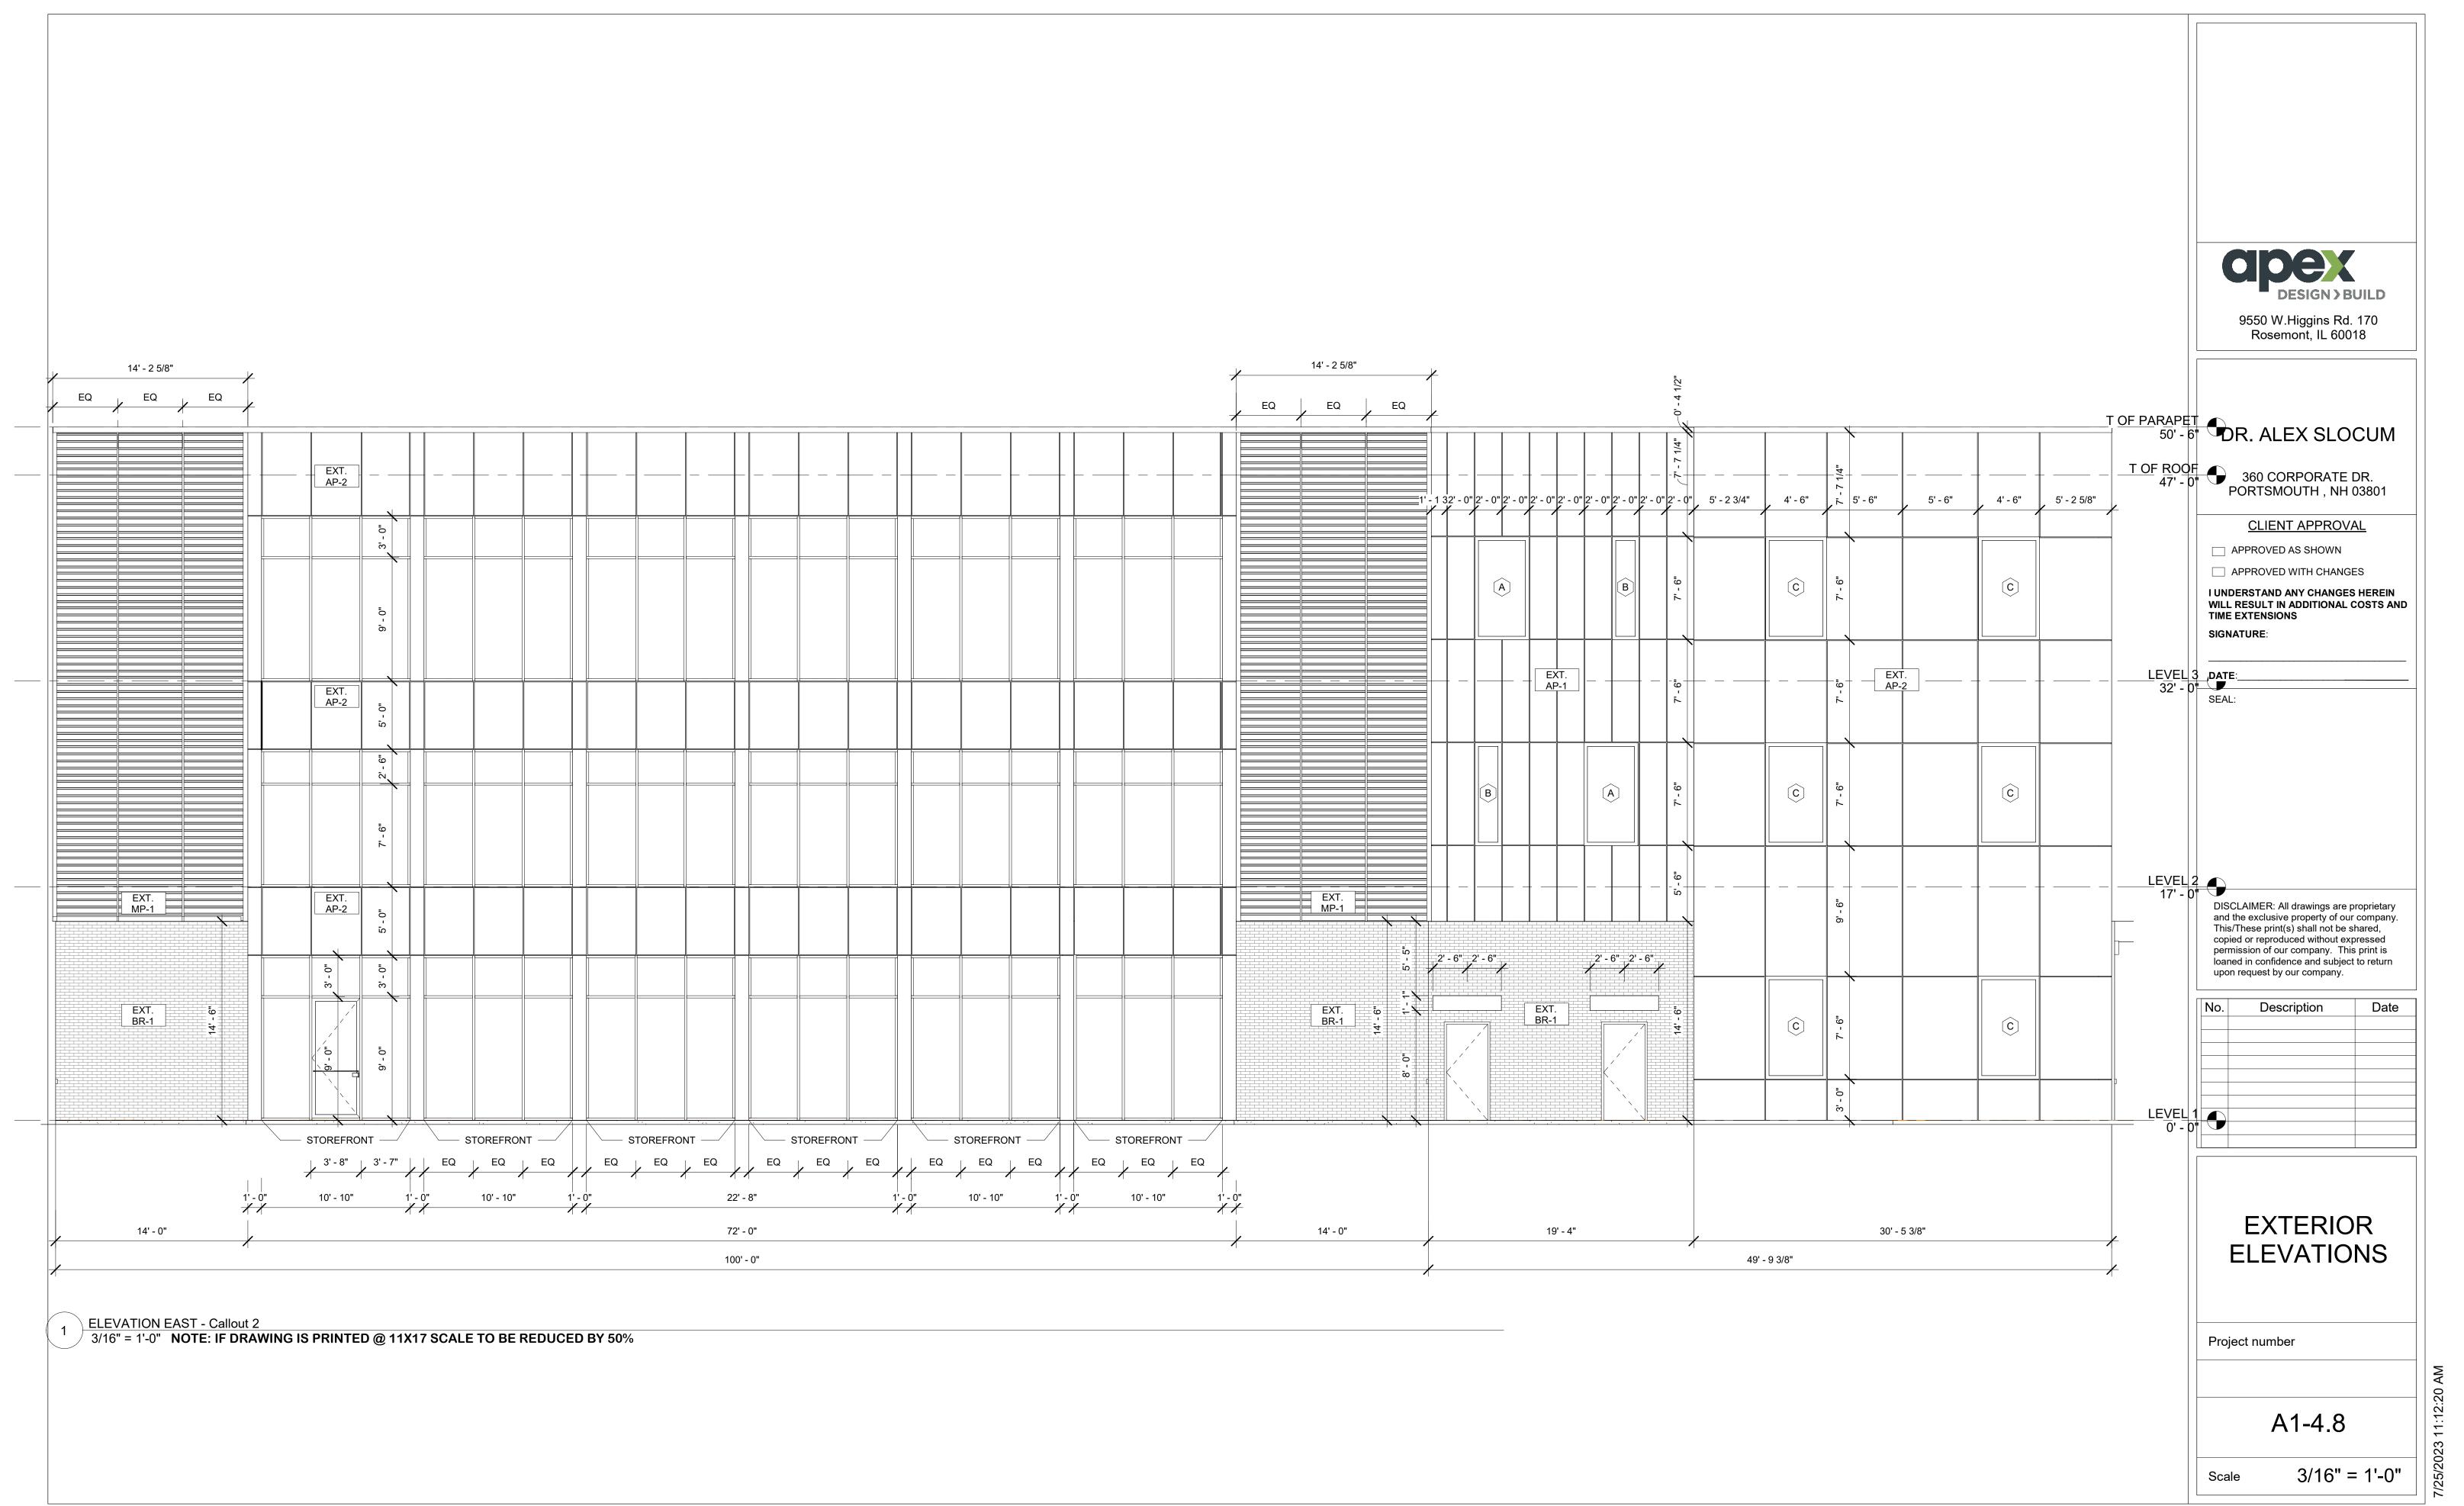

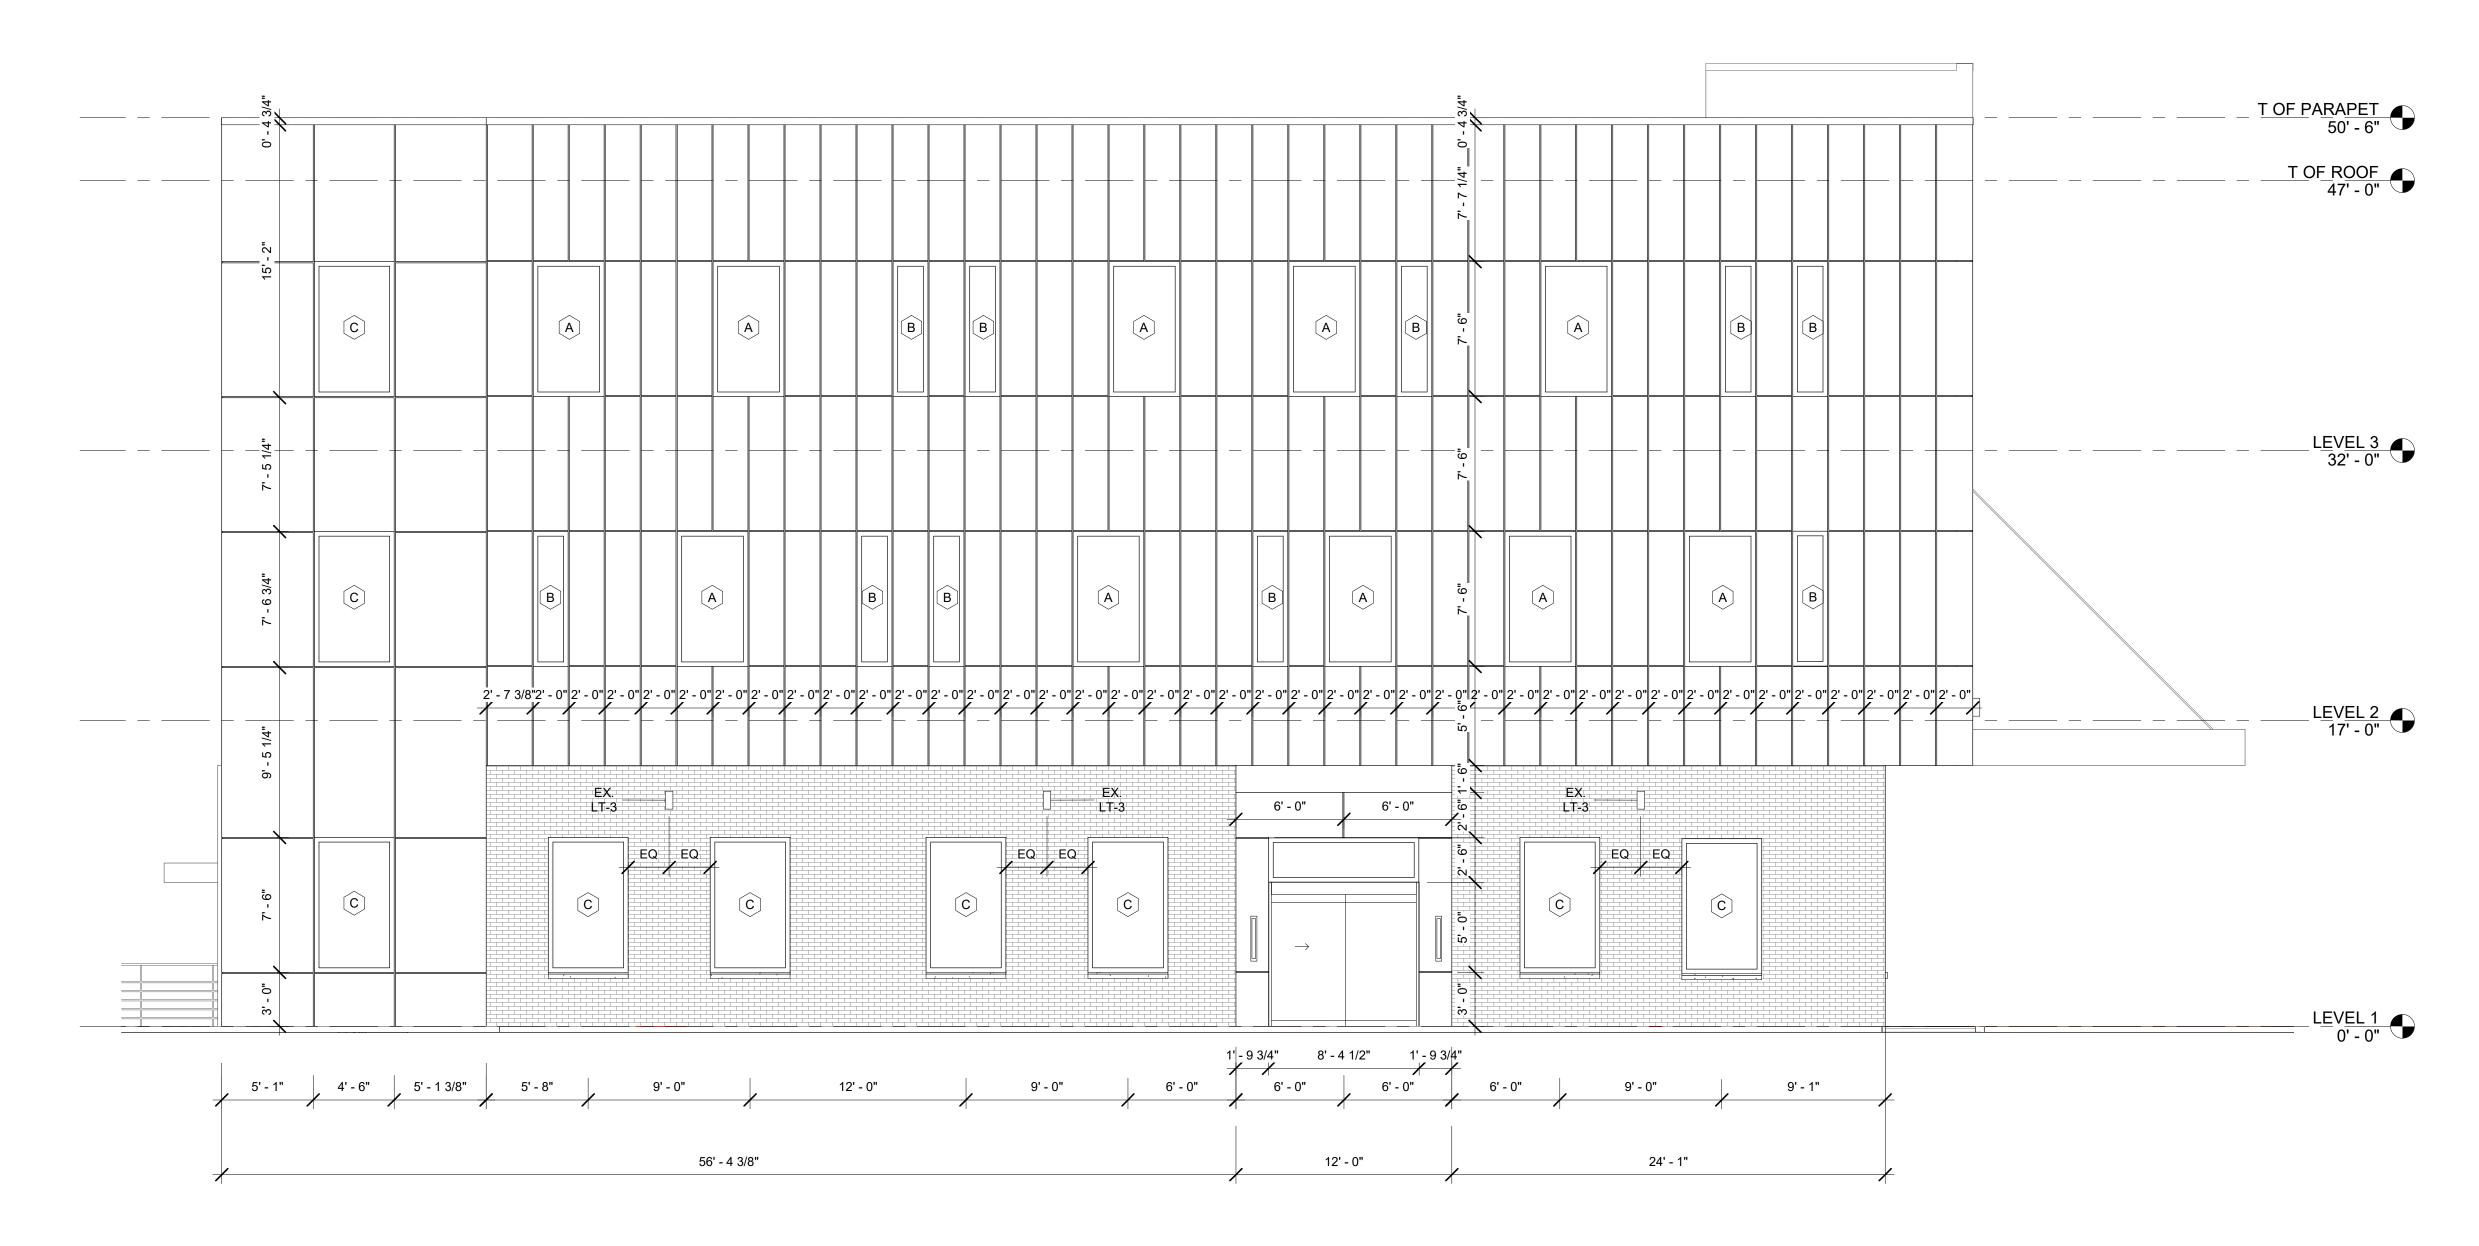

1 ELEVATION NORTH - Callout 1
3/16" = 1'-0" NOTE: IF DRAWING IS PRINTED @ 11X17 SCALE TO BE REDUCED BY 50%



9550 W.Higgins Rd. 170 Rosemont, IL 60018

DR. ALEX SLOCUM

360 CORPORATE DR. PORTSMOUTH , NH 03801

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No.	Description	Date

EXTERIOR ELEVATIONS

Project number

A1-4.9

cale