96 STATE STREET

PORTSMOUTH, NH HISTORIC DISTRICT COMMISION SUBMISSION

OWNER

Huai Ying Zheng STREET ADDRESS TOWN, STATE XXXXX PHONE:

ARCHITECT WINTER HOLBEN architecture + design 7 WALLINGFORD SQUARE, UNIT 2099 KITTERY, MAINE 03904 PHONE: 207-994-3104



DRAWING INDEX

No.	Sheet Name	
General		
G-100	Cover Sheet	
G-104	Existing Conditions	
G-104B	Existing Conditions	
G-105	Perspective Views	

Existing	
AE-100	Existing Plans
AE-101	Existing Plans
AE-102	Existing Plans
AE-300	Existing - North & East Elevation
AE-301	Existing - South & West Elevation

Previous Submissions: HDC Work Session - 05/17/2024 HDC Work Session - 06/12/2024 HDC Work Session - 07/17/2024

SITE LOCATION MAP



No.	Sheet Name	
Archited	Architectural	
A-110	Basement Plan	
A-111	First Floor Plan	
A-112	2nd Floor Plan	
A-113	3rd Floor Plan	
A-114	Roof Plan	
A-300	Elevations	
4-301	Elevations	
A-401	Building Sections	
A-510	Exterior Details	
A-901	Door & Window Schedule & Types	
A-902	Product Data	
A-902B	Product Data	

96 STATE ST.	Portsmouth, NH
HDC SUBMISSI	ON
Huai Ying Zhe	eng
KITTERY, MAIN	EN design ORD SQ NIT 2099
Drawn By:	994.3104
Drawing Checked By:	ВМН
Drawing Scale:	12" = 1'-0"
Drawing Date:	07/26/24
Project Number:	24051
drawing revisions: No. Description	Date
Cover She	et

7/25/2024





CORNER OF ATKINSON & STATE STREET PERSPECTIVE

VIEW DOWN ATKINSON STREET



VIEW OF 96 STATE STREET FROM DOWN STATE STREET



DOWN STATE STREET



Ч Ч ш STAT 96

Portsmouth, NH

Huai Ying Zheng

CLIENT ADDRESS CITY, ST ZIP PHONE

WINTER HOLBEN architecture + design

aronneotaro acorgi

7 WALLINGFORD SQ UNIT 2099 KITTERY, MAINE 03904 207.994.3104

Drawn By: PG Drawing Checked By: BMH Drawing Scale: Drawing Date: 07/26/24

24051

Project Number:

drawing revisions:

Existing Conditions

G-104

7/25/2024 6:44:59 PM





STATE STREET CLOSE UP PERSPECTIVE



ADJACENT PROPERTY - 100 STATE STREET UNPERMITTED/NON-CONFORMING WINDOW



CORNER OF ATKINSON AND STATE STREET



ATKINSON STREET PERSPECTIVE

PERSPECTIVE



ALLEYWAY OFF ATKINSON

ST STATE 96

Portsmouth, NH

Huai Ying Zheng

CLIENT ADDRESS CITY, ST ZIP PHONE

WINTER HOLBEN

architecture + design

7 WALLINGFORD SQ UNIT 2099 KITTERY, MAINE 03904 207.994.3104

PG BMH

07/26/24

24051

Drawn By:

Drawing Checked By:

Drawing Scale

Drawing Date:

Project Number:

drawing revisions:

Existing Conditions

G-104B

7/25/2024 6:45:01 PM





State Street Perspective (1)

2 Atkinson Street Perspective



3 Corner Perspective

ST STATE 96

Portsmouth, NH

Huai Ying Zheng

CLIENT ADDRESS CITY, ST ZIP PHONE

WINTER HOLBEN architecture + design

7 WALLINGFORD SQ UNIT 2099 KITTERY, MAINE 03904 207.994.3104

Drawn By:

PG

BMH

07/26/24

24051

Drawing Checked By:

Drawing Scale

Drawing Date:


Project Number:


drawing revisions:

Perspective Views


G-105

7/25/2024 6:45:11 PM

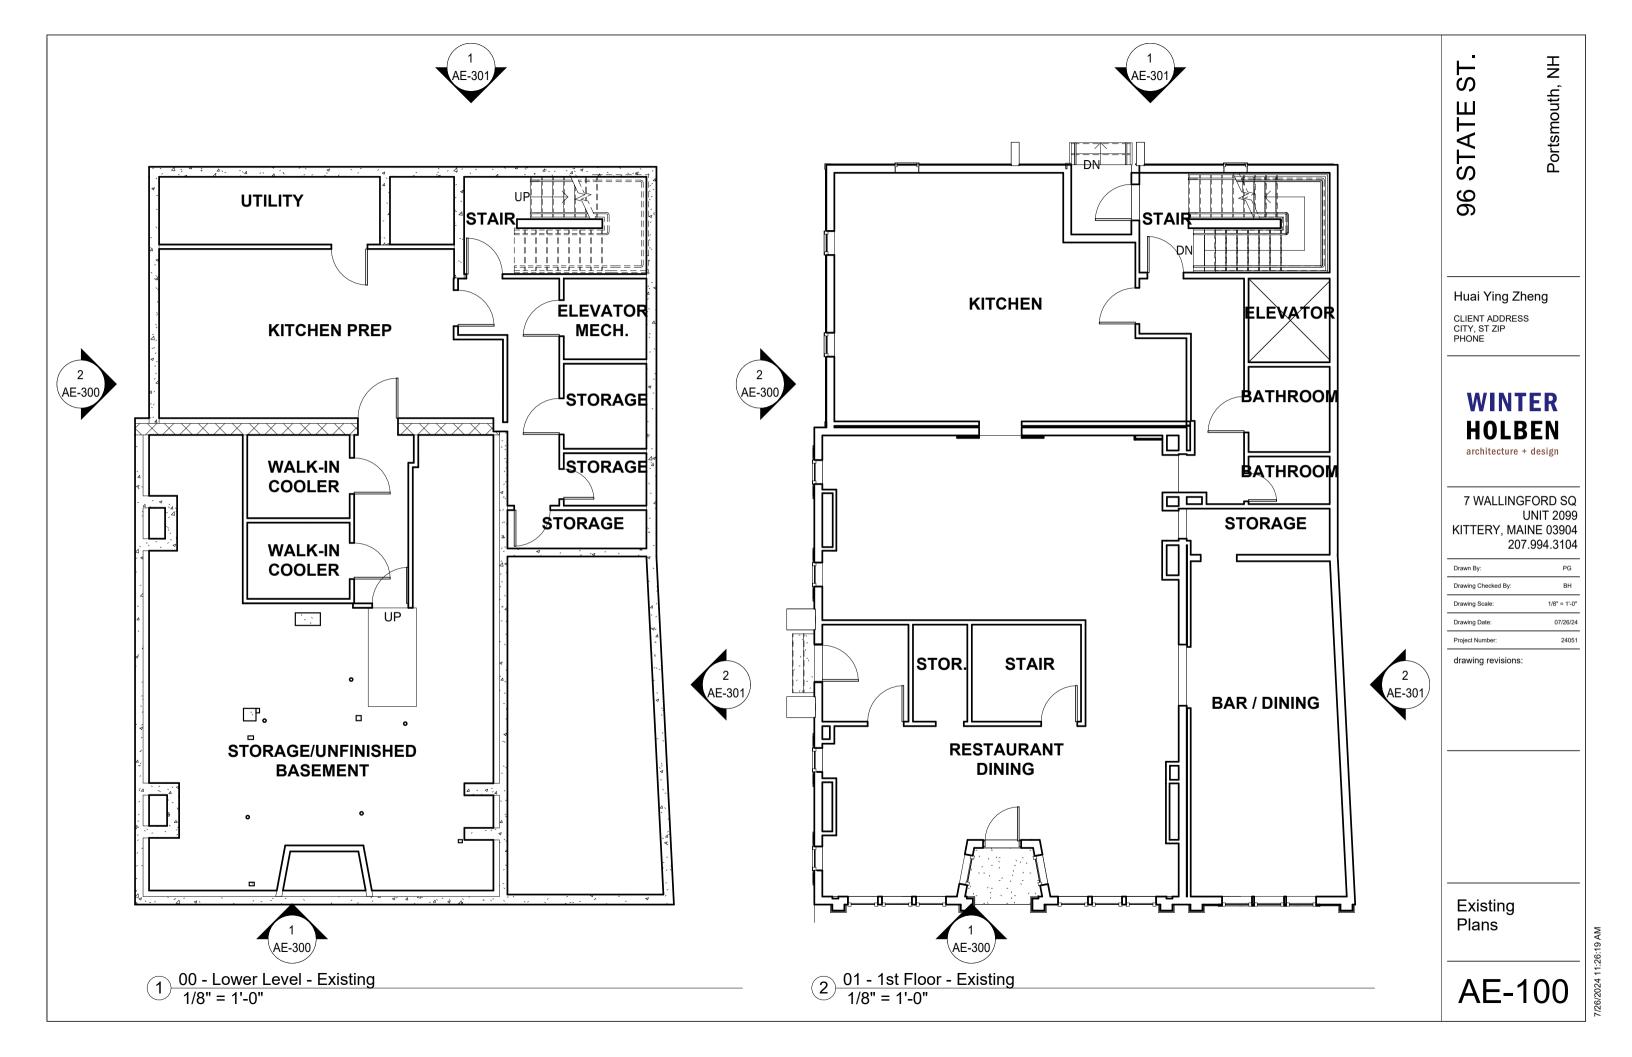

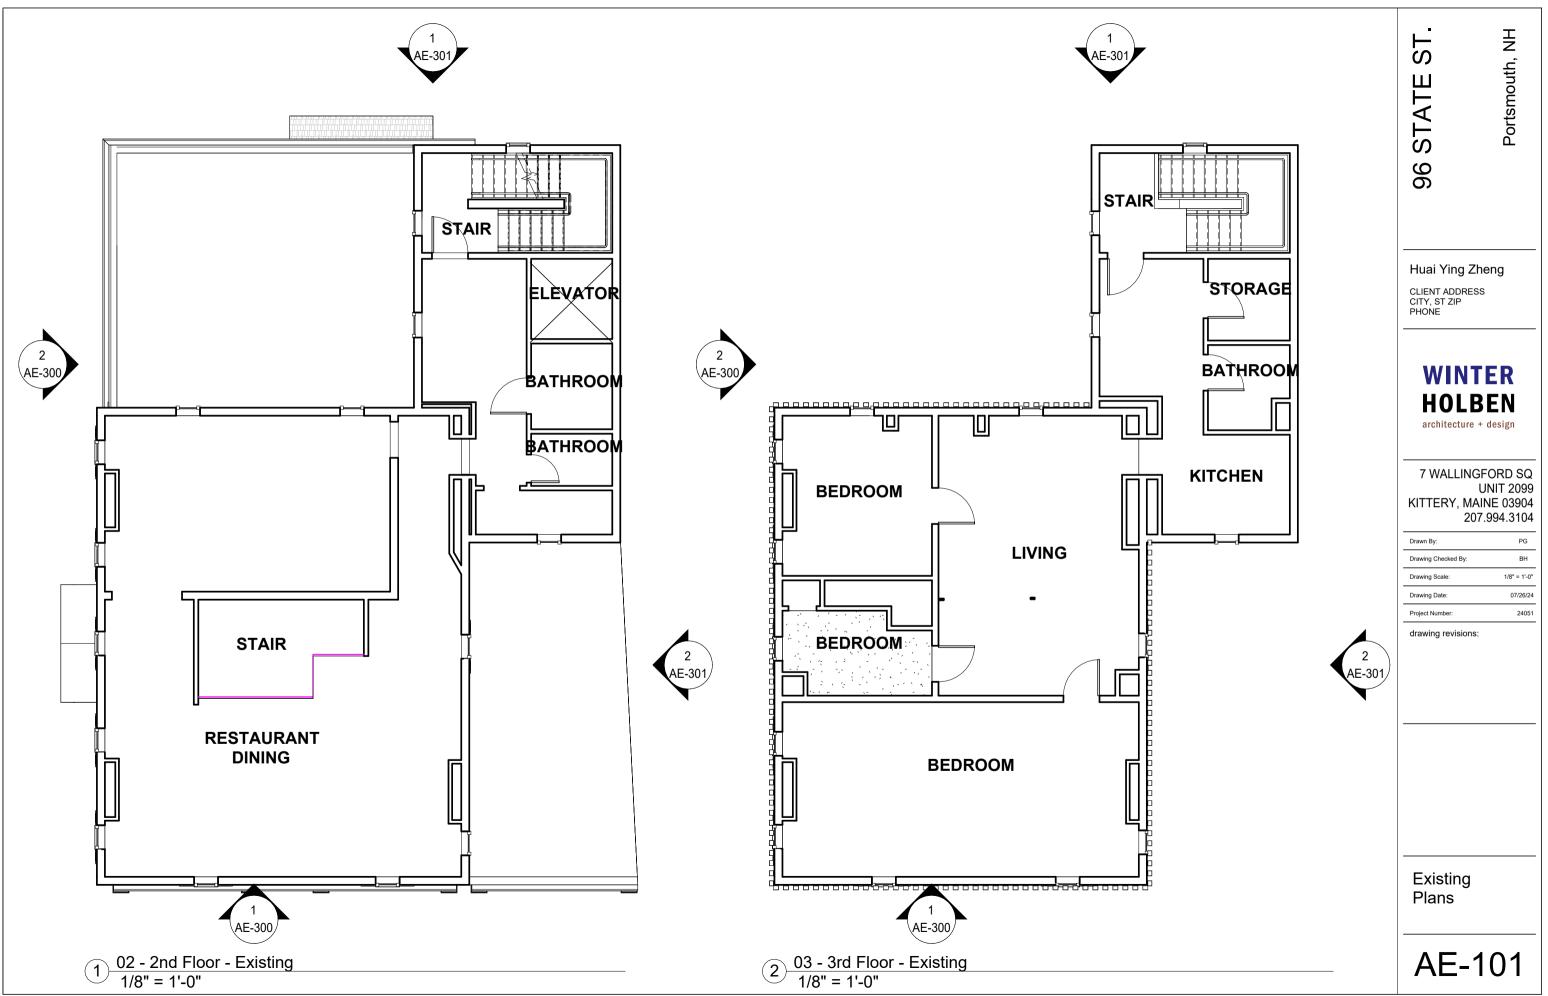

7/26/2024 11:26:20 AM

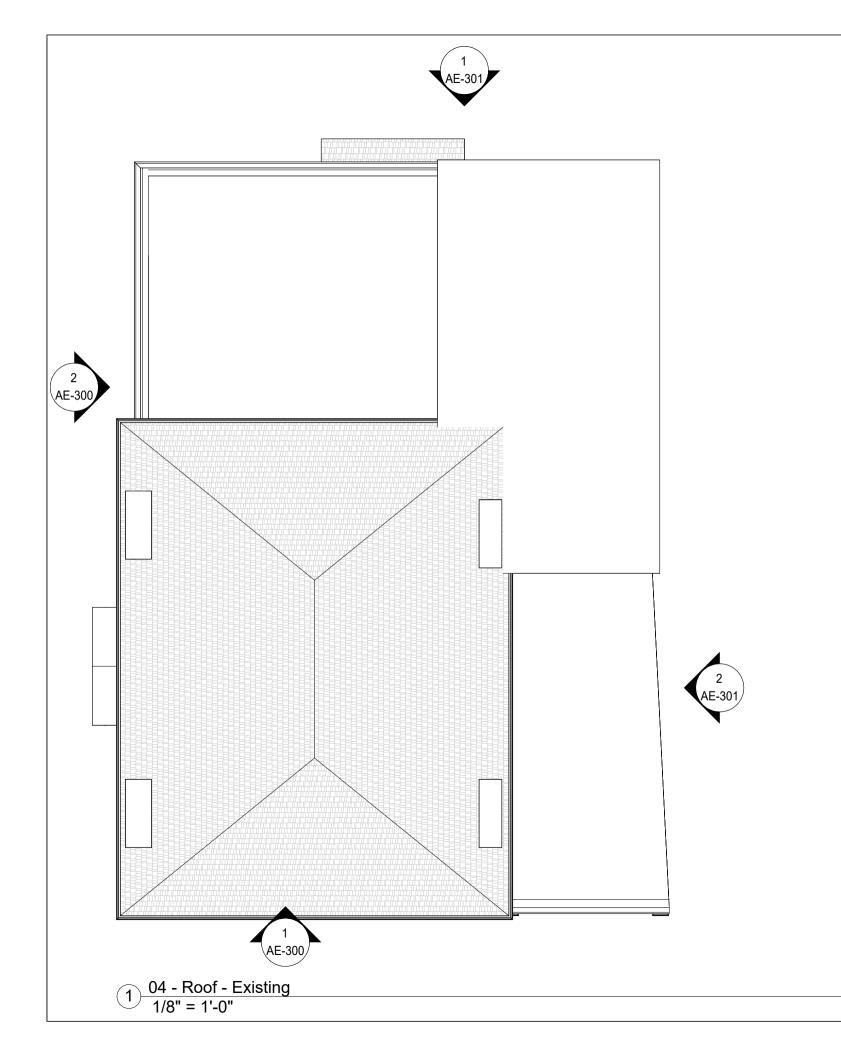

96 STATE ST.

Portsmouth, NH

Huai Ying Zheng

CLIENT ADDRESS CITY, ST ZIP PHONE

WINTER HOLBEN architecture + design

7 WALLINGFORD SQ UNIT 2099 KITTERY, MAINE 03904 207.994.3104

Drawn By:	PG
Drawing Checked By:	Checker
Drawing Scale:	1/8" = 1'-0"
Drawing Date:	07/26/24
Project Number:	24051

drawing revisions:

Existing Plans

AE-102

7/25/2024 6:45:13 PM





PG

Checker

1/8" = 1'-0"

07/26/24


24051

Portsmouth, NH

Existing -North & East Elevation

AE-300

7/25/2024 6:45:16 PM

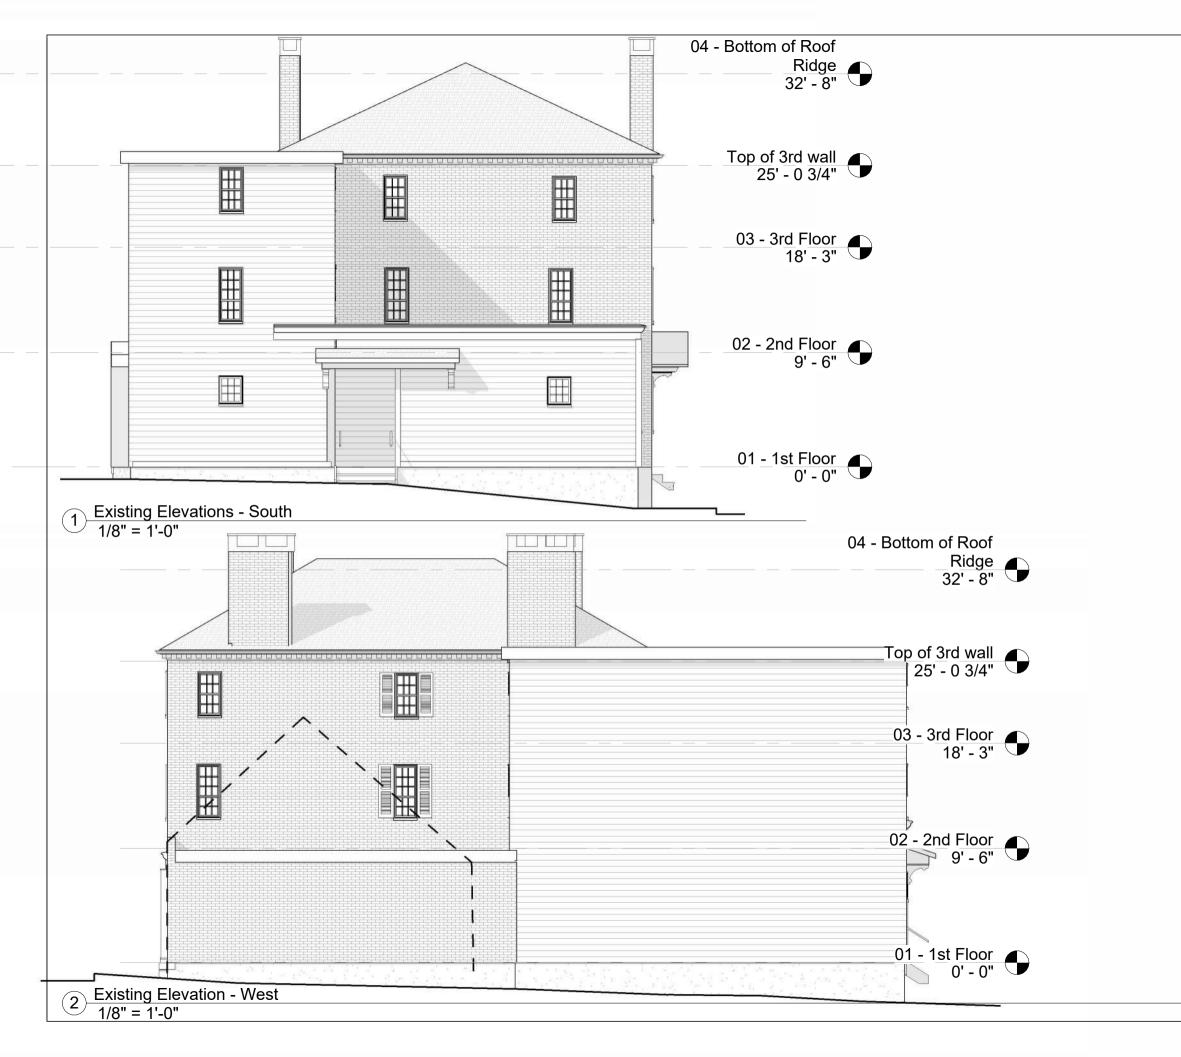



Huai Ying Zheng

Portsmouth, NH

CLIENT ADDRESS CITY, ST ZIP PHONE


WINTER HOLBEN architecture + design

7 WALLINGFORD SQ UNIT 2099 KITTERY, MAINE 03904 207.994.3104


Drawn By:	PG
Drawing Checked By:	Checker
Drawing Scale:	1/8" = 1'-0"
Drawing Date:	07/26/24
Project Number:	24051

drawing revisions:

Existing -South & West Elevation

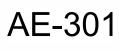

7/25/2024 6:45:18 PM

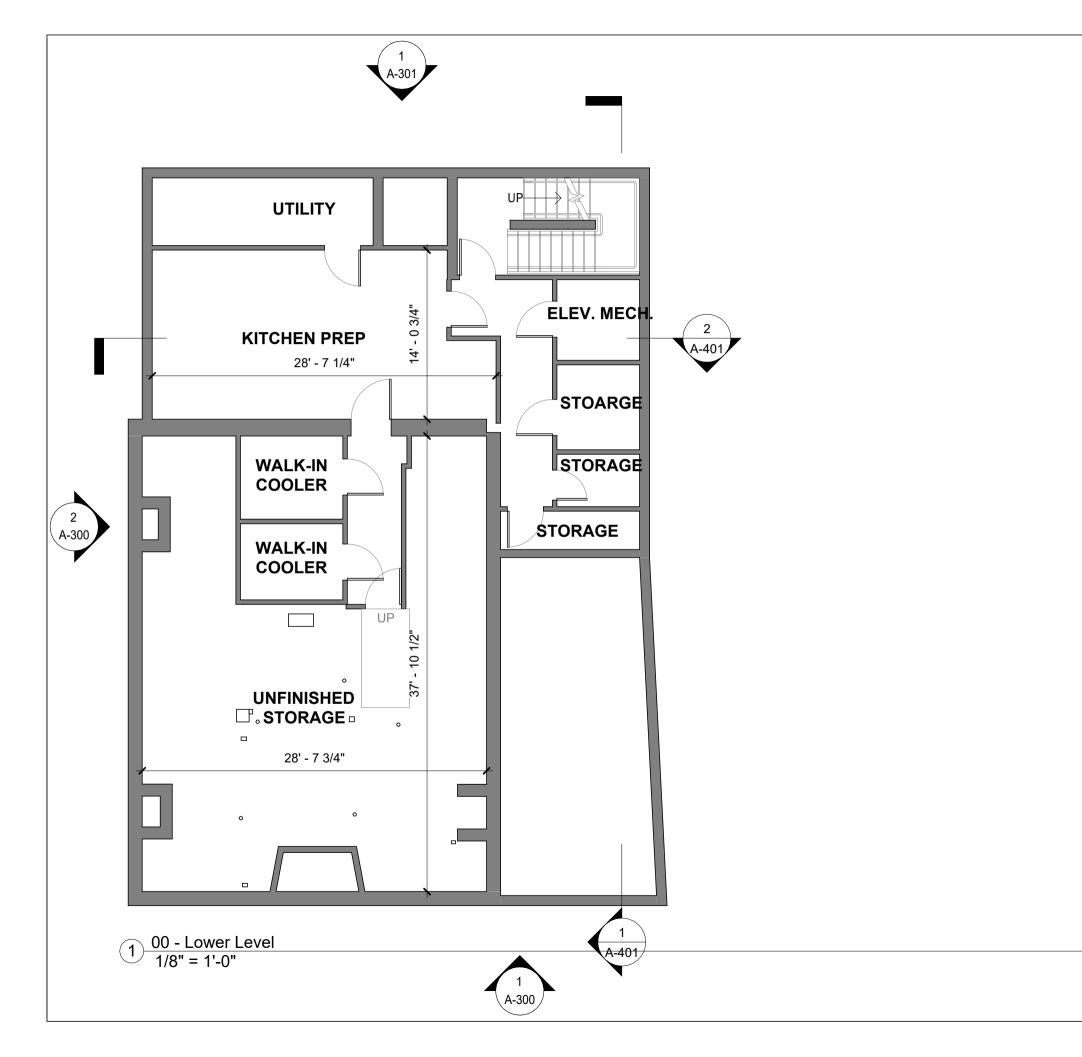

ST. STATE 96 Huai Ying Zheng

Portsmouth, NH

CLIENT ADDRESS CITY, ST ZIP PHONE

WINTER HOLBEN architecture + design

7 WALLINGFORD SQ UNIT 2099 KITTERY, MAINE 03904 207.994.3104

Drawn By:	PG
Drawing Checked By:	BMH
Drawing Scale:	As indicated
Drawing Date:	07/26/24
Project Number:	24051

drawing revisions:

Basement Plan

LEGEND




EXISTING WALL

NEW WALL

WINDOW TAG



7/26/2024 11:26:20 AM

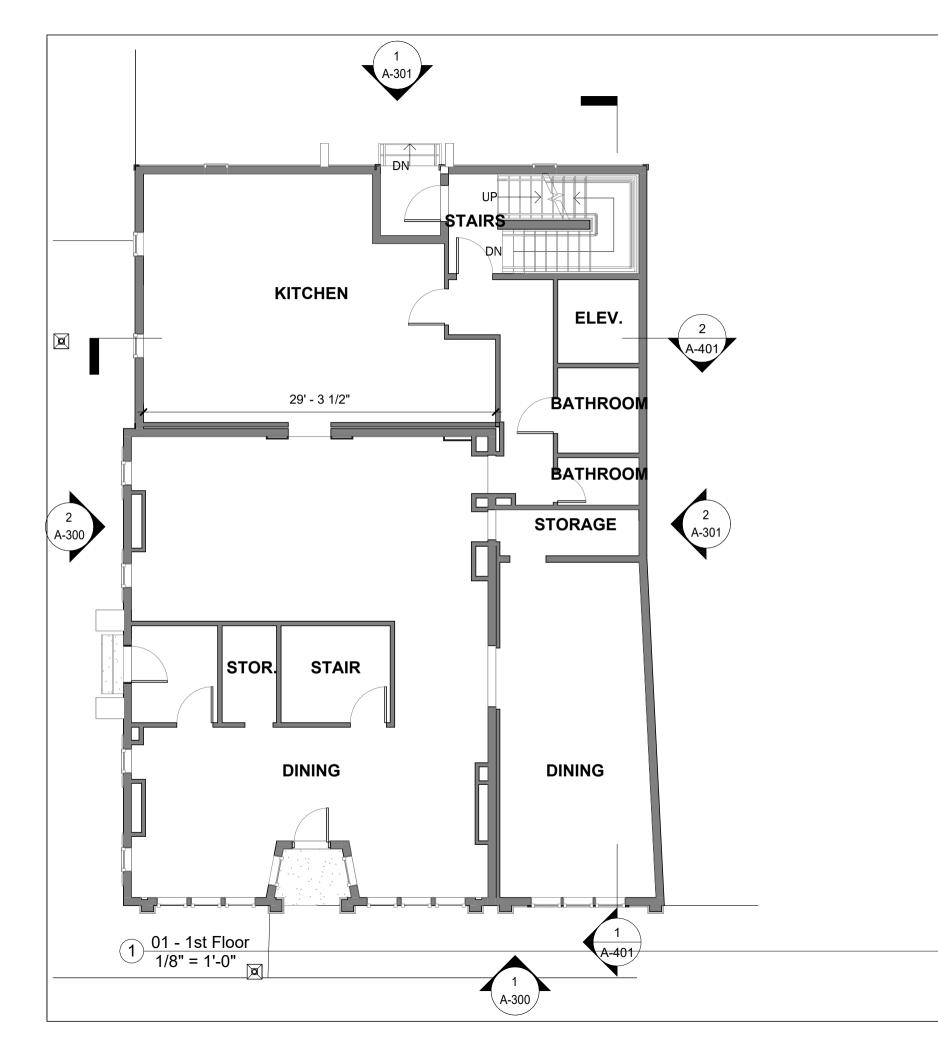

2

	KEYNOTES
NOTE NO.	Description
	DEMO WINDOW FOR PASSAGE
	EQUIPMENT AREA



Portsmouth, NH

Huai Ying Zheng

CLIENT ADDRESS CITY, ST ZIP PHONE

WINTER HOLBEN

architecture + design

7 WALLINGFORD SQ UNIT 2099 KITTERY, MAINE 03904 207.994.3104

Drawn By:	PG
Drawing Checked By:	BMH
Drawing Scale:	As indicated
Drawing Date:	07/26/24
Project Number:	24051

drawing revisions:

LEGEND

(A)

EXISTING WALL


NEW WALL

WINDOW TAG

First Floor Plan

A-111

7/26/2024 11:26:20 AM

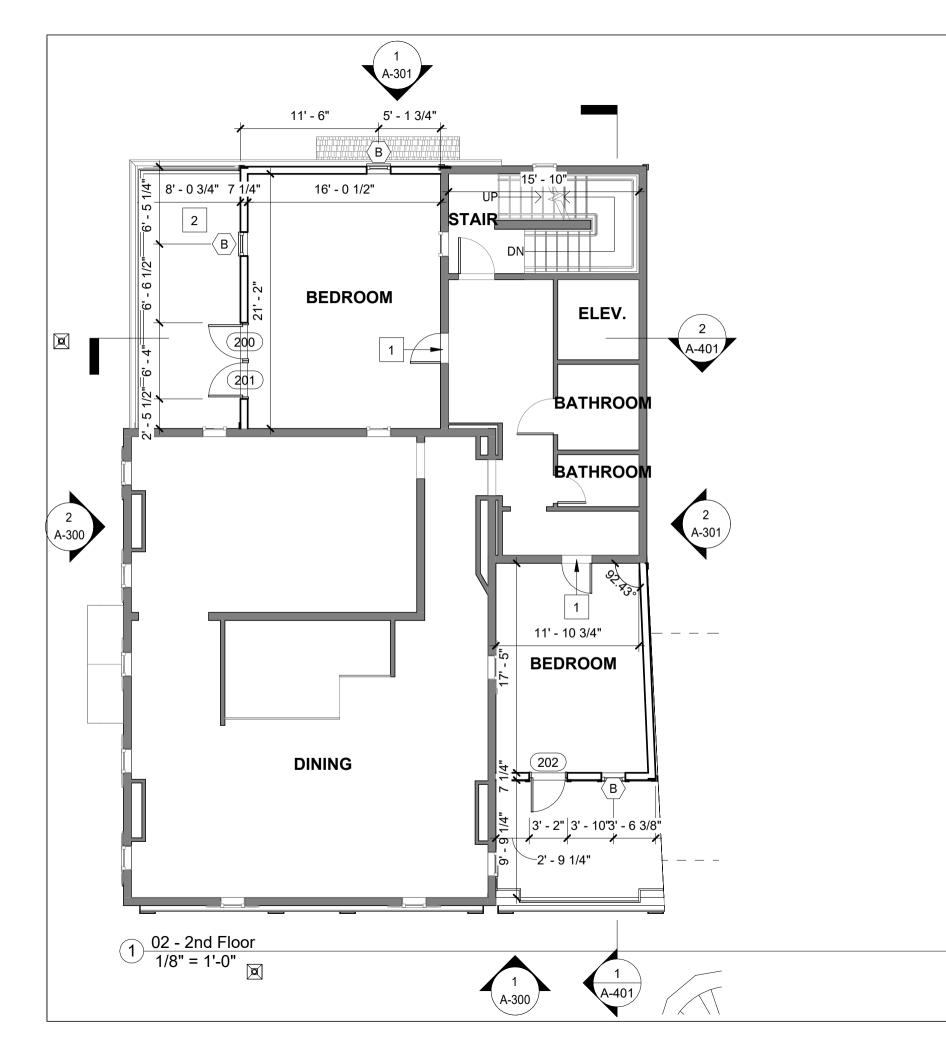

NO

1 2

KEYNOTES		
DTE NO.	Description	
	DEMO WINDOW FOR PASSAGE	
	EQUIPMENT AREA	



Portsmouth, NH

Huai Ying Zheng

CLIENT ADDRESS CITY, ST ZIP PHONE

WINTER HOLBEN

architecture + design

7 WALLINGFORD SQ UNIT 2099 KITTERY, MAINE 03904 207.994.3104

Drawn By:	PG
Drawing Checked By:	BH
Drawing Scale:	As indicated
Drawing Date:	07/26/24
Project Number:	24051

drawing revisions:

LEGEND

_	
	Â

EXISTING WALL


NEW WALL

WINDOW TAG

2nd Floor Plan



ЫМ 7/25/2024 6:45:20

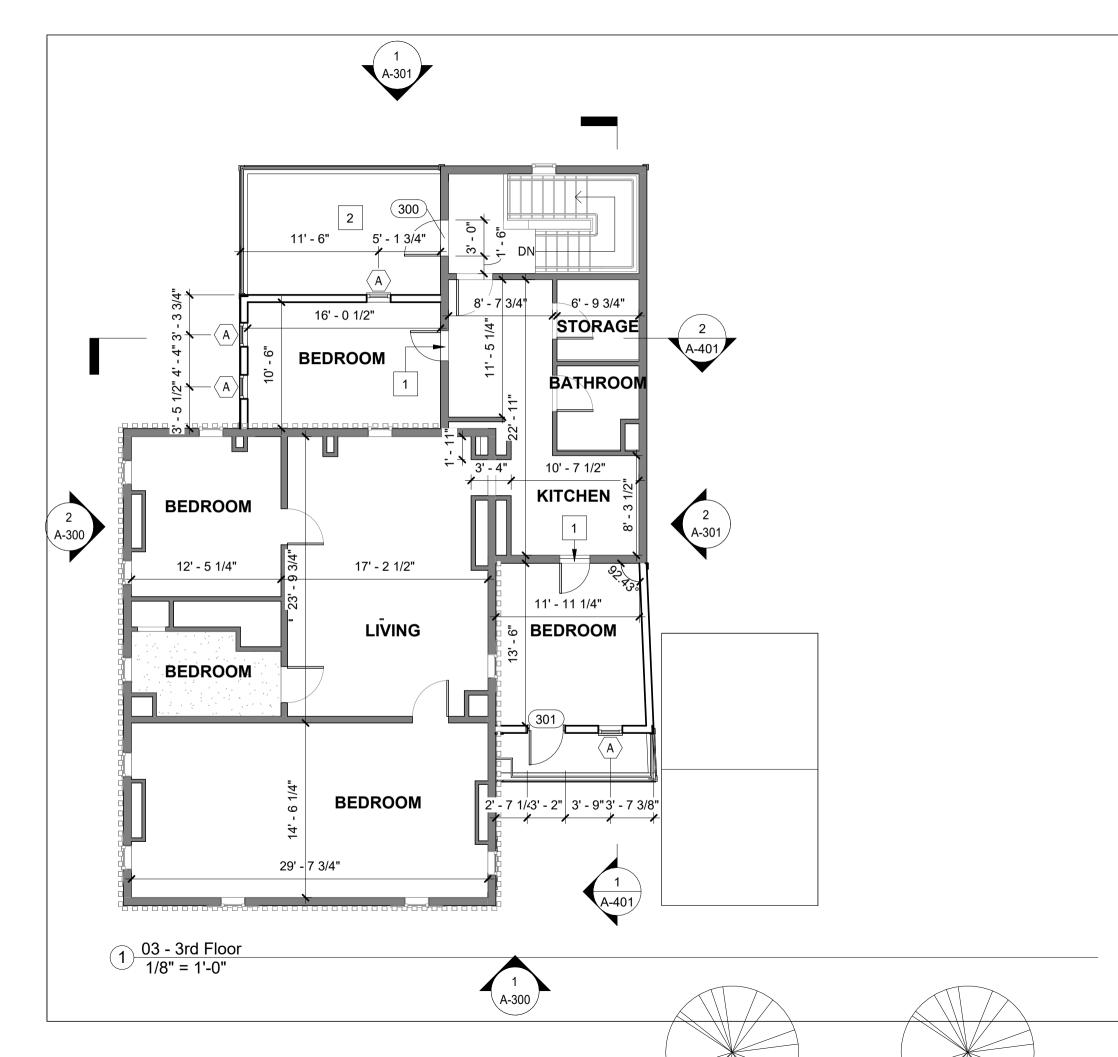

NO

1 2

	KEYNOTES
DTE NO.	Description
	DEMO WINDOW FOR PASSAGE
	EQUIPMENT AREA



Portsmouth, NH

Huai Ying Zheng

CLIENT ADDRESS CITY, ST ZIP PHONE

WINTER HOLBEN

architecture + design

7 WALLINGFORD SQ **UNIT 2099** KITTERY, MAINE 03904 207.994.3104

Drawn By: PG BH Drawing Checked By: Drawing Scale As indicated Drawing Date: 07/26/24 Project Number: 24051

drawing revisions:

LEGEND

Â

EXISTING WALL


NEW WALL

WINDOW TAG

3rd Floor Plan

A-113

ЫМ 7/25/2024 6:45:20

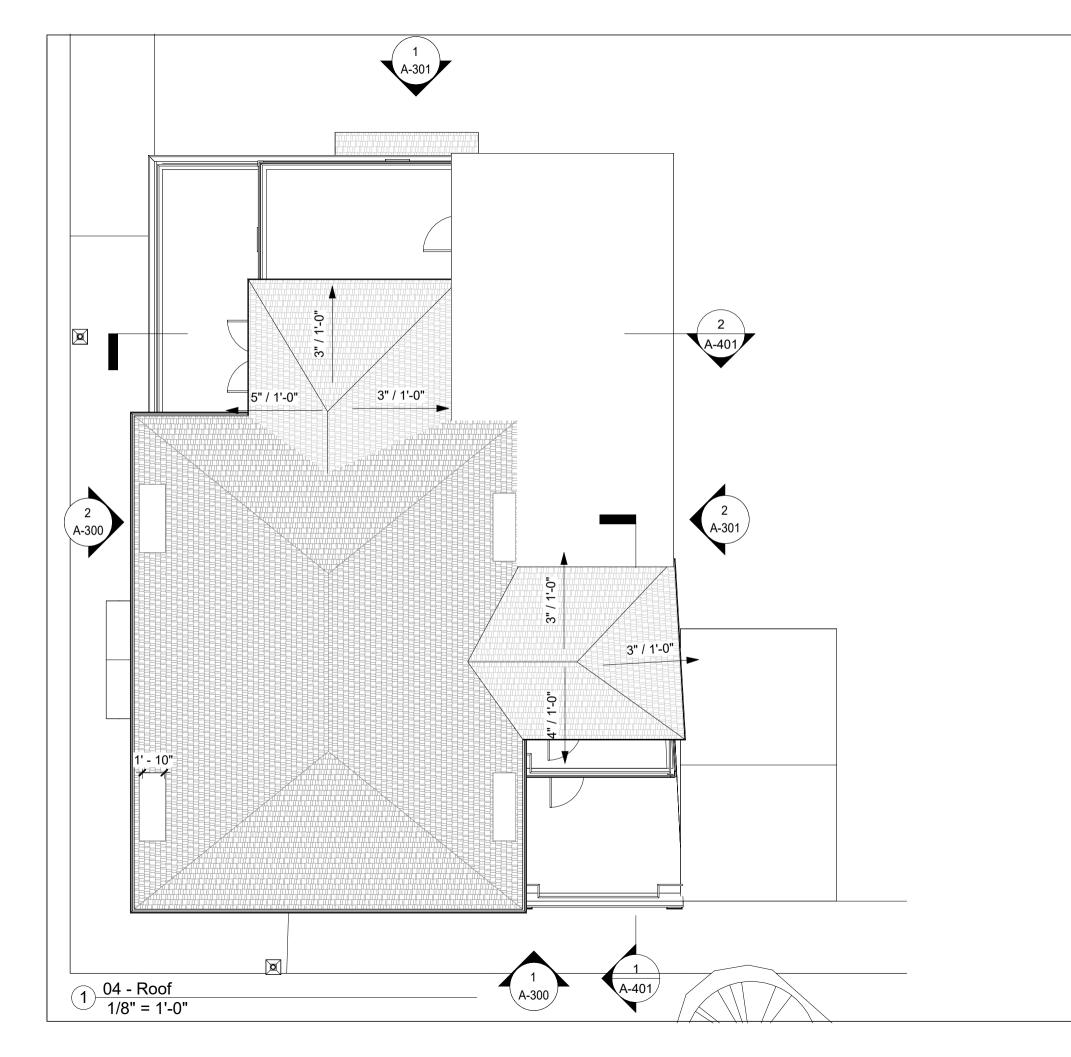

96 STATE ST.

Portsmouth, NH

Huai Ying Zheng

CLIENT ADDRESS CITY, ST ZIP PHONE

WINTER HOLBEN architecture + design

7 WALLINGFORD SQ UNIT 2099 KITTERY, MAINE 03904 207.994.3104


Drawn By:	PG
Drawing Checked By:	BH
Drawing Scale:	1/8" = 1'-0"
Drawing Date:	07/26/24
Project Number:	24051

drawing revisions:


Roof Plan

A-114

7/25/2024 6:45:21 PM

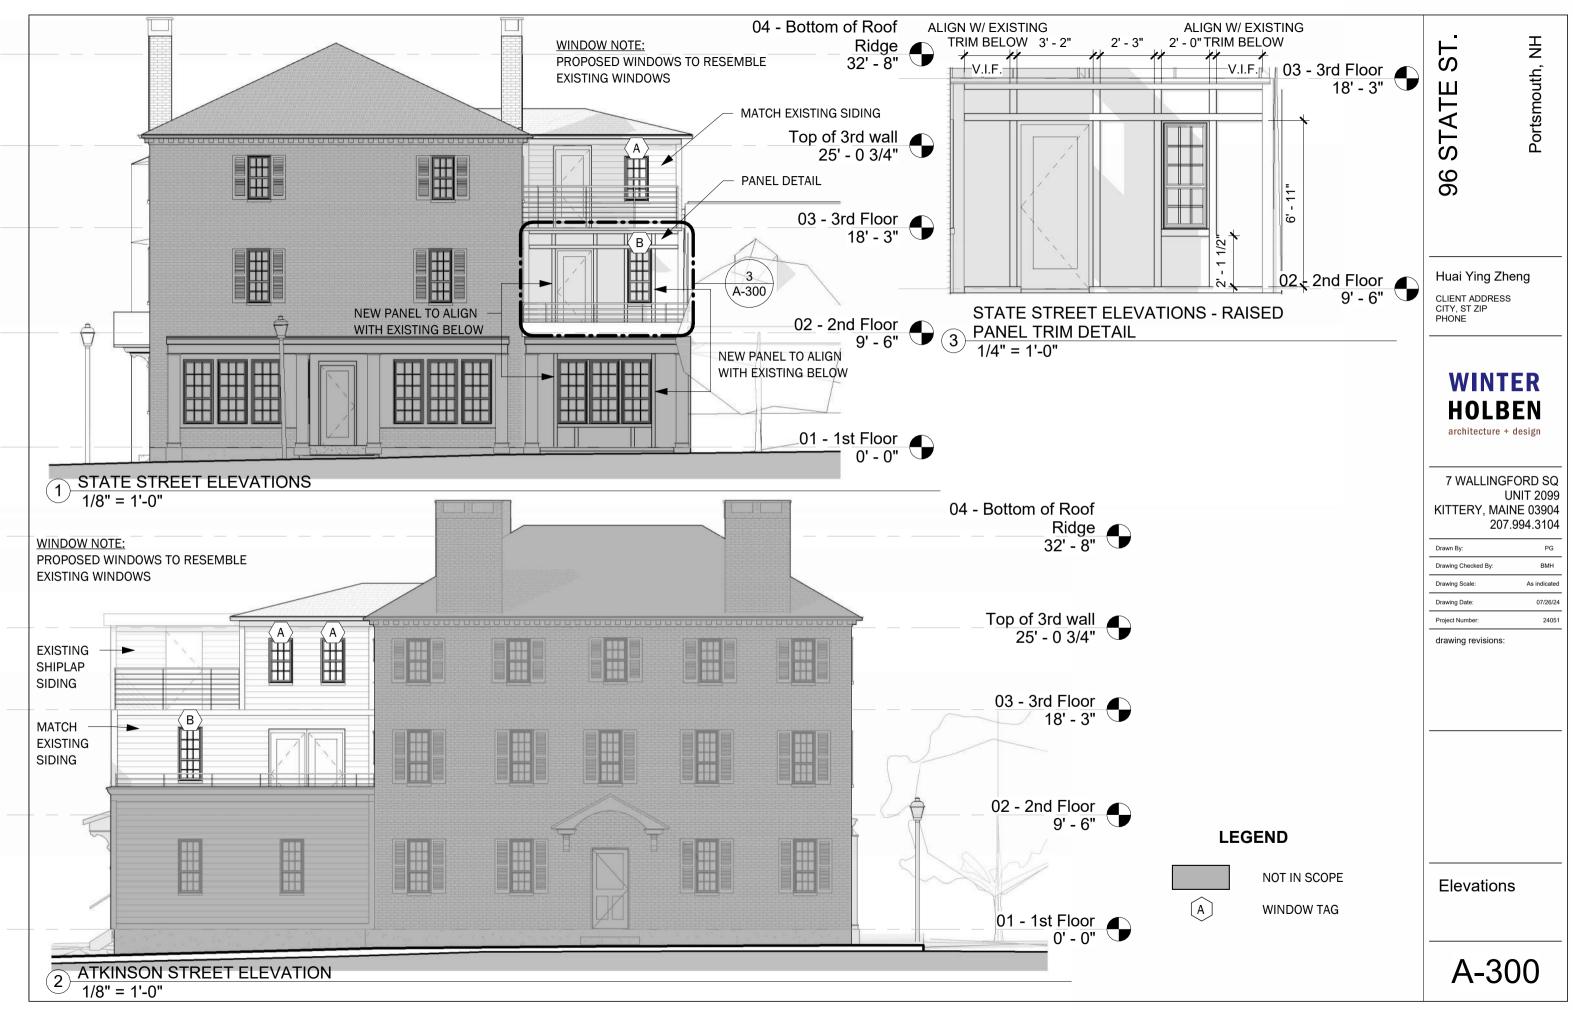

7/25/2024 6:45:26 PM

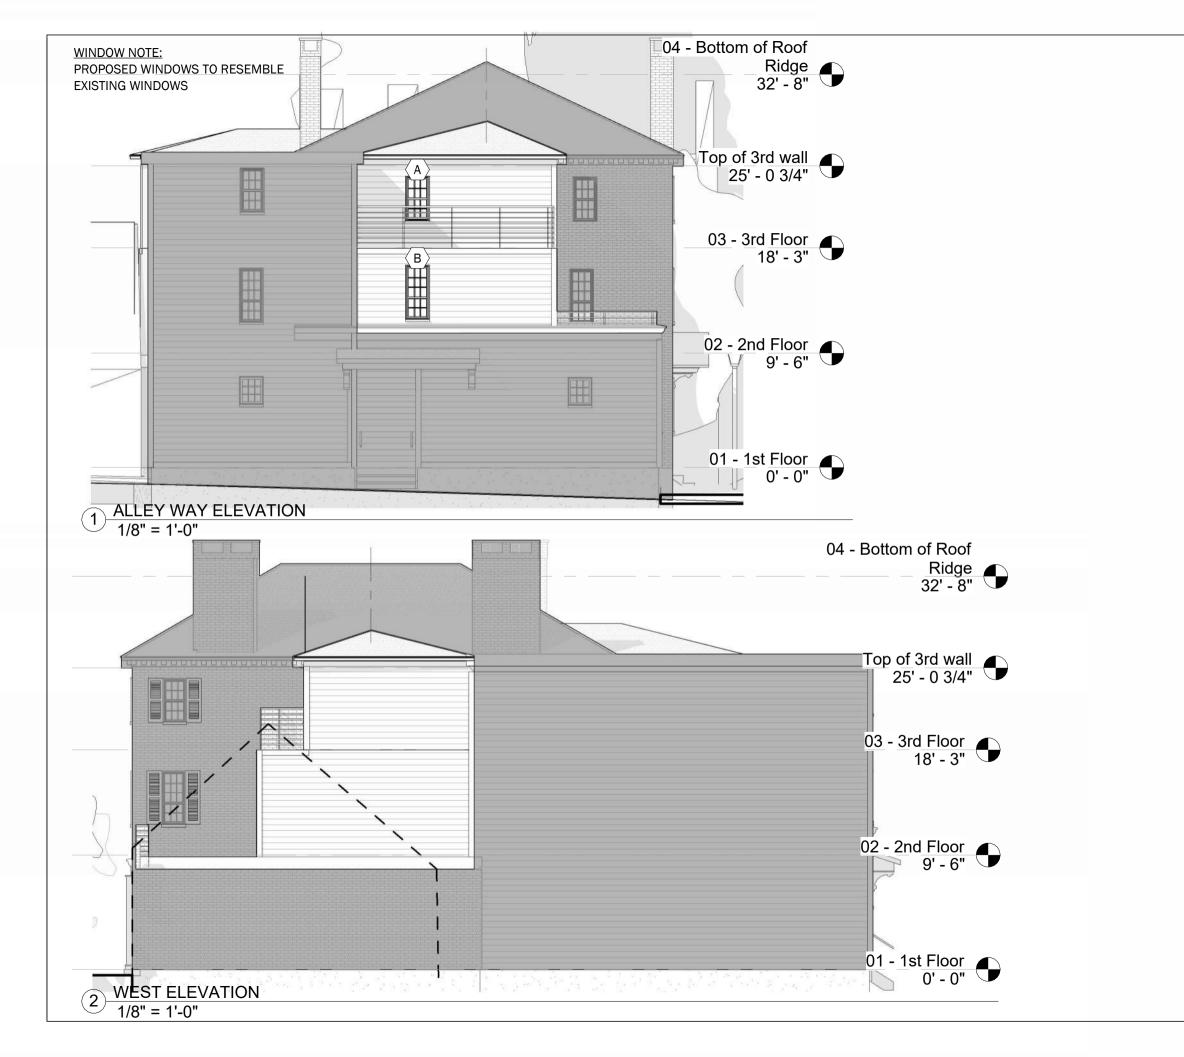



PG BMH

07/26/24

24051

LEGEND

(A)


WINDOW TAG

NOT IN SCOPE


Elevations

A-301

Project Number: drawing revisions:

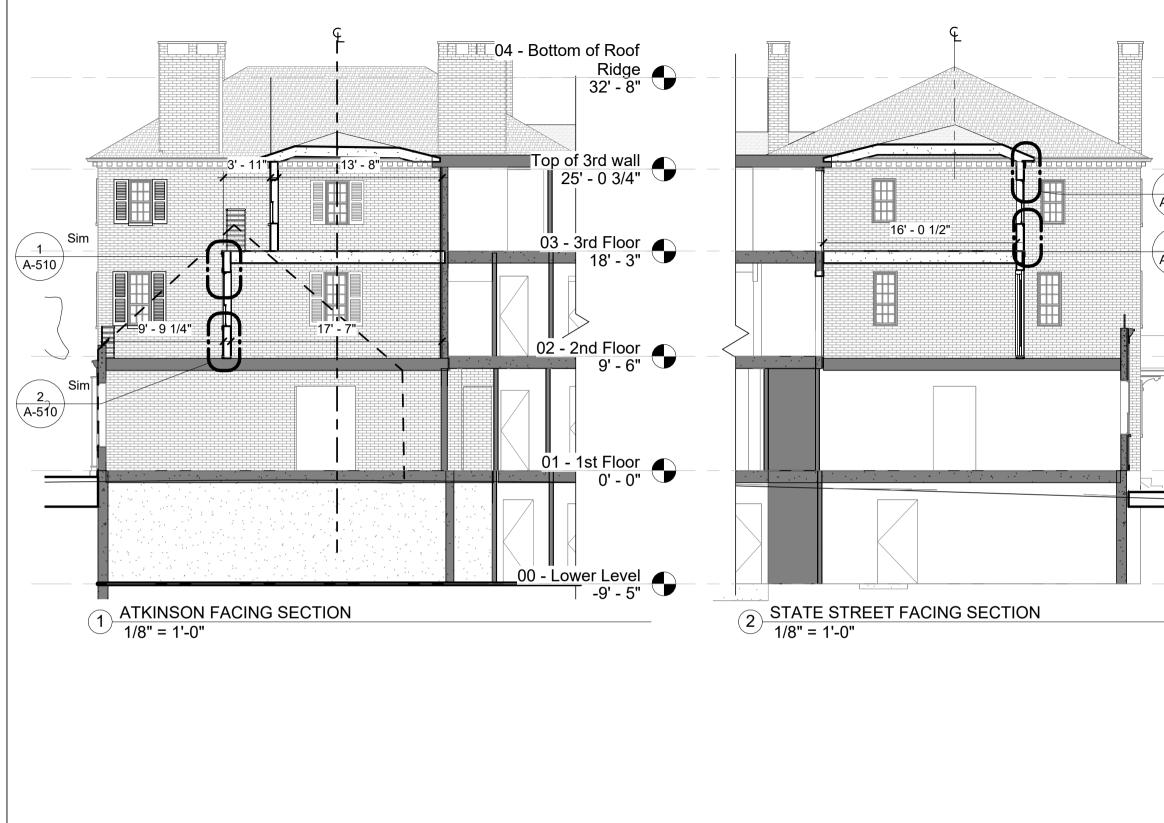


	A-401	
	Building Sections	
	drawing revisions:	
00 - Lower Level -9' - 5"	Drawn By: Drawing Checked By: Drawing Scale: Drawing Date: Project Number:	PG BH 1/8" = 1'-0" 07/26/24 24051
01 - 1st Floor 0' - 0"	KITTERY, MAI	FORD SQ JNIT 2099
02 - 2nd Floor 9' - 6"	WINT HOLB	
Sim 03 - 3rd Floor 10 18' - 3"	Huai Ying Zh Client address City, st zip Phone	-
Sim Top of 3rd wall 25' - 0 3/4"	96 STATE	Por
04 - Bottom of Roof Ridge 32' - 8"	ATE ST	Portsmouth, NH

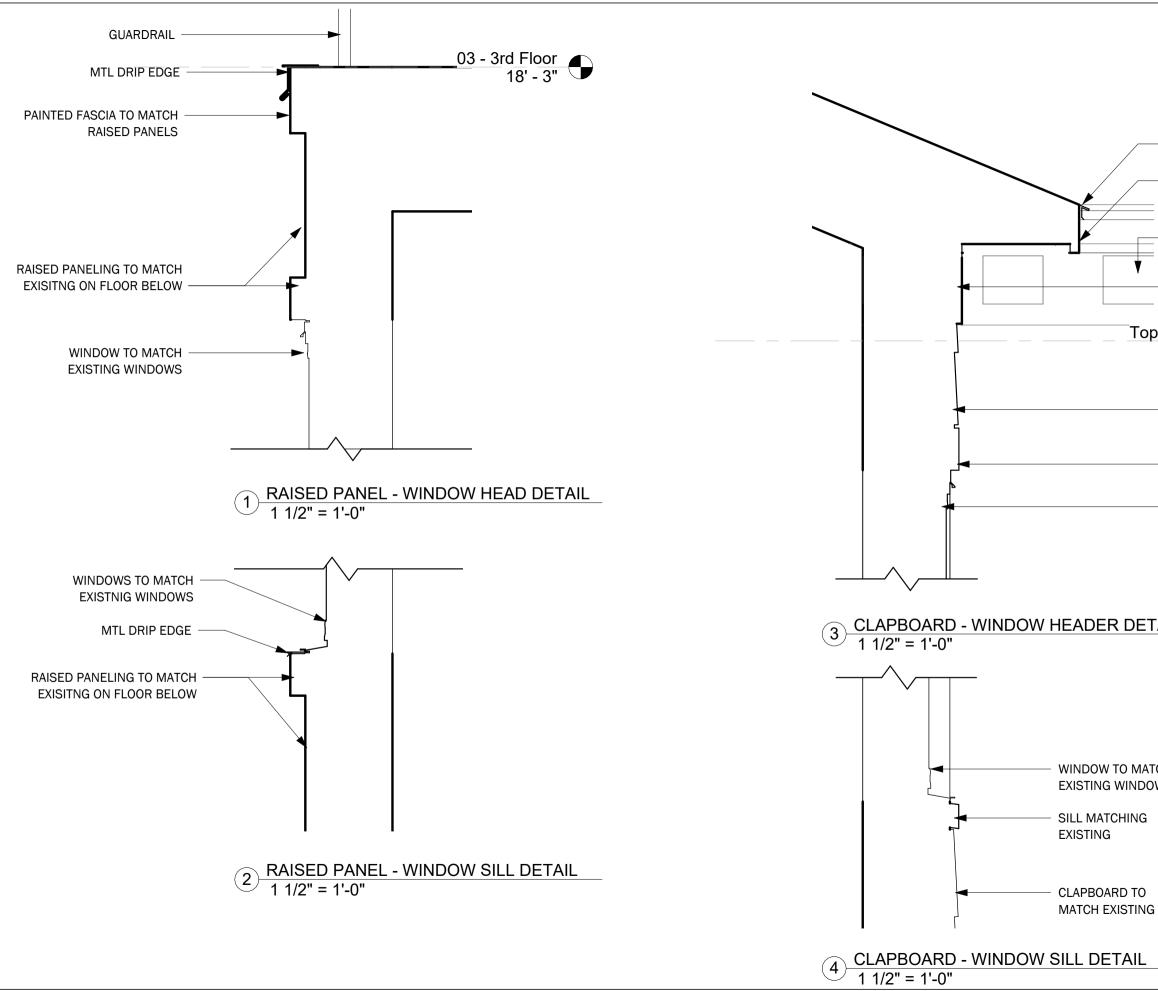

 MTL DRIP EDGE 1X TRIM, ALIGN W/ EXISTING FASCIA 	96 STATE ST. Portsmouth, NH
 EXISTING DENTIL MOLDING 1X TRIM, ALIGN W/ EXISTING FREEZE 	Huai Ying Zheng CLIENT ADDRESS CITY, ST ZIP PHONE
DP Of 3rd wall 25' - 0 3/4" — Clapboard Siding TO MATCH EXISTING	WINTER HOLBEN architecture + design
 — 1X4 TRIM BOARD — WINDOW TO MATCH 	7 WALLINGFORD SQ UNIT 2099 KITTERY, MAINE 03904 207.994.3104
EXISTING TAIL	Drawn By: PG Drawing Checked By: Checker Drawing Scale: 1 1/2" = 1'-0' Drawing Date: 07/26/24 Project Number: 24051 drawing revisions: 07/26/24
ATCH POWS	
) IG	Exterior Details
	A-510

26/2024 11:26:20 AM

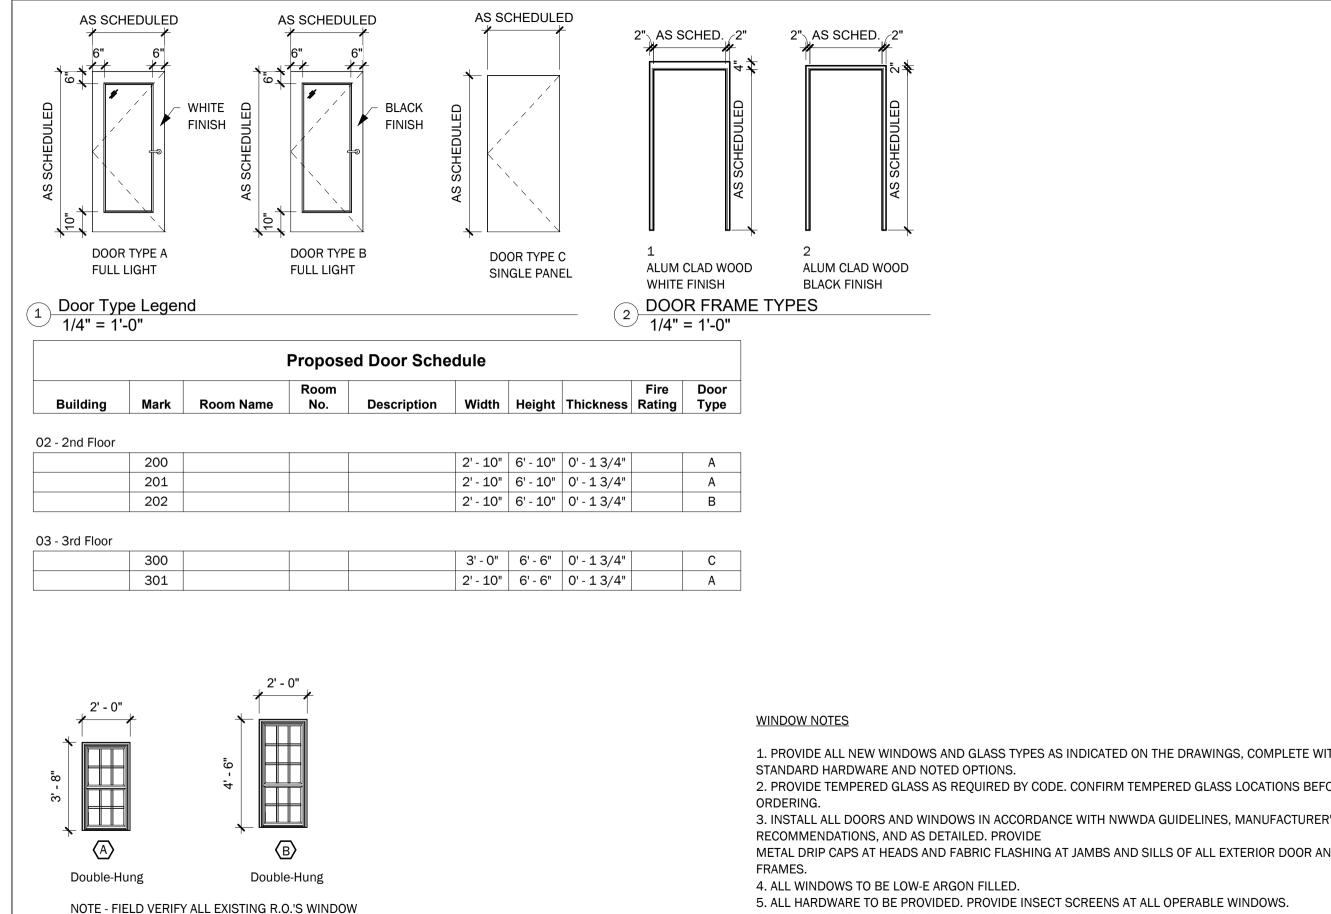

SCHEDULE REPRESENTS INTENT OF DESIGN

Window Types (3 1/4" = 1'-0"

	96 STATE ST.	Portsmouth, NH
	Huai Ying Zh Client address City, st Zip Phone	-
	WINT HOLB architecture 4 7 WALLING KITTERY, MA	FORD SQ JNIT 2099
	207	2.994.3104
	Drawn By: Drawing Checked By:	PG BH
	Drawing Scale:	As indicated
	Drawing Scale: Drawing Date:	As indicated 07/26/24
	Drawing Date:	07/26/24
	Drawing Date: Project Number:	07/26/24
	Drawing Date: Project Number:	07/26/24
ΓH ALL	Drawing Date: Project Number:	07/26/24
	Drawing Date: Project Number:	07/26/24
DRE	Drawing Date: Project Number:	07/26/24
	Drawing Date: Project Number:	07/26/24
DRE	Drawing Date: Project Number: drawing revisions: Door & Window Schedule	07/26/24 24051
DRE 'S	Drawing Date: Project Number: drawing revisions: Drawing revisions:	07/26/24 24051

6. ALL WINDOWS WITHIN 18" OF THE FINISHED FLOOR TO BE TEMPERED.

7. FOR INTERIOR GLAZING, REFER TO INTERIOR WINDOW DETAILS.

8. PROVIDE MULLION DEPTH REQUIRED BY PERFORMANCE REQUIREMENTS & MANUFACTURERS STANDARDS.

Pella® Impervia[®]

Fiberglass

Unmatched strength & lasting durability

Made from our proprietary fiberglass, the strongest material available for windows and patio doors.¹

Sleek, timeless style

Versatile design elements combined with sleek profiles and clean lines deliver a timeless style.

Proven performance

Get outstanding resistance

to water, wind and outside

energy efficiency, security

noises while increasing

and ease of operation.

Pella[®] Impervia[®] Features & Options

Colors & Finishes

Frame Colors

Grille

Patterns

Our long-lasting powder-coat finish resists chalking and fading so you never need to paint or refinish. Solid-Color Frame:

Glass & Additional Energy Efficiency Upgrades



(╝ Advanced AdvancedComfort Low-Einsulating Low-E dual-pane dual- or triple-pane glass with argon glass with arg Additional **Glass Options Bronze-tinted Obscure Low-E** Advanced Low-E insulating glass insulating glass with argon STC (Sound Transmission Class) Triple-pane glass⁶ dual-pane sound control glass⁵ Foam Insulation Optional foam-insulated frames are available to increase energy efficiency. Options Grilles Grilles Grilles are color-matched to the window or patio door interior and exterior frame color. Aluminu Grilles-Between-the Glass 3/4"

Traditiona


9-Lite Prairie

6-Lite Prairie

Pella Impervia products are engineered to last. Our proprietary fiberglass material provides unmatched strength and lasting durability with sleek, timeless style.² And they balance thermal efficiency, scale and value when it matters most.

Don't leave water and structural performance to chance. Tested in extremes and designed for every day, Pella Impervia products are engineered for the rigorous performance requirements of a commercial building and are designed to resist water, wind and outside noises.³ With nearly 100 years in business, it's rare to come across an application that we haven't already designed a robust installation for. We've got you covered with both products and an installation designed for your exact situation. And whether new construction or window replacement, we have a dedicated team of experts to help with your project.


DOUBLE HUNG WINDOWS 26

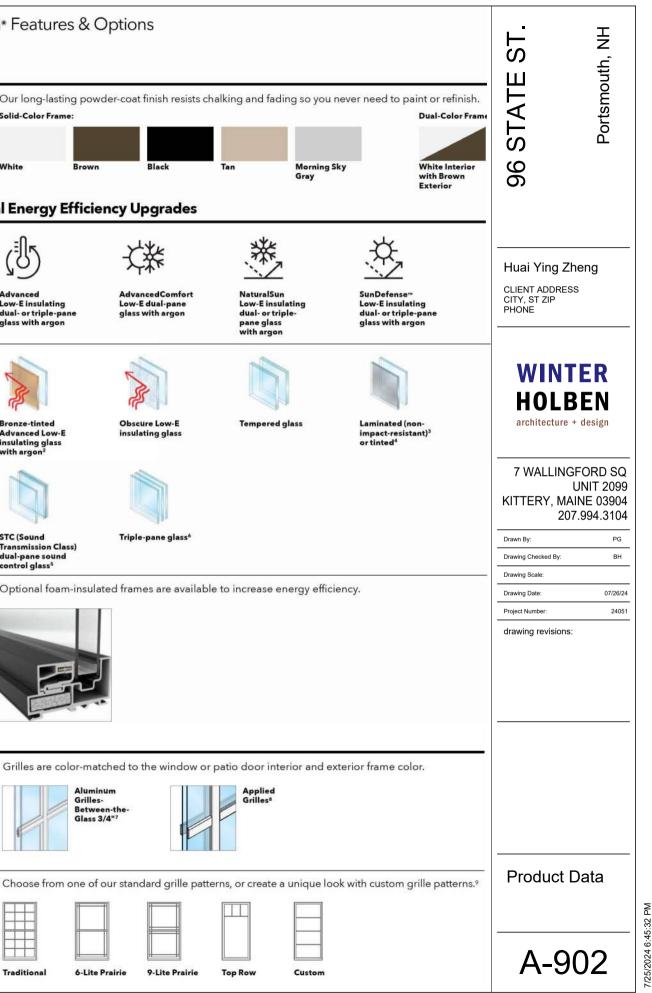

Designed for versatility and beautiful performance

Hardie® Panel

Hardie® Panel delivers style and substance. When combined with Hardie® Trim Batten, it achieves the rustic board-and-batten look that defines your charming cottage or modern farmhouse. Its crisp, clean lines and ability to pair beautifully with other siding products make Hardie® Panel a smart choice for the home of your dreams.

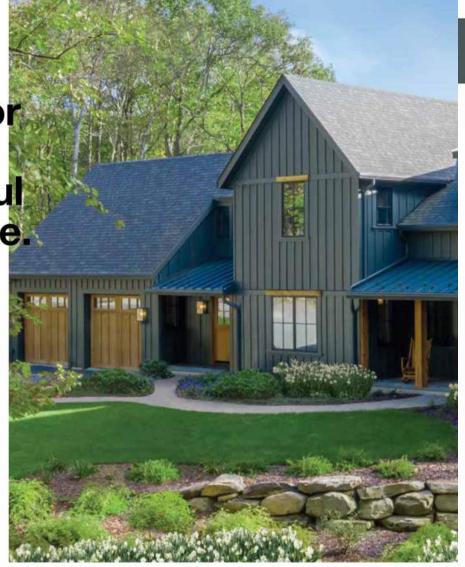

HardiePanel[®]

HardiePanel[®] Vertical Siding Product Description

HardiePanel® vertical siding is factory-primed fiber-cement vertical siding available in a variety of sizes and textures. Examples of these are shown below. Textures include smooth, stucco, Cedarmill® and Sierra 8. HardiePanel vertical siding is 5/16 in. thick and is available in 4x8, 4x9 and 4x10 sizes. Please see your local James Hardie dealer for texture and size availability.

HardiePanel vertical siding is available as a prefinished James Hardie® product with ColorPlus® Technology. The ColorPlus coating is a factory applied, oven baked finish available on a variety of James Hardie siding and trim products. See your local dealer for availability of products, color and accessories.



Stucco

Cedarmill



Sierra 8









Scan code to view product availability.

20



Above: Hardie® Panel & Hardie® Trim Batten Blue Rive Right: Hardie® Panel & Hardie® Trim Batten Timber Bark; Hardie® Trim Khaki Brown



HARDIE PANEL SIDING







ΗN ^oortsmouth,

Huai Ying Zheng

CLIENT ADDRESS CITY, ST ZIP PHONE

WINTER HOLBEN

architecture + design

7 WALLINGFORD SQ **UNIT 2099** KITTERY, MAINE 03904 207.994.3104

Drawn By:	PG
Drawing Checked By:	BH
Drawing Scale:	
Drawing Date:	07/26/24
Project Number:	24051

drawing revisions:

Product Data

A-902B

Σ