

RAYNES AVE - PORTSMOUTH, NH 11/15/2021

RAYNES AVENUE

PORTSMOUTH, NEW HAMPSHIRE

SITE LANDSCAPE PLAN REFERENCE



HISTORIC DISTRICT COMMISSION APPLICATION FOR APPROVAL: **JANUARY 4, 2023**

SITE LANDSCAPE PLAN

Tighe&Bond





0.1



MAPLEWOOD BRIDGE VIEW









MAPLEWOOD BRIDGE VIEW



HISTORIC DISTRICT COMMISSION APPLICATION FOR APPROVAL: JANUARY 4, 2023



1.0B




RAYNES AVENUE ENTRY VIEW







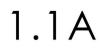



RAYNES AVENUE

PORTSMOUTH, NEW HAMPSHIRE

RAYNES AVENUE ENTRY VIEW



HISTORIC DISTRICT COMMISSION APPLICATION FOR APPROVAL: JANUARY 4, 2023





1.1B



VAUGHAN STREET VIEW











VAUGHAN STREET VIEW



HISTORIC DISTRICT COMMISSION APPLICATION FOR APPROVAL: JANUARY 4, 2023





1.2B



VIEW ACROSS NORTH MILL POND











VIEW ACROSS NORTH MILL POND



HISTORIC DISTRICT COMMISSION APPLICATION FOR APPROVAL: JANUARY 4, 2023





1.3B



NIGHT RENDERING



HISTORIC DISTRICT COMMISSION APPLICATION FOR APPROVAL: JANUARY 4, 2023



2.0



RAYNES AVE VIEW



HISTORIC DISTRICT COMMISSION APPLICATION FOR APPROVAL: JANUARY 4, 2023





2.1



RAYNES AVENUE

PORTSMOUTH, NEW HAMPSHIRE

VIEW AT 3S ARTSPACE











VIEW ACROSS NORTH MILL POND FROM MARKET STREET











RAYNES AVENUE

PORTSMOUTH, NEW HAMPSHIRE

VIEW ACROSS NORTH MILL POND







2.4



VIEW ACROSS NORTH MILL POND



HISTORIC DISTRICT COMMISSION APPLICATION FOR APPROVAL: JANUARY 4, 2023





2.5

LEGEND

HOTEL

RESIDENTIAL


RESTAURANT/OFFICE/RETAIL






OVERALL SITE PLAN

HISTORIC DISTRICT COMMISSION APPLICATION FOR APPROVAL: JANUARY 4, 2023

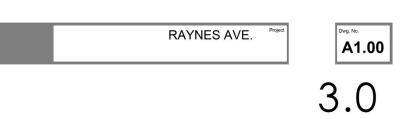

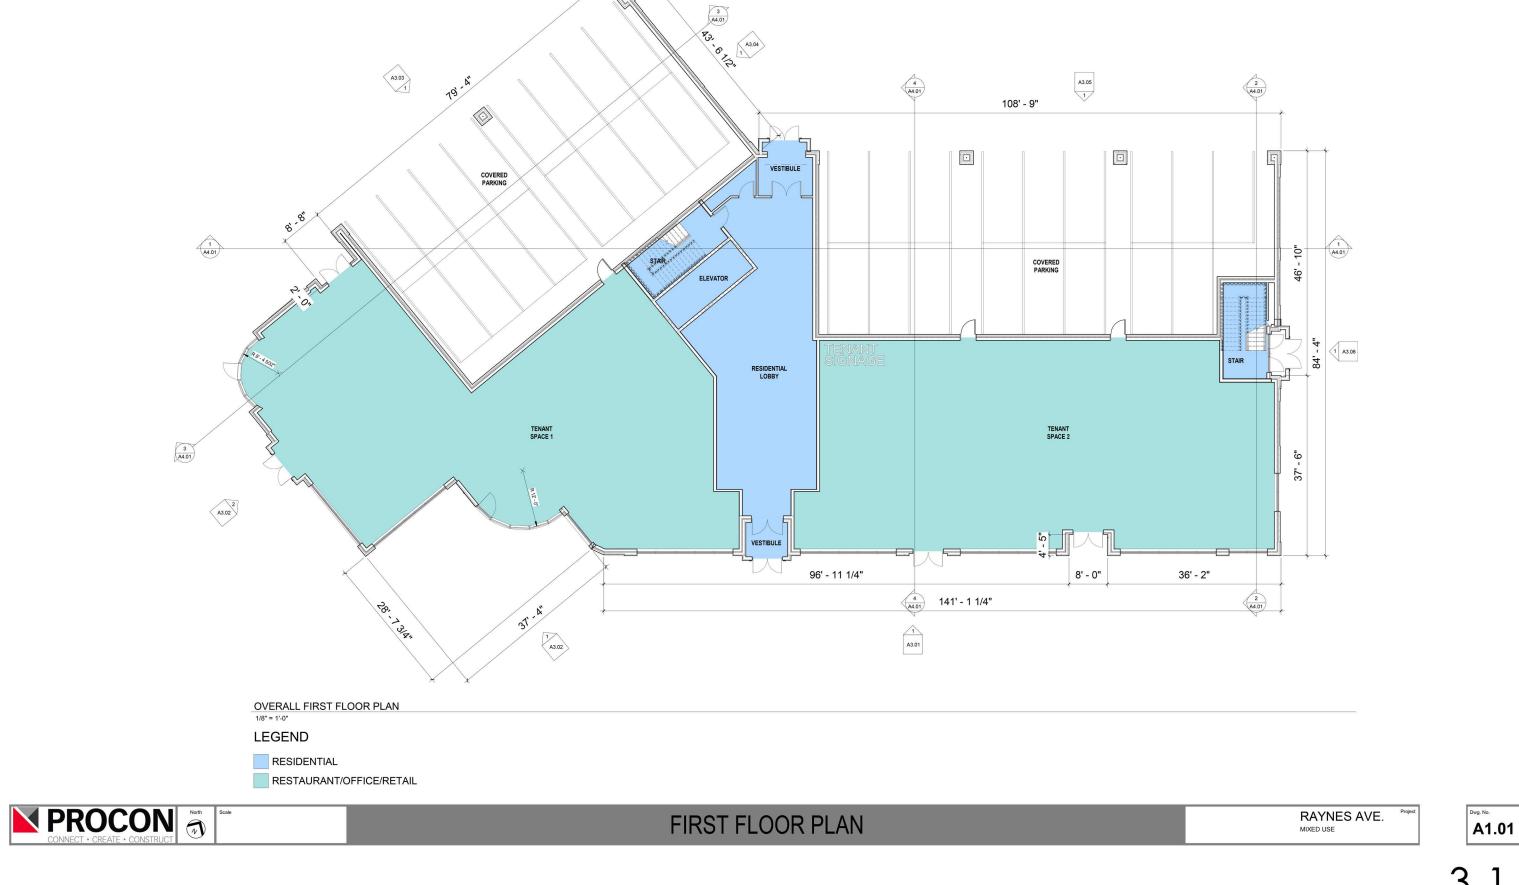









SECOND FLOOR PLAN




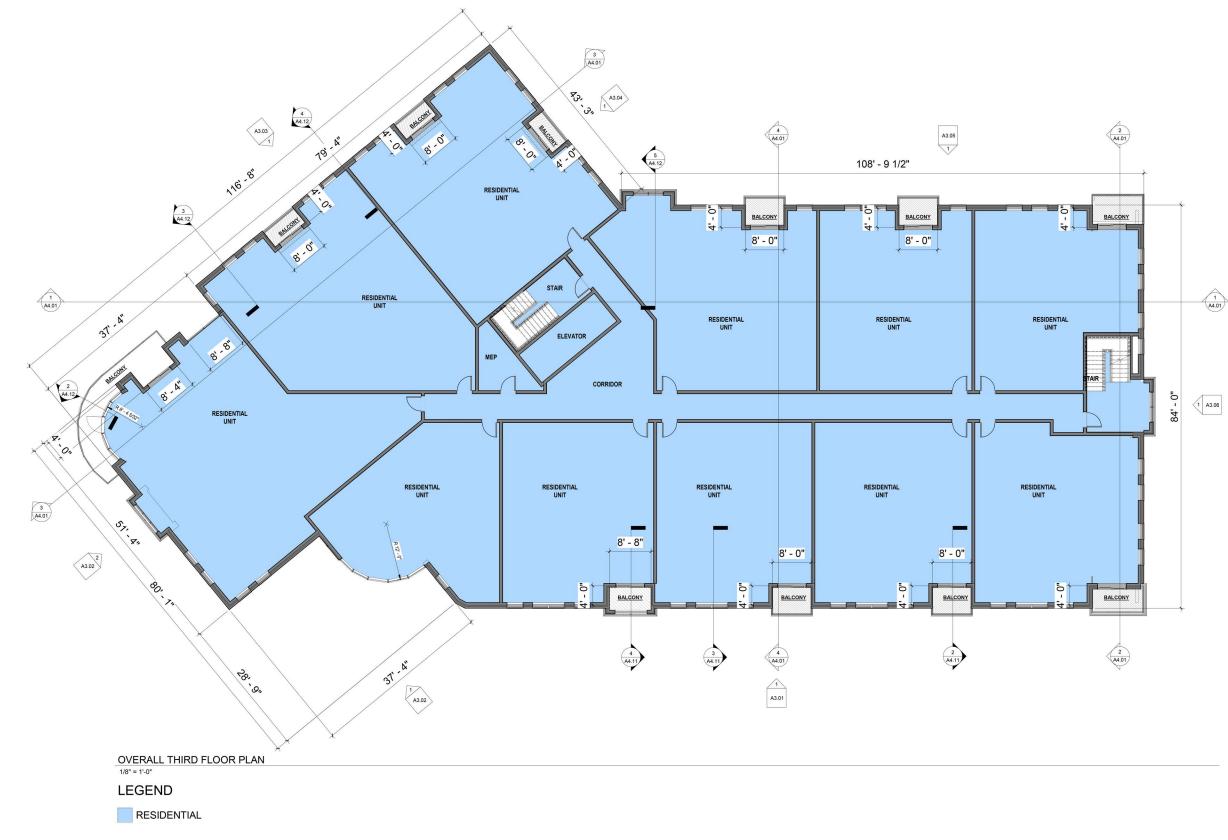



THIRD FLOOR PLAN

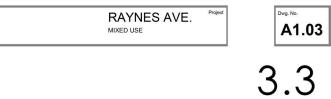

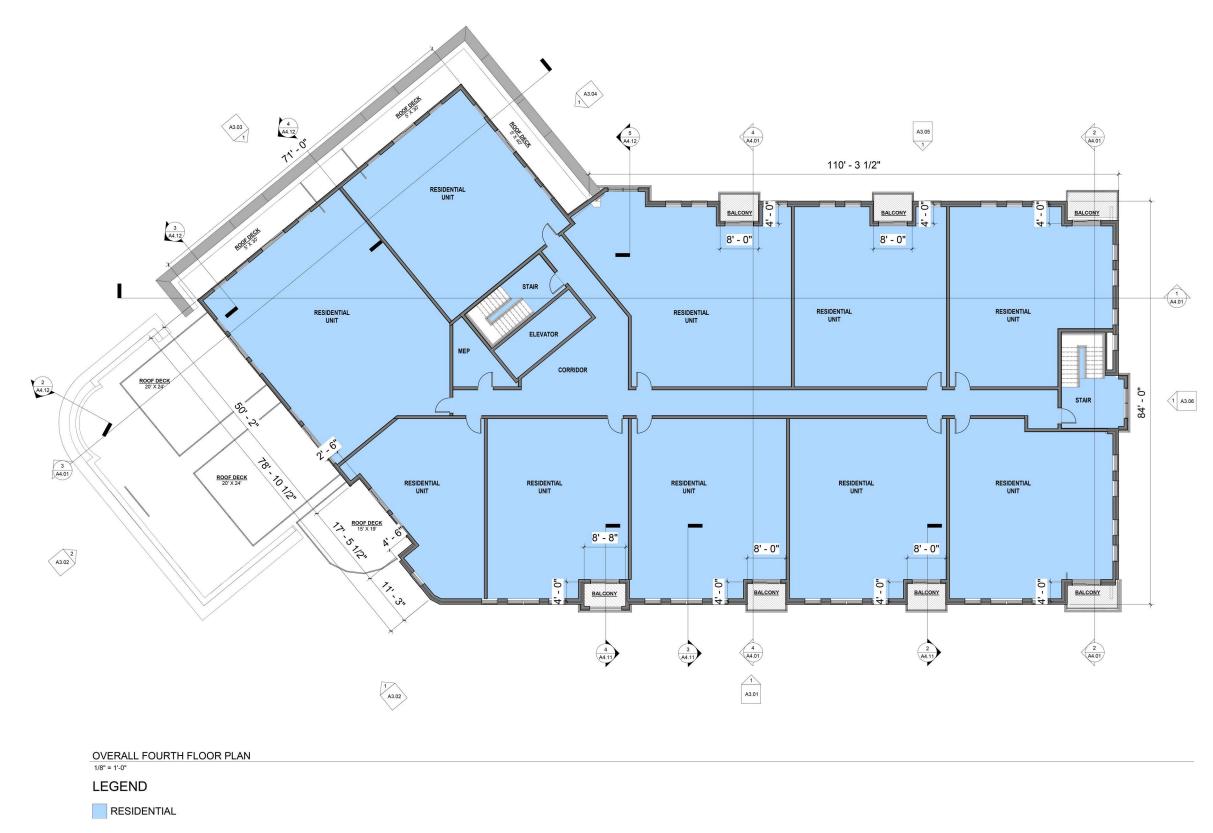



FOURTH FLOOR PLAN








PENTHOUSE FLOOR PLAN

RESIDENTIAL

LEGEND


OVERALL PENTHOUSE FLOOR PLAN 1/8" = 1'-0"

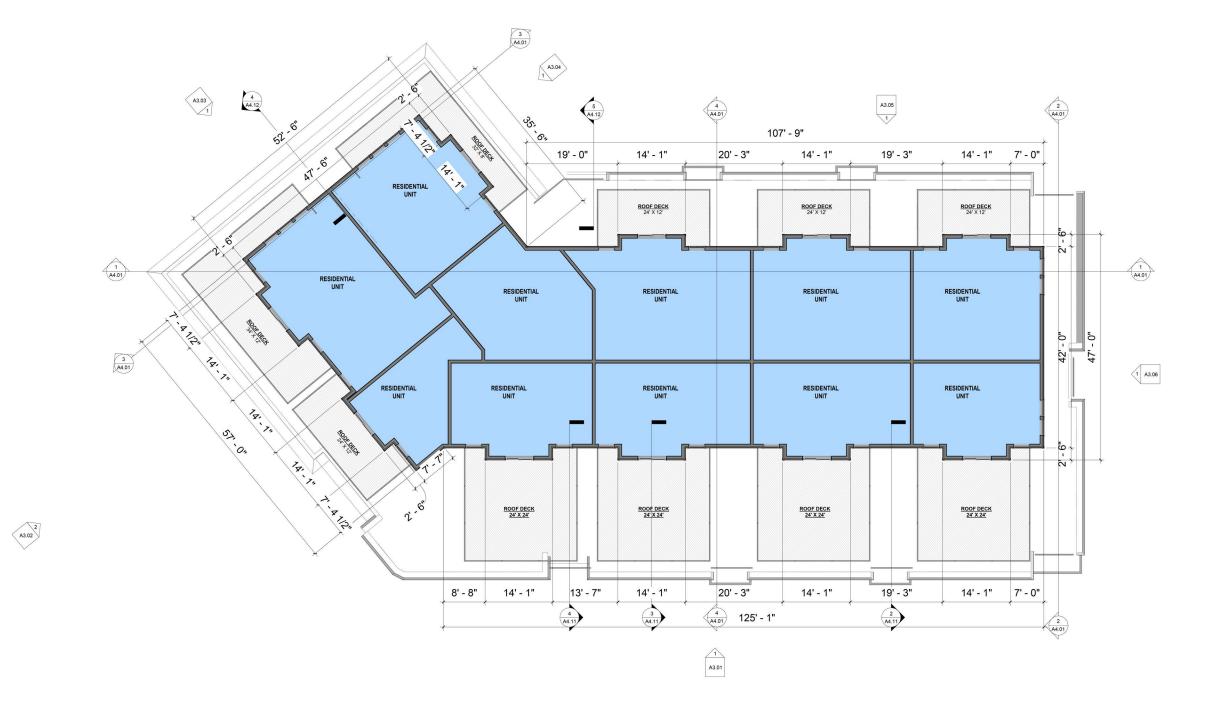



RAYNES AVE.

MIXED USE

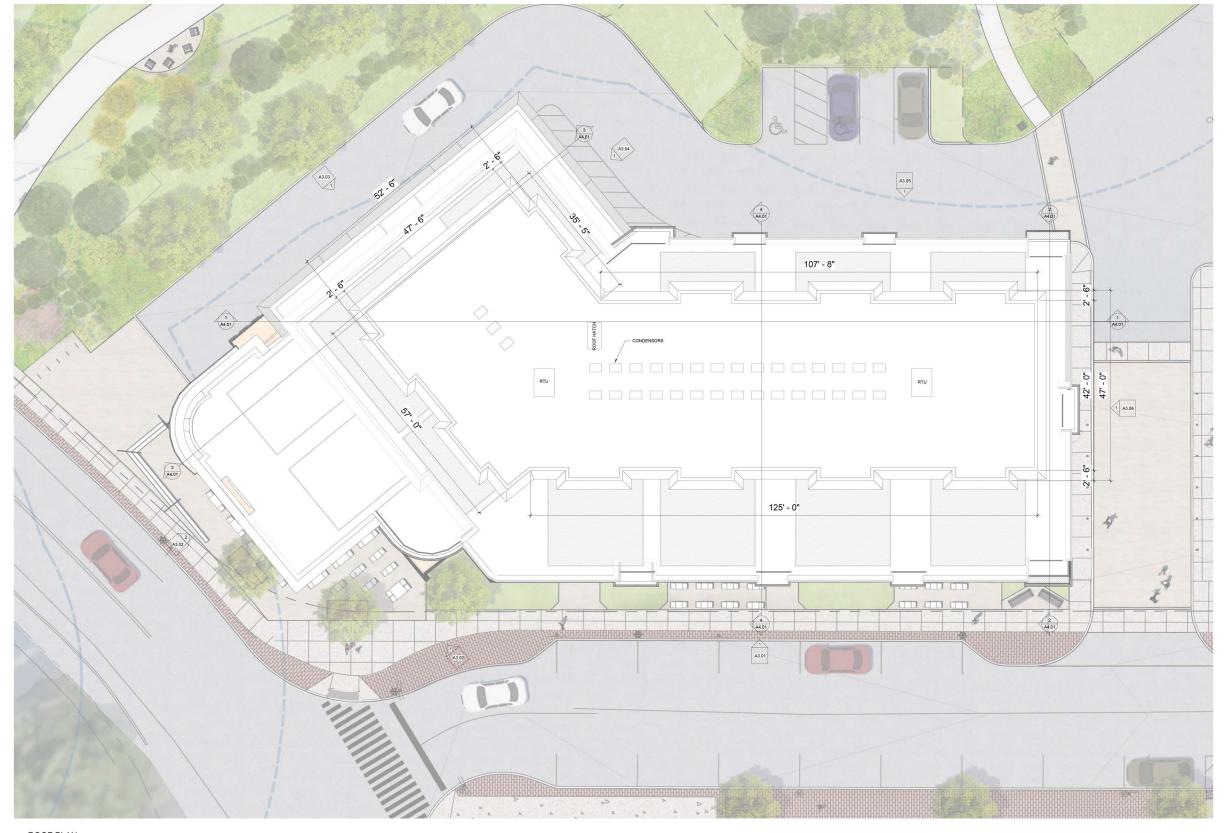



ROOF PLAN




RAYNES AVE.



Scale


ELEVATIONS



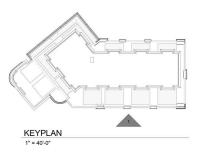



MIXED USE

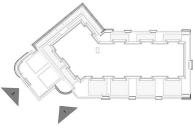





ELEVATIONS






ELEVATIONS




KEYPLAN 1" = 40'-0"

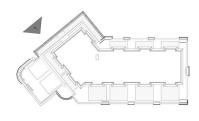



RAYNES AVE.

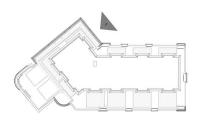


KEYPLAN 1" = 40'-0"





ELEVATIONS

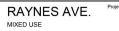




3.10 NOT TO SCALE




ELEVATIONS





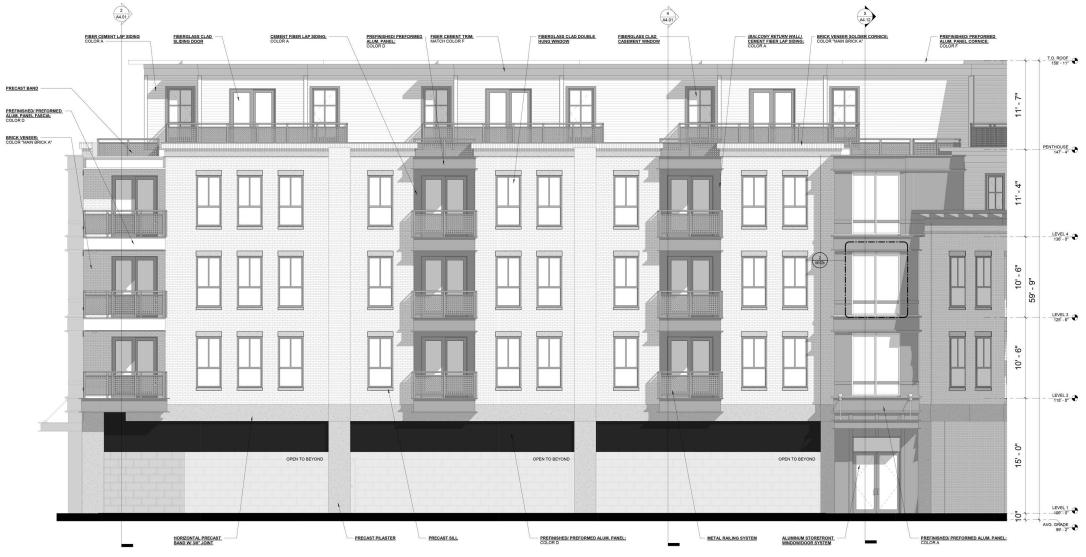



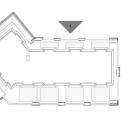




3.11 NOT TO SCALE






ELEVATIONS

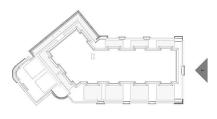


KEYPLAN 1" = 40'-0"

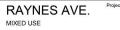





3.12 NOT TO SCALE

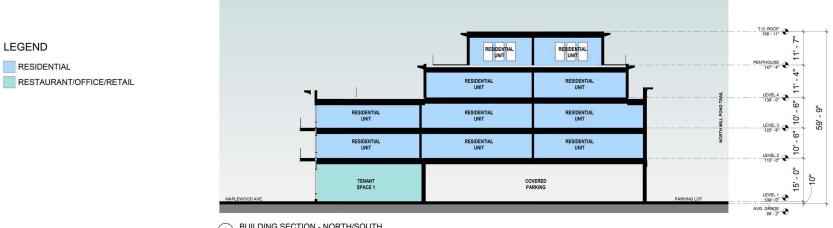

³ BUILDING SECTION - NORTH/SOUTH SCALE: 3/32" = 1"-0" REF SHEET: 1 / A1.01

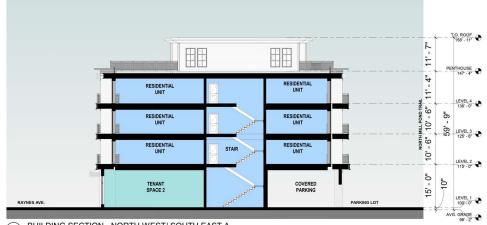


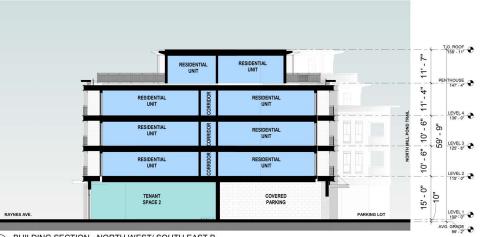

BUILDING SECTION - NORTH WEST/ SOUTH EAST A 2 SCALE: 3/32" = 1'-0" REF SHEET: 1 / A1.01

LEGEND


BUILDING SECTION - NORTH WEST/ SOUTH EAST B (4) SCALE: 3/32" = 1'-0" REF SHEET: 1 / A1.01

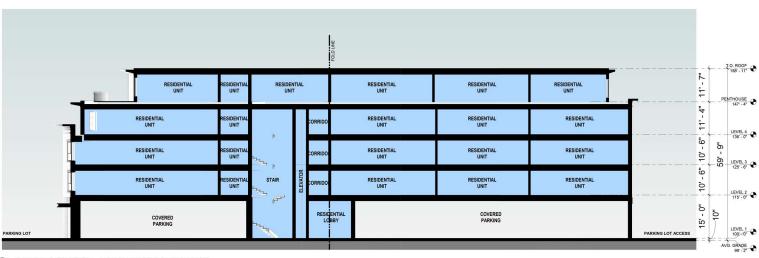

BUILDING SECTION - NORTH EAST/SOUTH WEST SCALE: 3/32" = 1'.0" SCALE: 3/32" = 1'-0" REF SHEET: 1 / A1.01



BUILDING SECTIONS

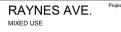







WALL SECTION - AT LEVEL 2 PRECAST BAND

REF SHEET: 1 / A3.01

PREFINISHED/ PREFORMED ALUM. PANEL CORNICE

1 A4.31

RESIDENT UNIT

> RESIDENTIA UNIT

RESIDENTIAL

UNIT

TENANT SPACE 1

SCALE: 1/4" = 1'-0"

RESIDENTIAL UNIT

WOOD FLOOR TRUSS

CONCRETE SLAB ON DECK

> CONCRETE SLAB ON GRADE

(5)

WALL SECTIONS

WALL SECTION - TYPICAL WINDOWS

24' - 1 1/2"

(2) (A4.31)

£U,

A

đ

H1 A6.01

S1 A6.01 F.G. CLAD WINDOW

BRICK

PRECAST WINDOW LINTEL

HORIZONTAL PRECAST BAND

> STOREFR WINDOW SYSTEM

ALUM. PANEL SIDING

> PAVEMEN WALKWAY SEE CIVIL DWG'S

CONCRETE FOUNDATION WALL AND FOOTING

REF SHEET: 1 / A1.02

(7 (A4.31)

PRECAST 0 WINDOW SILL T.O. ROOF

LEVEL 4

LEVEL 3

LEVEL 2 115' - 0"

LEVEL 1

AVG. GRADE

FIBER CEMENT LAP SIDING

F.G. CLAD SLIDING DOOR

ROOF DECK SYSTE

PRECAST/THIN
 BRICK CORNICE W/
 PREFINISHED/
 PREFORMED ALUM.
 CAP FLASHING

"8" NTE

8" NTEL

2" - 10" BRICK

SILL

12

4" SILL 6'-1

F.G. BRICK

10

4" SILL

PREFINISHED/ PREFORMED ALUM. PANEL CORNICE

(1) (A4.31)

RESIDENTIAL UNIT

> RESIDENTIAL UNIT

RESIDENTIAL

UNIT

RESIDENTIAL

UNIT

TENANT SPACE 2

SCALE: 1/4" = 1'-0"

WOOD FLOOR TRUSS

CONCRETE SLAB ON DECK

CONCRETE SLAB ON GRADE

(3)

T.O. ROOF

HOUSE

LEVEL 4 136' - 0"

LEVEL 3 125' - 6"


LEVEL 2 115' - 0"

LEVEL 1 100' - 0"

AVG. GRADE

PAVEMENT/WALKWA' - SEE CIVIL DWG'S

CONCRETE FOUNDATION WALL AND FOOTING

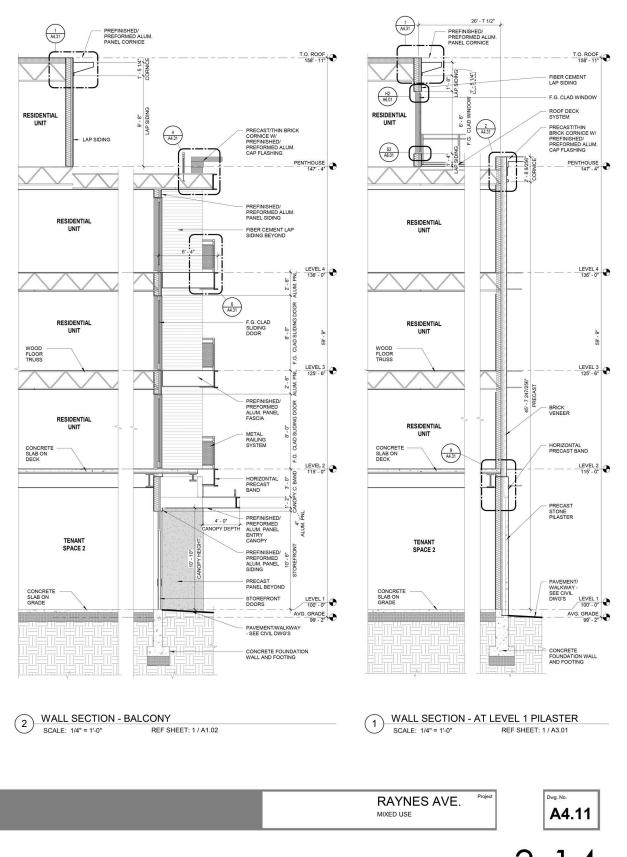

WALL SECTION - RESIDENTIAL ENTRANCE

22' - 7 1/2"

(11 A4.31 PREFINISHED/ PREFORMED ALUM. PANEL CORNICE

F.G. CLAD WINDOW

METAL RAILING SYSTEM

PRECAST/THINBRICK CORNICE W/ PREFINISHED

> FIBER CEMENT LAP SIDING SIDING

LAP SIDING BEYOND

F.G. CLAD
 SLIDING DOOR

PY DEPTH

GLASS AND
 PREFINISHED
 PREFORMED
 ALUM. PANEL
 CANOPY

STOREFRONT DOORS

VESTIBULE

REF SHEET: 1 / A1.02

-14'-

ORMED ALUM. CAP

ROOF DECK SYSTEM

(1) (A4.31)

H2 A6.01

RESIDENTIAL

UNI

82 A6.01

WOOD FLOOR TRUSS

CONCRETE SLAB ON DECK

CONCRET SLAB ON GRADE

(4)

 \square

RESIDENTIAL UNIT

RESIDENTIAL UNIT

RESIDENTIAL UNIT

RESIDENTIAL LOBBY

SCALE: 1/4" = 1'-0"

T.O. ROOF

LEVEL 4 136' - 0"

LEVEL 3

LEVEL 2

LEVEL 1 100' - 0"

AVG. GRADE

- HORIZONTAL PRECAST BAND

8 A4.31

> PAVEMENT WALKWAY SEE CIVIL DWG'S

CONCRETE FOUNDATION WALL AND

FIBER CEMENT LAP SIDING

THINBRICK CORNICE W PREFINISHE PREFORME ALUM. CAP FLASHING

2 A4.31


> 3.14 NOT TO SCALE


8' - 5 1/2'



17' - 9 1/2"


3.15

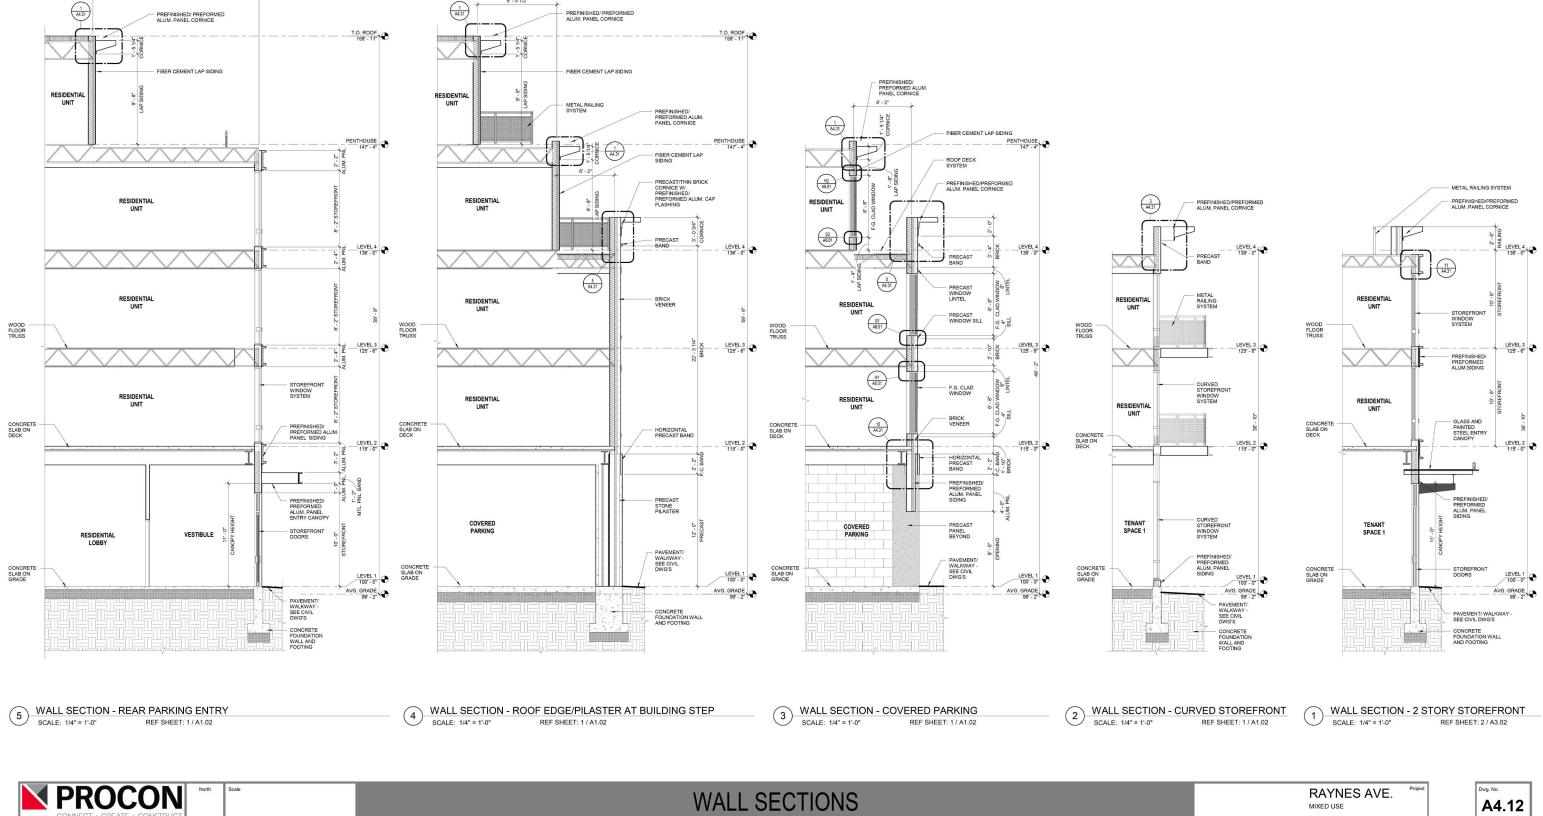

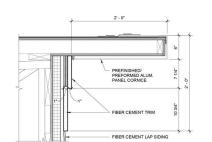


 PREFORMED METAL CORNICE L4/PENTHOUSE


 SCALE: 1 1/2" = 1'-0"
 REF SHEET: 1 / A4.11

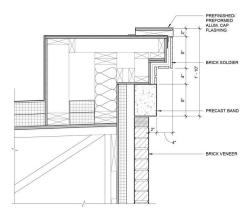


2 BRICK CORNICE W/ STONE FRIEZE (PENTHOUSE) SCALE: 1 1/2" = 1'-0" REF SHEET: 1 / A4.11

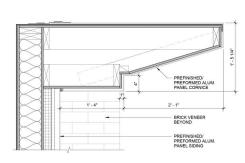


3 ALUMINUM CORNICE @ CURVED STOREFRONT SCALE: 11/2" = 1'-0" REF SHEET: 2 / A4.12

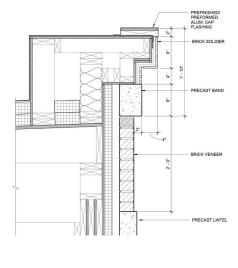


4 LINTEL AT BALCONY SCALE: 1 1/2" = 1'-0" REF SHEET: 2 / A4.11

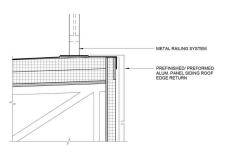



(1) ROOF EDGE AT METAL PANEL SCALE: 1 1/2" = 1'-0" REF SHEET: 4 / A4.11

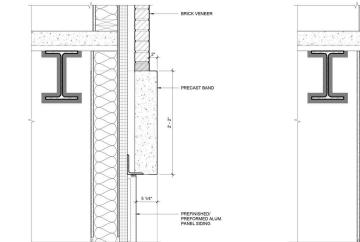

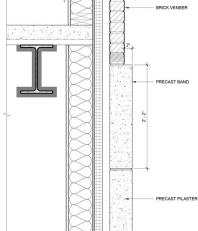

9 BAND AT COVERED PARKING SCALE: 1 1/2" = 1'-0" REF SHEET: 1 / A4.11

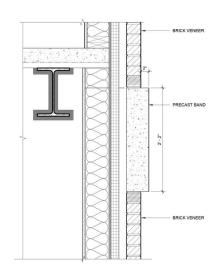

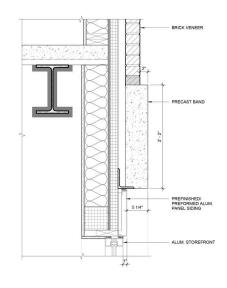

7 L2 PRECAST BAND AT METAL PANEL/STOREFRONT SCALE: 1 1/2" = 1'-0" REF SHEET: 3 / A4.11




 BAND AT METAL PANEL

 SCALE: 1 1/2" = 1'-0"
 REF SHEET: 3 / A4.12


PROPOSED DETAILS

REF SHEET: 5 / A4.11

8 LEVEL 1 PRE CAST PILASTER SCALE: 1 1/2" = 1'-0" REF SHEET

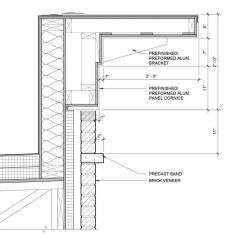

5 ALUMINUM CORNICE AND ACCENT L4 SCALE: 11/2" = 1'-0"

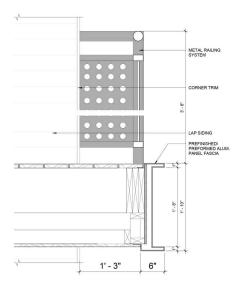

6 BALCONY EDGE SCALE: 1 1/2" = 1'-0"

REF SHEET: 2 / A4.11 RAYNES AVE.

MIXED USE



Dwg. No.







3" - 2 1/2"

8" HEIGHT PRECAST LINTEL

MULLION


3" - 2 1/2"

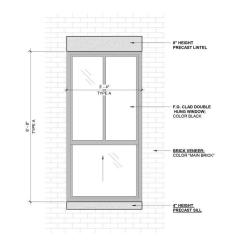

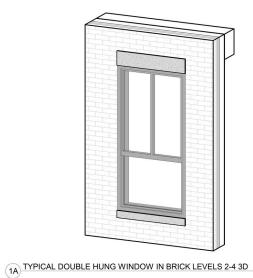

 FIBERGLASS CLAD WINDOW HEAD BRICK

 SCALE: 3" = 1'-0"
 REF SHEET: 3 / A4.11

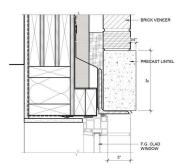





Projec RAYNES AVE. MIXED USE




(S2) FIBERGLASS CLAD WINDOW SILL FIBER CEMENT LAP SIDING SCALE: 3" = 1'-0" REF SHEET: 1 / A4.11

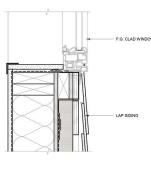


 $\fbox{12} - \overbrace{\text{SCALE: } 3^* = 1^{-0^*}}^{\text{FIBERGLASS CLAD WINDOW JAMB FIBER CEMENT LAP SIDING}}$

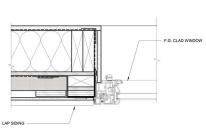


(H2) FIBERGLASS CLAD WINDOW HEAD FIBER CEMENT LAP SIDING SCALE: 3" = 1'-0" REF SHEET: 1 / 44.11

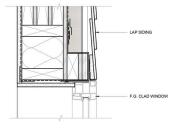




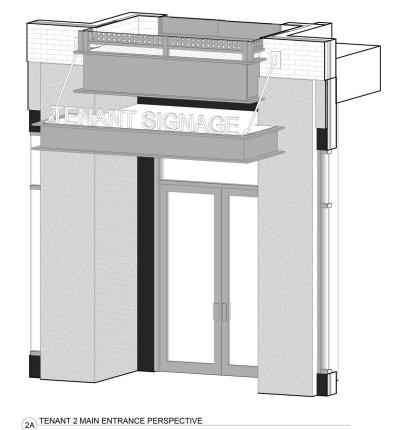

(1A) TENANT 1 MAIN ENTRANCE PERSPECTIVE

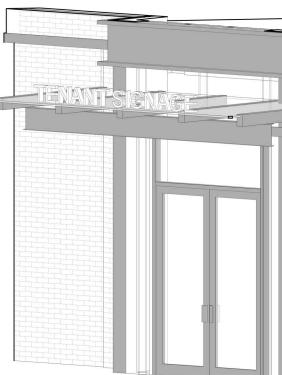




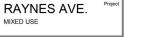

MIXED USE



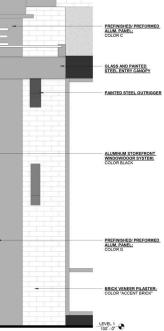

LEVEL 2 115'-0"


1	
1	
-	





7' - 10"

N.


ALUMINUM STOREFRONT ELEVATIONS

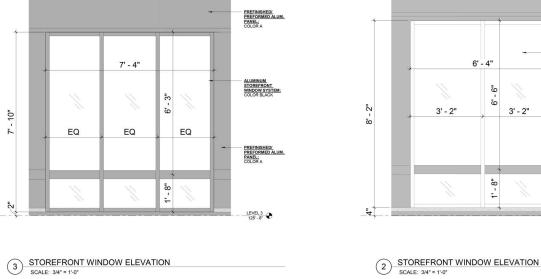

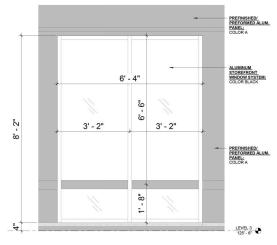

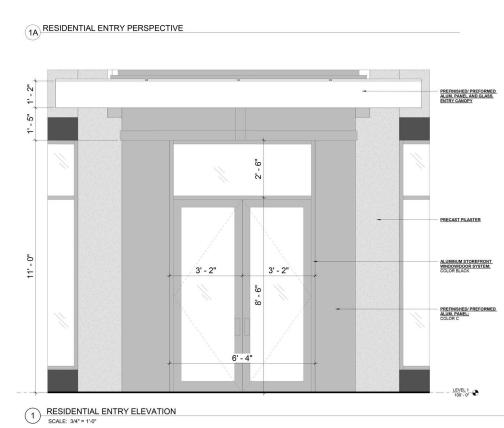

3A STOREFRONT WINDOW PERSPECTIVE

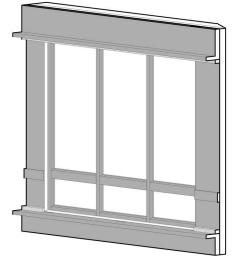



2A STOREFRONT WINDOW PERSPECTIVE










Dwg. No.


A6.02b

RAYNES AVE. MIXED USE

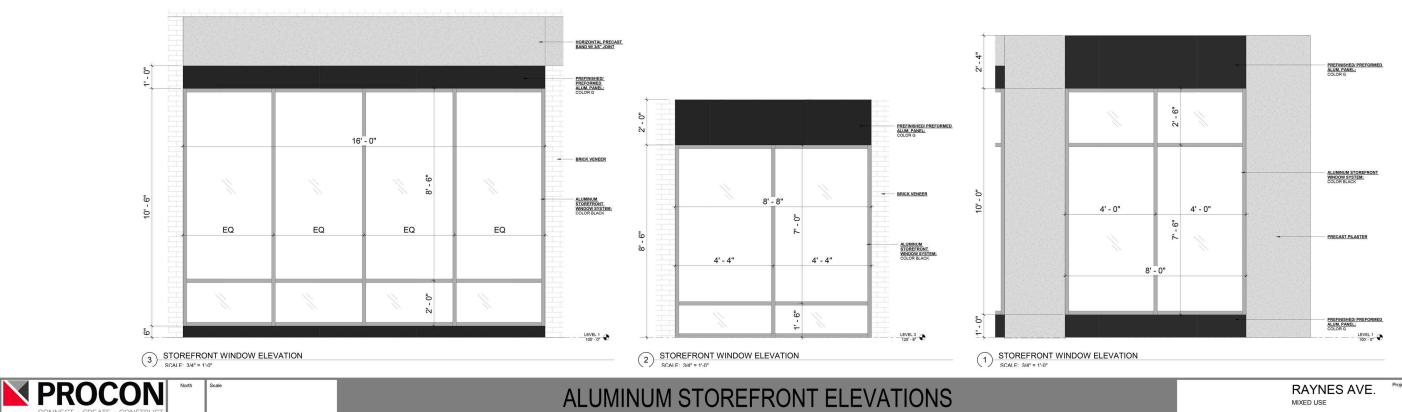

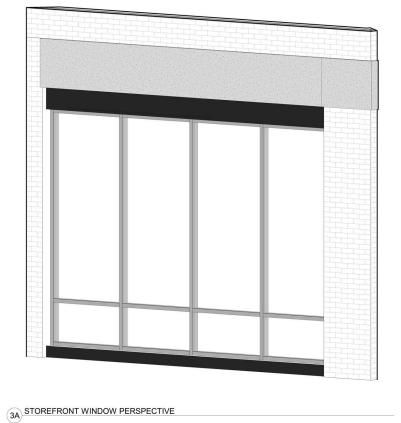

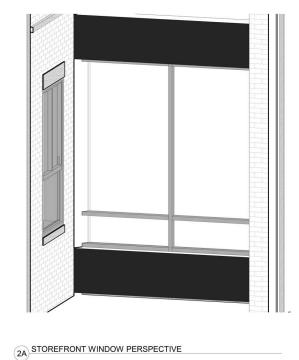

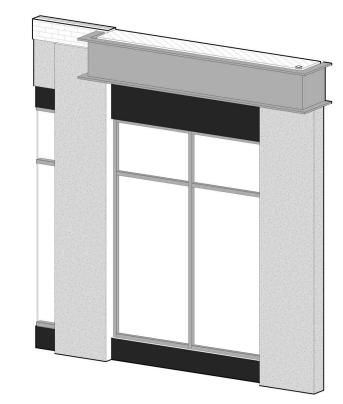





Dwg. No.


A6.02c

MIXED USE

1A STOREFRONT WINDOW PERSPECTIVE

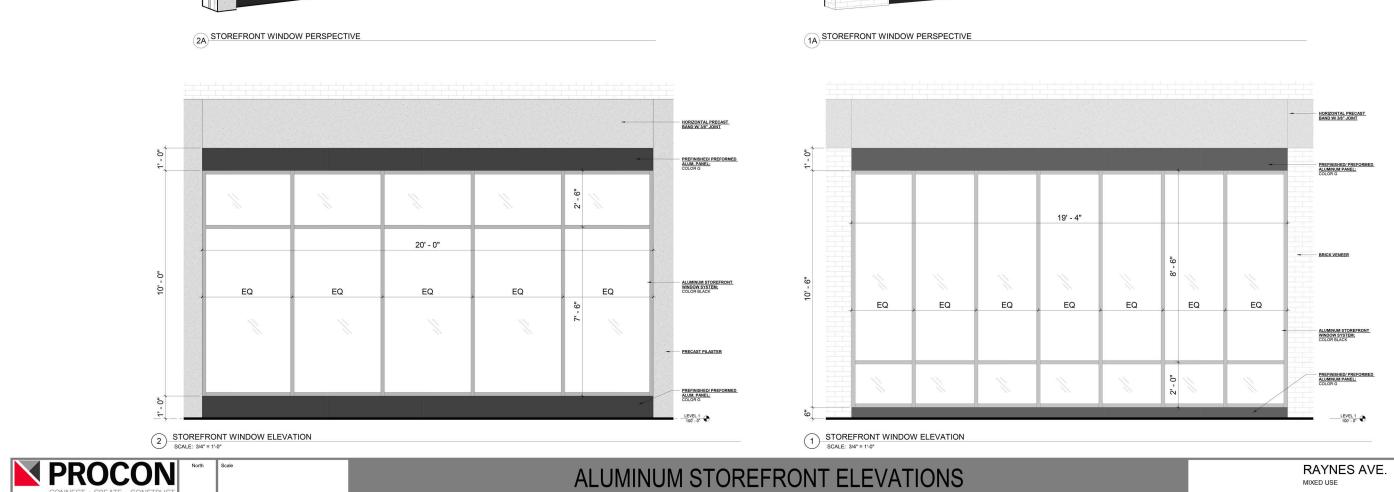

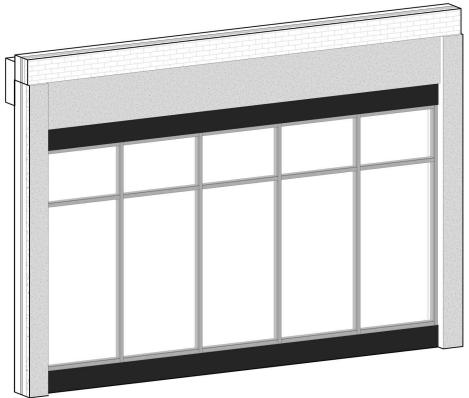

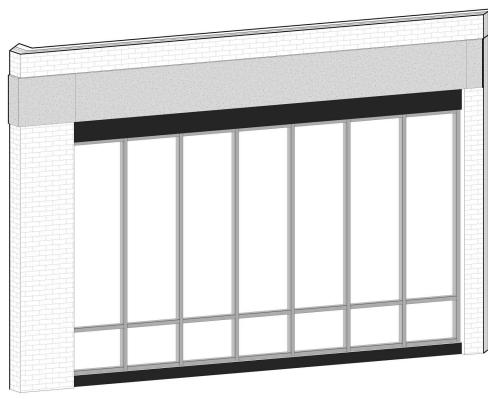




Dwg. No




CURVED STOREFRONT PERSPECTIVES

2 CURVED OUTSIDE CORNER STOREFRONT PERSPECTIVE

1 CURVED INSIDE CORNER STOREFRONT PERSPECTIVE

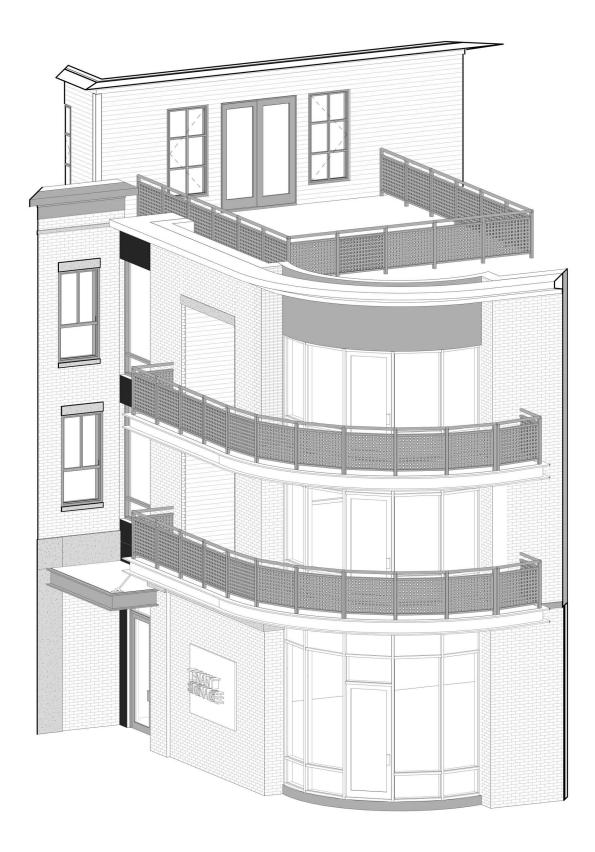

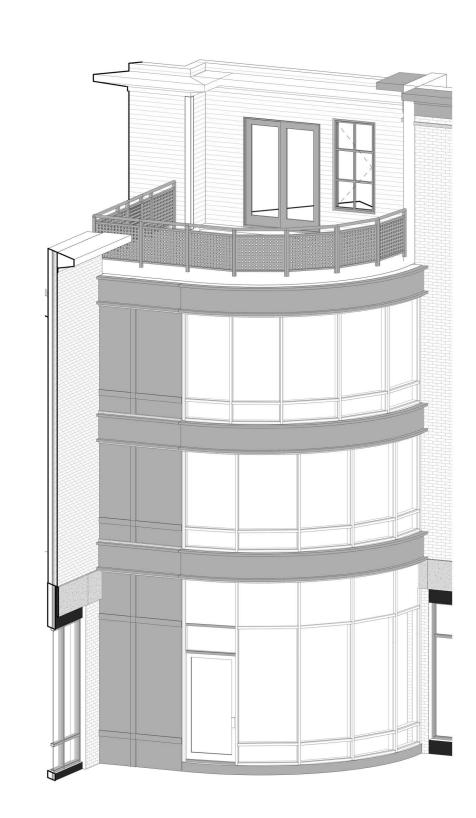






Dwg. No.

NOT TO SCALE




STOREFRONT DETAILS


S1 STOREFRONT SILL METAL PANEL SCALE: 3" = 1'-0"

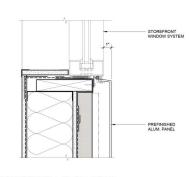




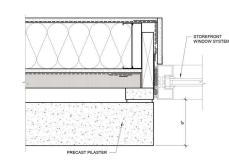




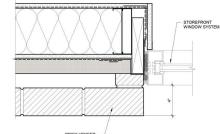


(H1) STOREFRONT HEAD METAL PANEL SCALE: 3" = 1'-0"

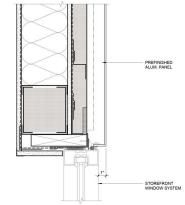

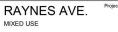



3.23 NOT TO SCALE

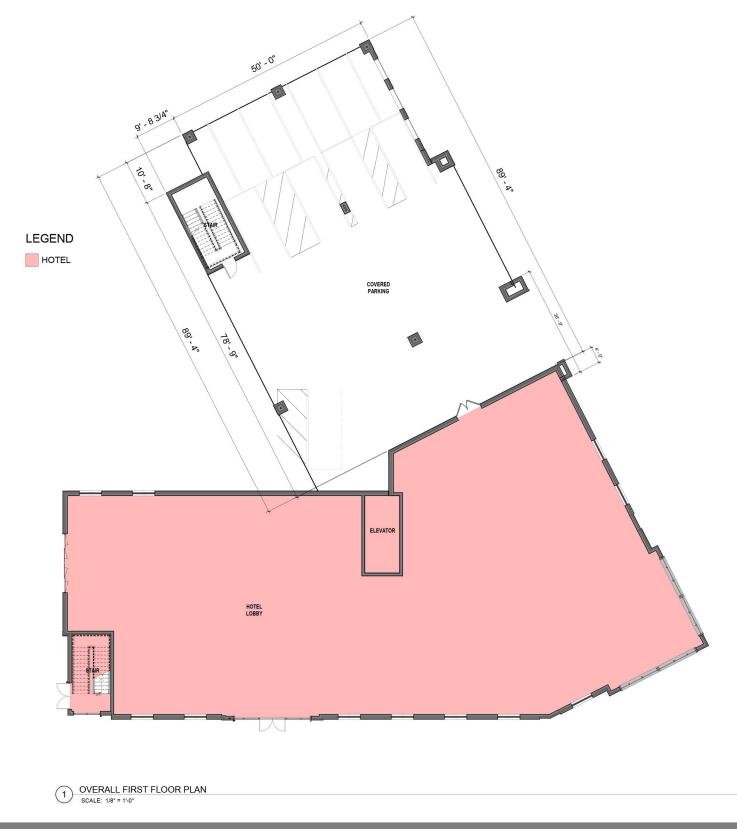



FIRST FLOOR PLAN



Dwg. No. **A1.01**

RAYNES AVE. Project





SECOND FLOOR PLAN





Dwg. No.

A1.02

RAYNES AVE.



THIRD FLOOR PLAN






Dwg. No.

RAYNES AVE.

HOTEL

HISTORIC DISTRICT COMMISSION APPLICATION FOR APPROVAL: JANUARY 4, 2023



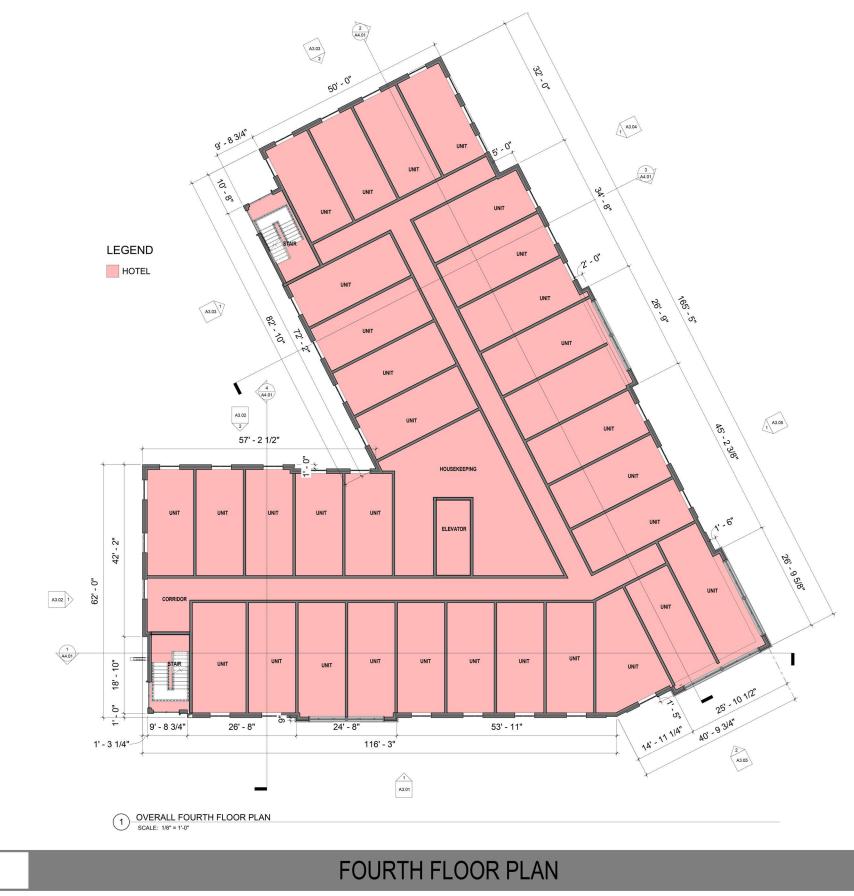



Dwg. No.

RAYNES AVE.



FIFTH FLOOR PLAN




RAYNES AVE. HOTEL



4.4 NOT TO SCALE



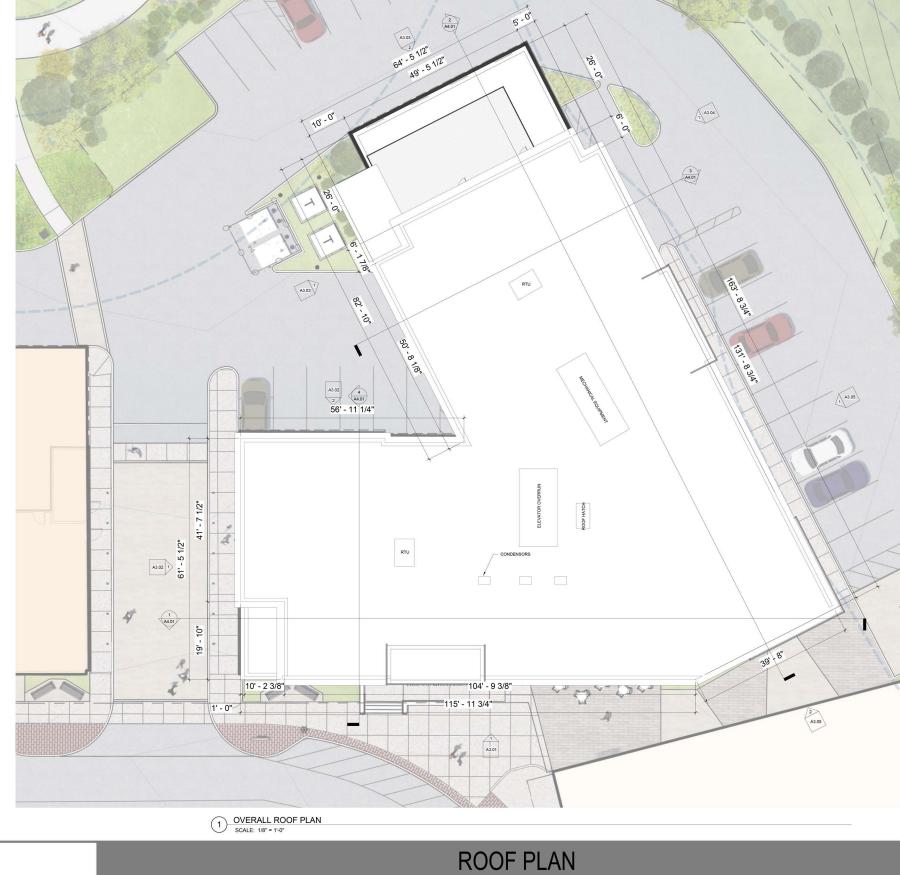





RAYNES AVE.



ELEVATIONS





RAYNES AVE. HOTEL

Project

1


Dwg. No. A3.01



ELEVATIONS





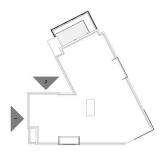

KEYPLAN 1" = 40'-0"

RAYNES AVE. 4.7

Project



Dwg. No.

NOT TO SCALE




ELEVATIONS





RAYNES AVE.



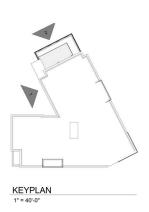

PREFINISHED/ PREFORMED ALUM. PANEL SIDING; COLOR B PREFINISHED/ PREFORMED ALUM. PANEL CORNICE; COLOR C 3 A4.12 PREFINISH BRICK VENEER SOLDIER AND PREFINISHED/ PREFORMED ALUM. PANEL CORNICE; BRICK COLOR "MAIN BRICK" ALUM PANEL COLOR C 2 A4.12 4 A4.12 - PREFINISHED/ PREFORMED ALUM. PANEL SIDING; COLOR B - PREFINISHED/ PREFORMED ALUM. PANEL SIDING; COLOR B PREFINISHED/ PREFORMED
 ALUM. PANEL PROJECTION
 COLOR A FIBERGLASS PICTURE/AWNING WINDOW; COLOR BLACK T.O. ROOF 158' - 6* LEVEL 5 146' - 6* 10' - 6" LEVEL 4 136 - 0* 🕈 10' - 6" 11" 26. LEVEL 3 125' - 6* 🕐 10' - 6" LEVEL 2 115'-0" .0 OPEN TO BEYON 15'-BRICK VENEER: COLOR "ACCENT BRICK" LEVEL 1 100' - 0" • AVG GRADE 98' - 7" • - n _ PRECAST LINTEL BRICK REVEAL PREFINISHED/ PREFORMED CORRUGATED ALUM. PANEL SIDING; ALTERNATING BRICK REVEAL BAND: COLOR "MAIN BRICK" PREFINISHED/ PREFORMED ALUM. PANEL SIDING; COLOR D ALUM. TRIM SILL;
 NORTH EAST ELEVATION A

 SCALE: 1/4" = 1'-0"
 REF SHEET: 1 / A1.02



ELEVATIONS



KEYPLAN 1" = 40'-0"

RAYNES AVE. Project












Dwg. No.

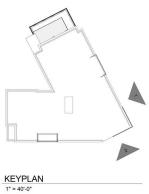




BUILDING SECTIONS

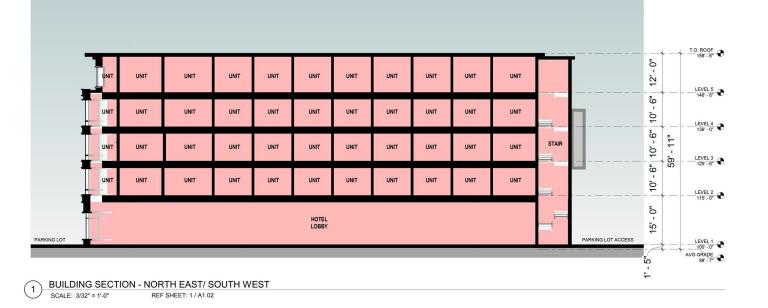

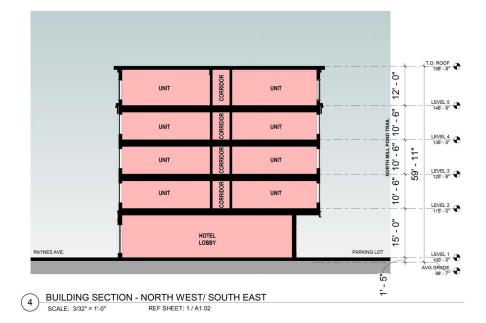

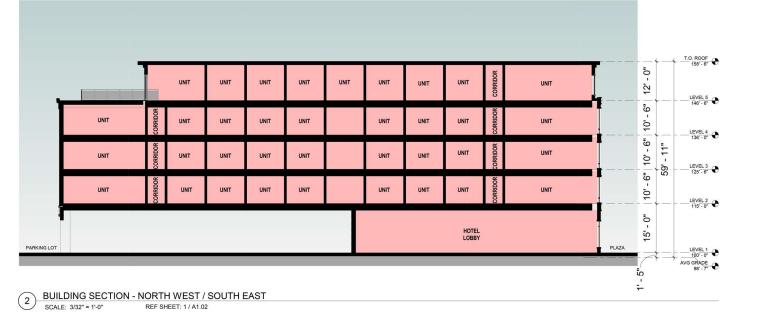






Dwg. No.

RAYNES AVE.


HOTEL

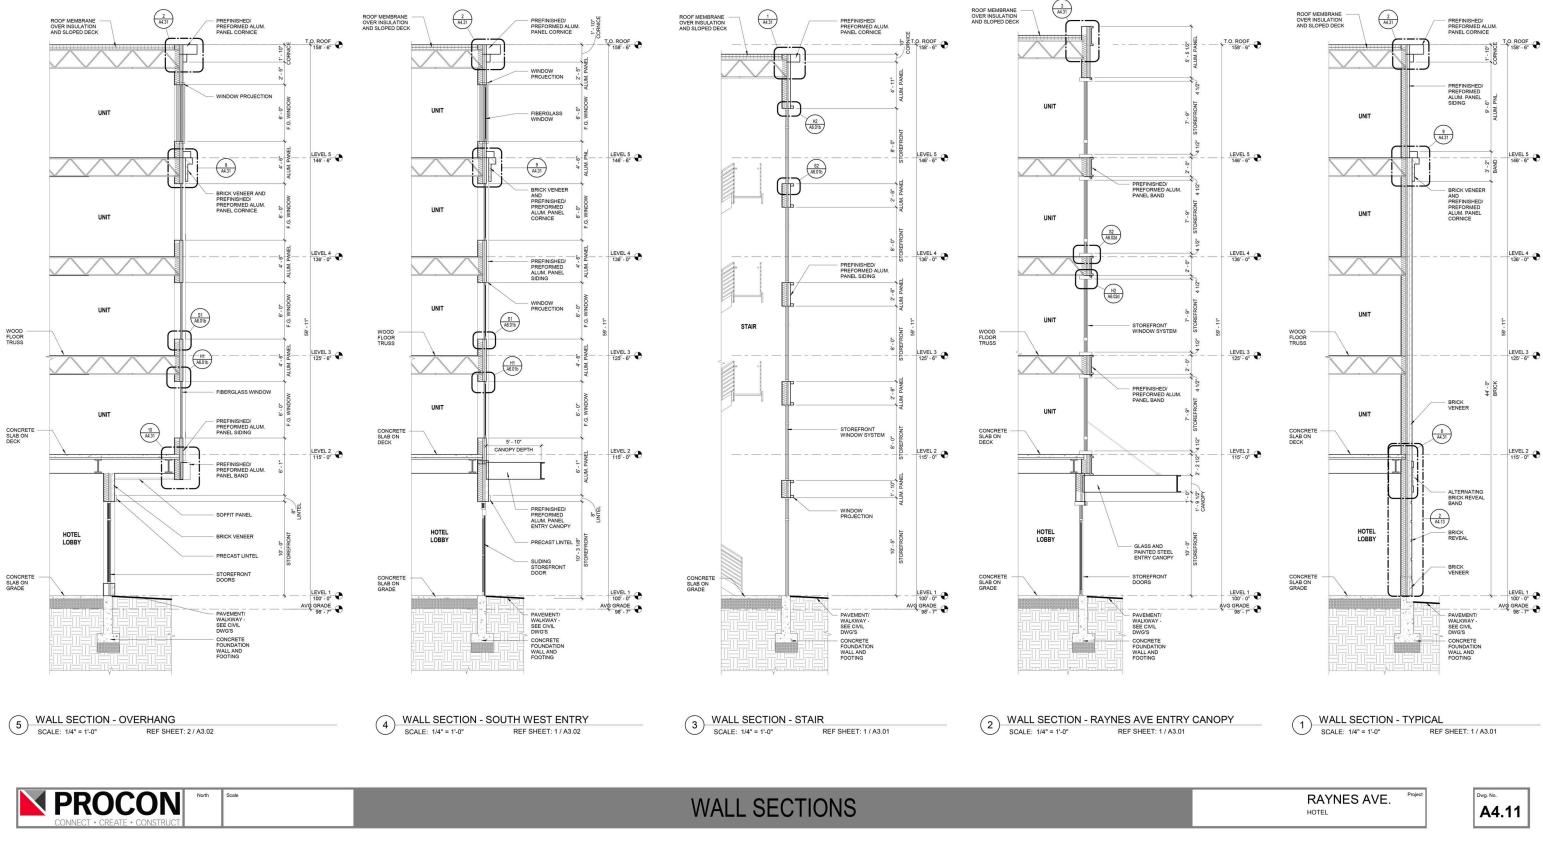



HISTORIC DISTRICT COMMISSION APPLICATION FOR APPROVAL: JANUARY 4, 2023


4.12 NOT TO SCALE

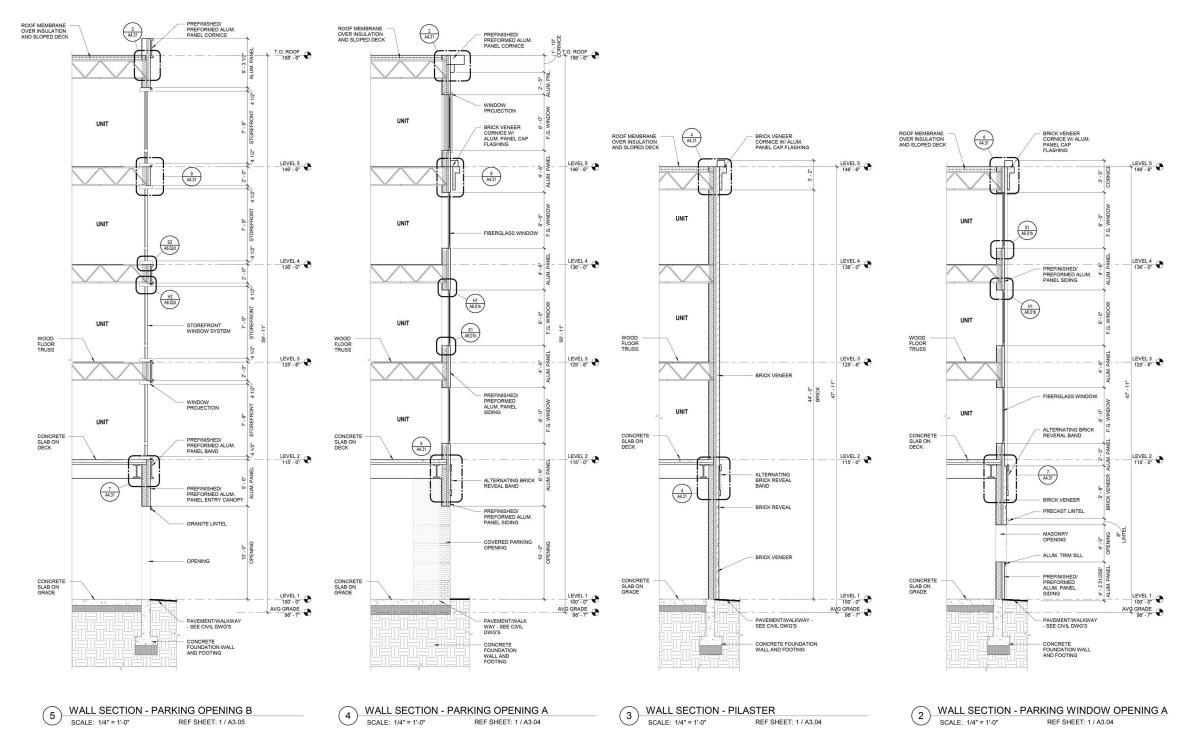




WALL SECTIONS

HISTORIC DISTRICT COMMISSION APPLICATION FOR APPROVAL: JANUARY 4, 2023

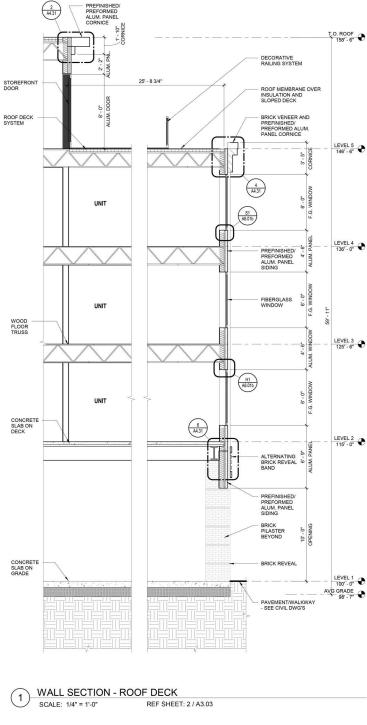

RAYNES AVE. Project HOTEL Dwg. No. A4.12

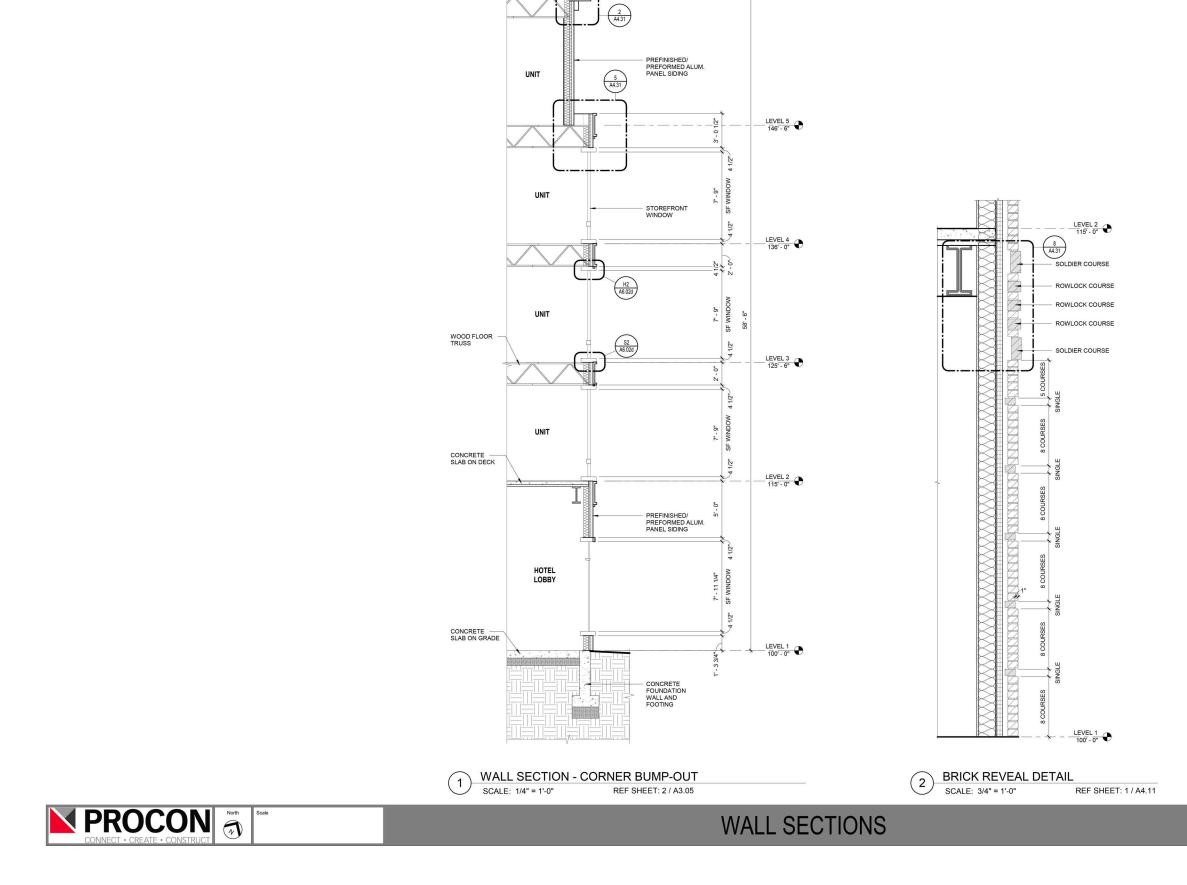

PREFINISHED/ PREFORMED ALUM. PANEL CORNICE

T.O. ROOF


ROOF MEMBRANE OVER INSULATION AND SLOPED DECK

RAYNES AVE. HOTEL





4.14 NOT TO SCALE



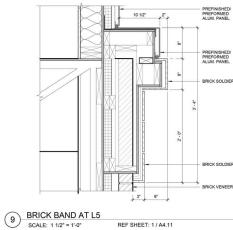

REF SHEET: 1 / A4.11

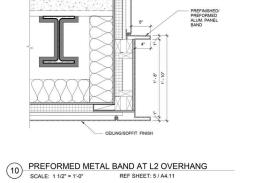

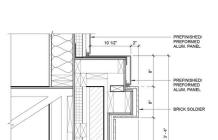

5 PREFORMED METAL CORNICE AT BUMP-OUT SCALE: 1 1/2" = 1'-0" REF SHEET: 1 / A4.13

PREFINISHED/ PREFORMED ALUM. PANEL CORNICE

PREFINISHED/ PREFORMED ALUM. PANEL

PREFINISHED/ PREFORMED ALUM. PANEL

LEVEL 5

PREFINISHED/ PREFORMED ALUM. CORNICE

PREFINISHED/ PREFORMED ALUM. PANEL

ALUM. WINDOW PROJECTION

STOREFRONT WINDOW SYSTEM


1 PREFORMED METAL CORNICE AT STAIR ROOF SCALE: 1 1/2" = 1'-0" REF SHEET: 3 / A4.11

6 BRICK BAND DETAIL AT METAL PANEL/ METAL PANEL SCALE: 1 1/2" = 1'-0" REF SHEET: 1 / A4.12

2 PREFORMED METAL CORNICE AT ROOF SCALE: 11/2" = 1.0"

SCALE: 1 1/2" = 1'-0"

PREFINISHED/ PALUM, FLASHIN VERTICAL BRICK VENEER ALTERNATING ROWLOCK BRICK ALTERNATING ROWLOCK BRICK VERTICAL BRICK VENEER ALTERNATING ROWLOCK BRICK VERTICAL BRICK VENEER SOLDIER COURSI PREFINISHED/ PREFORMED ALUM. PANEL

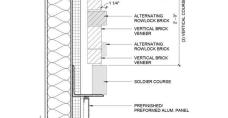


PREFINISHED/ PREFORMED ALUN PANEL CORNICE


1' - 1"

REF SHEET: 1 / A4.11

PREFINISHED/ PREFORMED ALUM, PANEL


PREFINISHED/ PREFORMED ALUM. PANEL

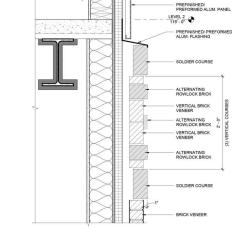


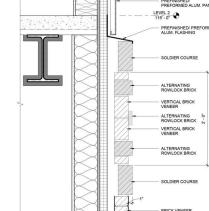

BRICK BAND DETAIL AT METAL PANEL/ BRICK SCALE: 1 1/2" = 1'-0" REF SHEET: 2 / A4.12

 $\overline{7}$

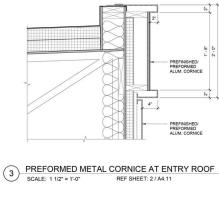


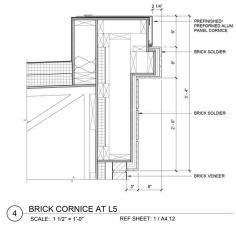

PROPOSED DETAILS

PREFINISHED/ PREFORMED ALUM. PANEL

REF SHEET: 1 / A4.12

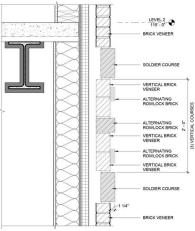

8 BRICK BAND DETAIL AT BRICK/ BRICK SCALE: 1 1/2" = 1'-0" REF SHEET: 1 / A4.11







NOT TO SCALE




FIBERGLASS WINDOW ELEVATIONS

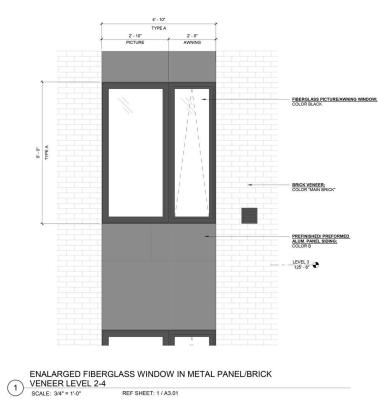


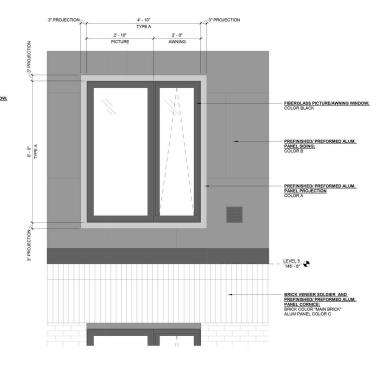


2 ENLARGED FIBERGLASS WINDOW IN METAL PANEL LEVEL 5 SCALE: 3/4" = 1'-0" REF SHEET: 1 / A3.01

ENLARGED FIBERGLASS WINDOW IN METAL PANEL/BRICK

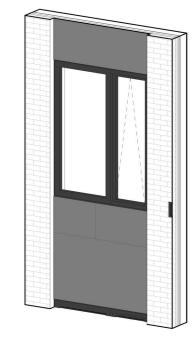

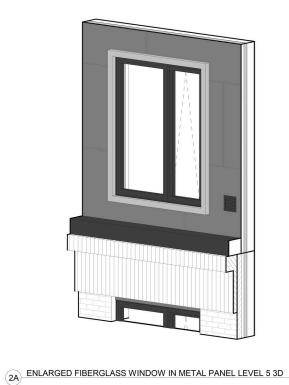

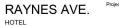




BRICK VENEER


PREFINISHED/ PREFORMED ALUM. PANEL




FIBERGLASS WINDOW DETAILS




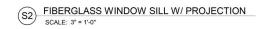

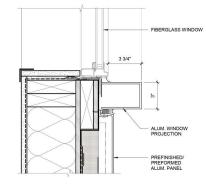



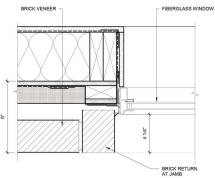


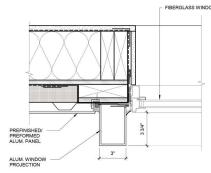


(J2) FIBERGLASS WINDOW JAMB W/ PROJECTION SCALE: 3" = 1".0"


SCALE: 3" = 1'-0"

(H1) FIBERGLASS WINDOW HEAD AT BRICK SCALE: 3" = 1'-0"

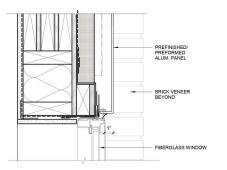

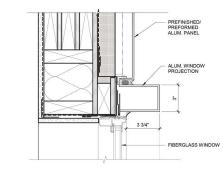

(H2) FIBERGLASS WINDOW HEAD W/ PROJECTION SCALE: 3" = 1'-0"

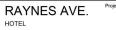









ALUMINUM STOREFRONT ELEVATIONS

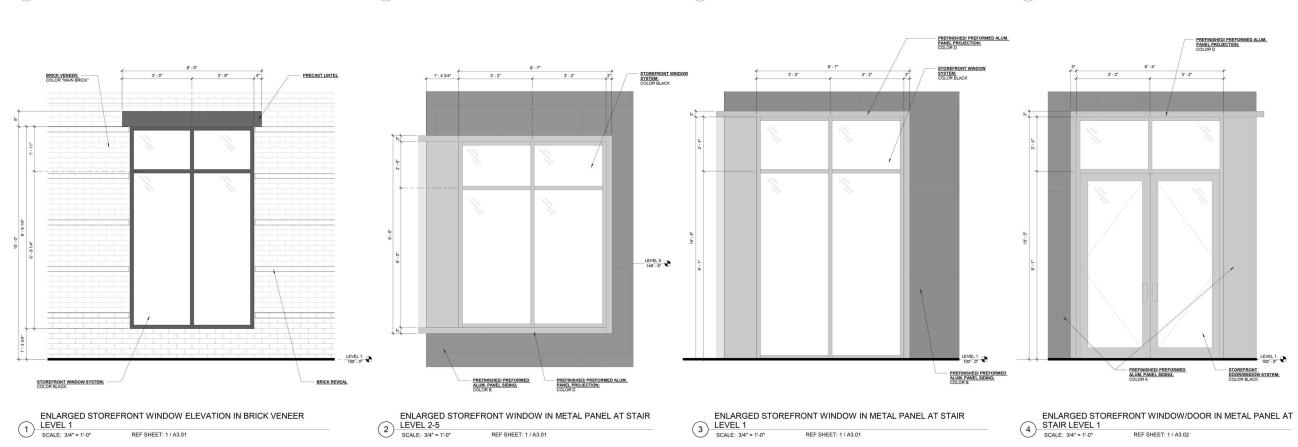





ENLARGED STOREFRONT WINDOW IN METAL PANEL AT STAIR

ENLARGED STOREFRONT WINDOW IN METAL PANEL AT STAIR (3A) LEVEL 1 3D

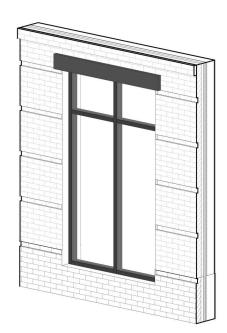

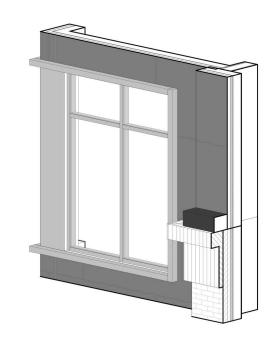

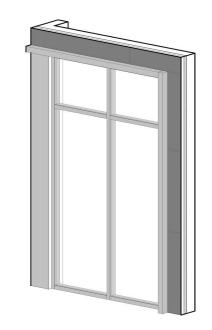





RAYNES AVE.

HOTEL

Projec






HIC

751

SIGNAGE

ALUMINUM STOREFRONT ELEVATIONS

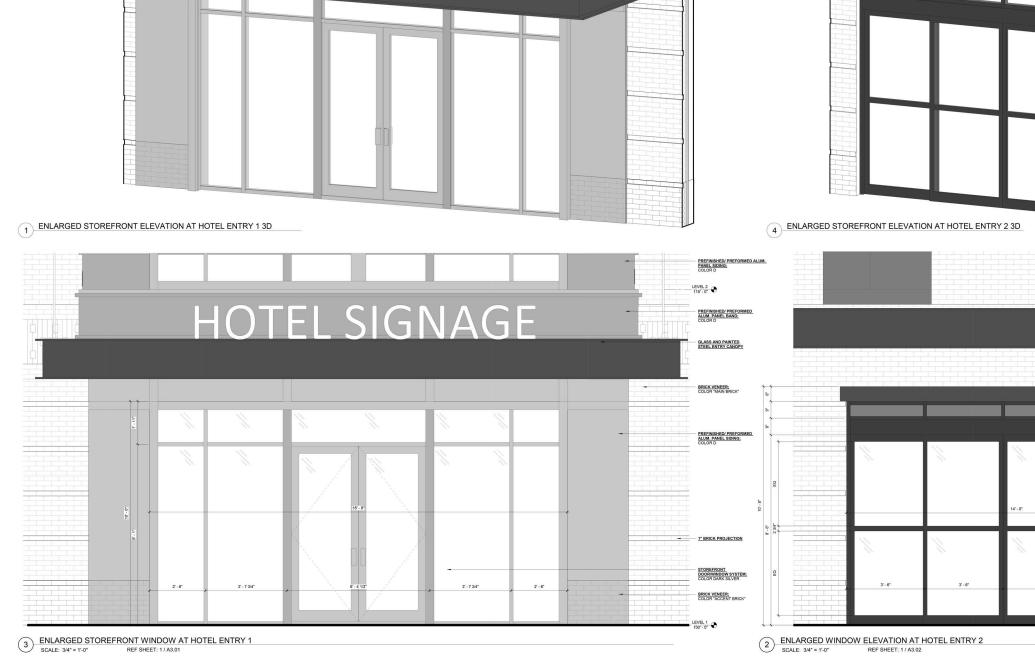





Dwg. No.

A6.02b

RAYNES AVE.

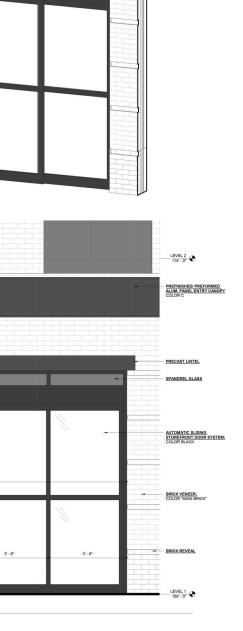

LEVEL 4 136' - 0*

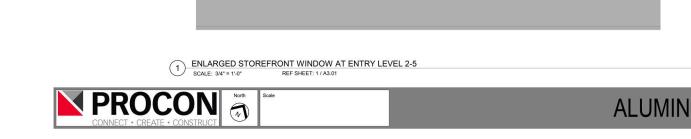


ALUMINUM STOREFRONT ELEVATIONS

 ENLARGED STOREFRONT WINDOW IN METAL PANEL AT FRONT

 (2)
 LEVEL 1-4

 SCALE: 3/4*= 1'.0*
 REF SHEET: 2 / A3.05

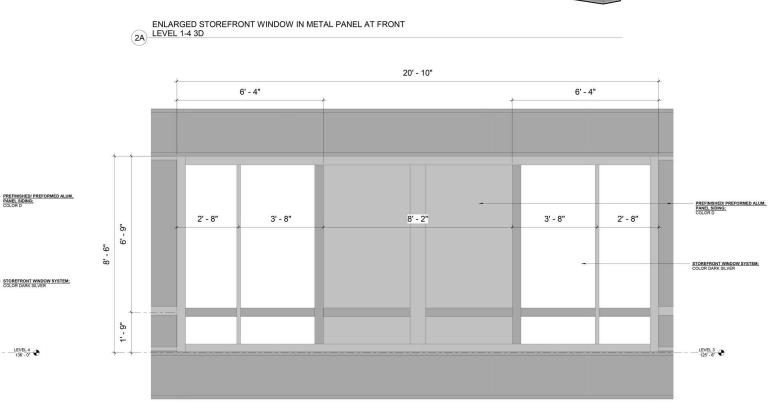

1A ENLARGED STOREFRONT ELEVATION AT ENTRY LEVEL 2-5 3D


3' - 7 3/4"

2' - 6"

6' - 9"

1' - 9" .

8' - 6"

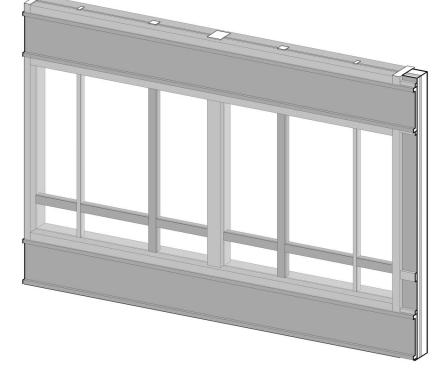


18' - 8"

3' - 2 1/4"

3' - 7 3/4"

2' - 6"


3' - 2 1/4"

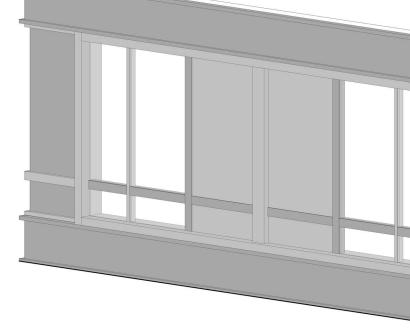



RAYNES AVE. HOTEL




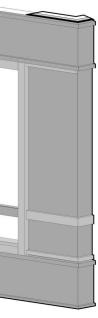




 \leq

ALUMINUM STOREFRONT DETAILS

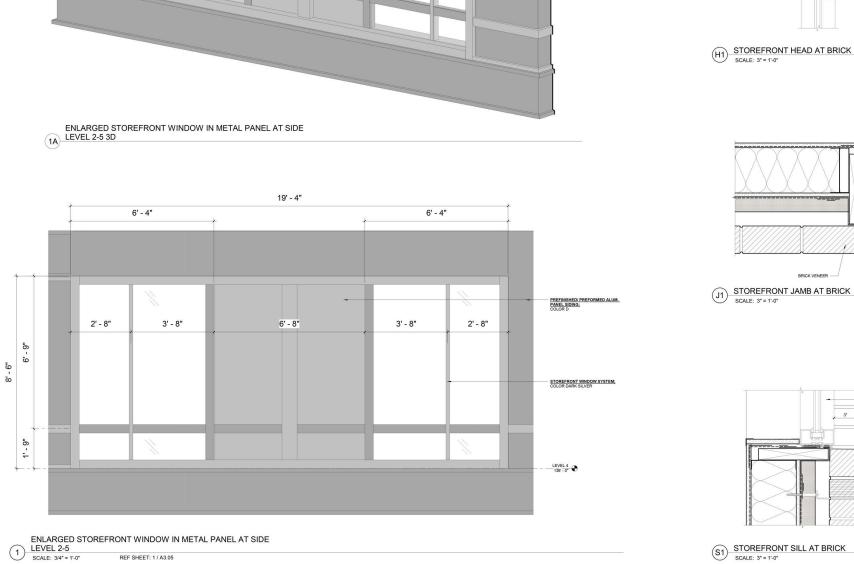

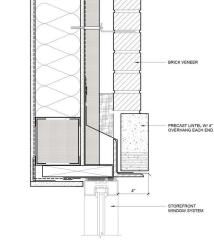

BRICK VENE

3.

STOREFRONT WINDOW SYSTEM

STOREFRONT WINDOW SYSTEM


BRICK ROWLOCK SILL




RAYNES AVE. HOTEL

Dwg. No. A6.02d


S2 STOREFRONT SILL W/ PROJECTION SCALE: 3" = 1'-0"

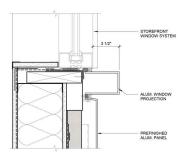




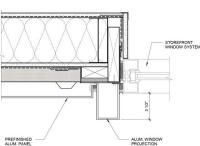


H2 STOREFRONT HEAD W/ PROJECTION SCALE: 3" = 1'-0"

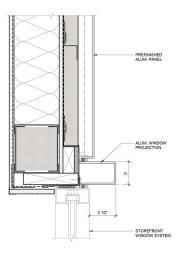

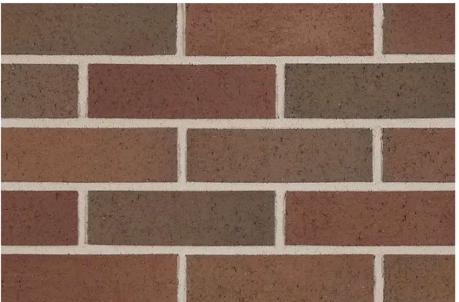

HOTEL MAIN BRICK MANUFACTURER: BELDEN COLOR: CLARET FULL RANGE VELOUR MORTAR: SGS 85X DARK CHOCOLATE SPECIAL INSTRUCTIONS: RUNNING BOND

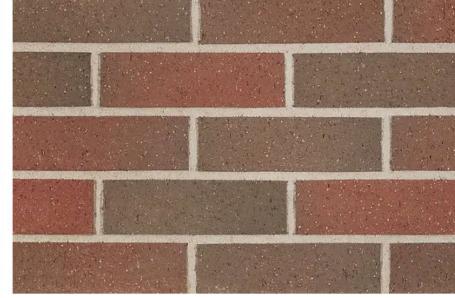

MIXED-USE MAIN BRICK A MANUFACTURER: BELDEN COLOR: ADMIRAL FULL RANGE VELOUR MORTAR: NATURAL PORTLAND CEMENT SPECIAL INSTRUCTIONS: RUNNING BOND

MIXED USE MAIN BRICK B MANUFACTURER: BELDEN COLOR: TUMBLEWEED VELOUR MORTAR: SGS 10X LT BUFF SPECIAL INSTRUCTIONS: RUNNING BOND



ACCENT BRICK MANUFACTURER: ENDICOTT COLOR: MANGANESE IRONSPOT - SMOOTH MORTAR: SGS 94X IRON BLACK SPECIAL INSTRUCTIONS: RUNNING BOND

RAYNES AVENUE

PROPOSED MATERIALS




MIXED-USE ACCENT BRICK

MANUFACTURER: ENDICOTT

PORTSMOUTH, NEW HAMPSHIRE


HISTORIC DISTRICT COMMISSION APPLICATION FOR APPROVAL: JANUARY 4, 2023



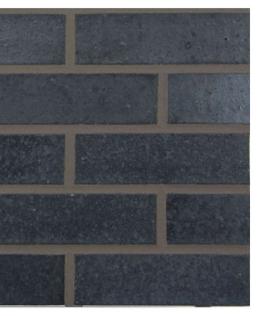

COLOR: MANGANESE IRONSPOT - SMOOTH MORTAR: SGS 94X IRON BLACK SPECIAL INSTRUCTIONS: RUNNING BOND



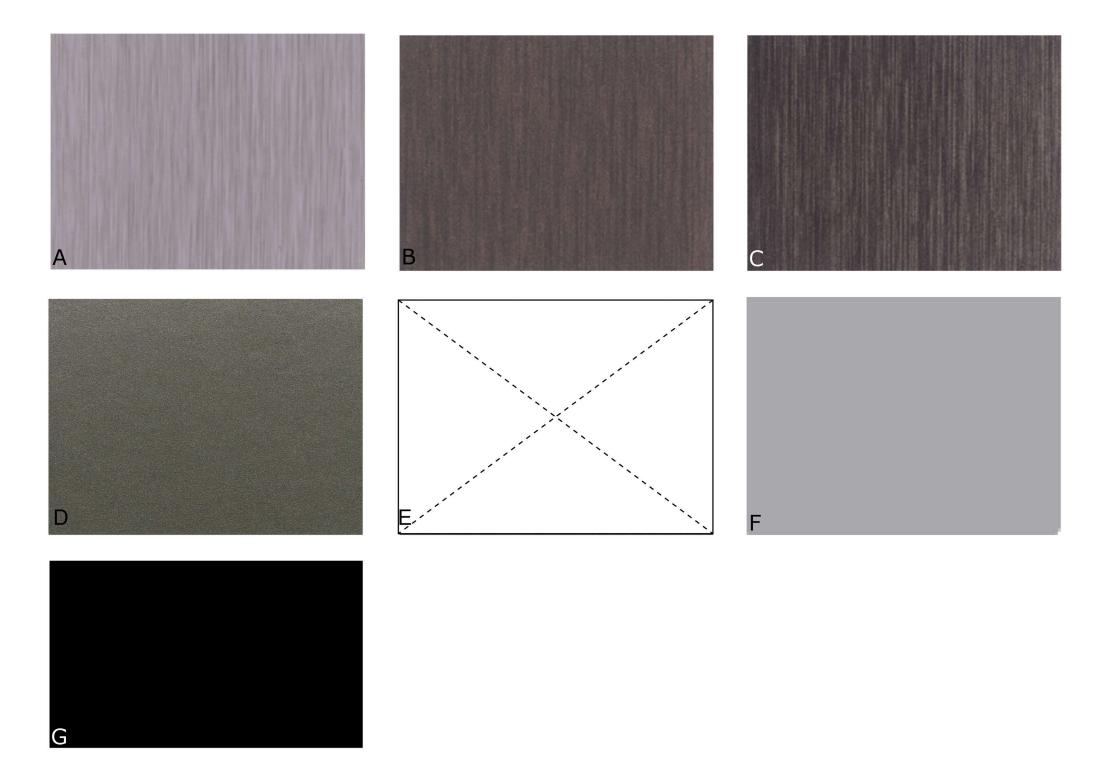

PREFORMED ALUMINUM PANEL MANUFACTURER: VITRABOND COLOR:A = FAUX ZINC LIGHT D = DARK GREY METTALICG = BLACK

B = FAUX ZINC DARK C = FAUX ZINC CHARCOALE= NOT USED

F = CADET GREY

RAYNES AVENUE

PORTSMOUTH, NEW HAMPSHIRE


PROPOSED MATERIALS



HISTORIC DISTRICT COMMISSION APPLICATION FOR APPROVAL: JANUARY 4, 2023





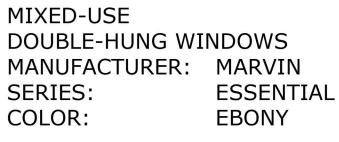

MIXED-USE PATIO DOORS MANUFACTURER: SERIES: COLOR:



RAYNES AVENUE

PORTSMOUTH, NEW HAMPSHIRE

PROPOSED MATERIALS






HISTORIC DISTRICT COMMISSION APPLICATION FOR APPROVAL: JANUARY 4, 2023







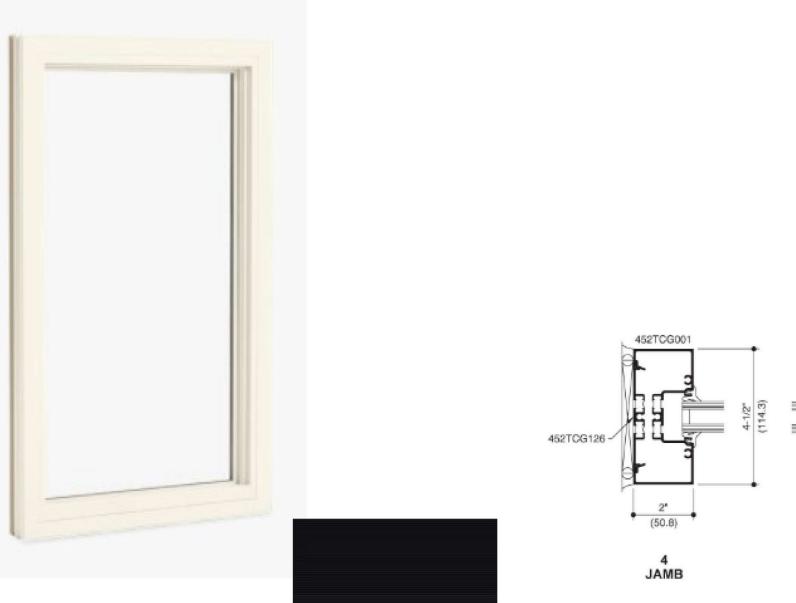

451TCG002 2" (50.8)

452TCG001

5

VERTICAL

3 SILL

ALUMINUM STOREFRONT MANUFACTURER: SERIES: COLOR:

HOTEL FIBERGLASS WINDOW MANUFACTURER: MARVIN - ESSENTIALS SERIES: ESSENTIAL PICTURE & AWNING WINDOWS BLACK COLOR:

RAYNES AVENUE

PORTSMOUTH, NEW HAMPSHIRE

PROPOSED MATERIALS




HISTORIC DISTRICT COMMISSION APPLICATION FOR APPROVAL: JANUARY 4, 2023






5.3


KAWNEER TRIFAB 451 UT BLACK

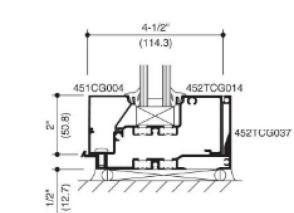

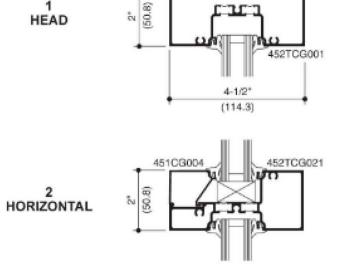

452TCG126



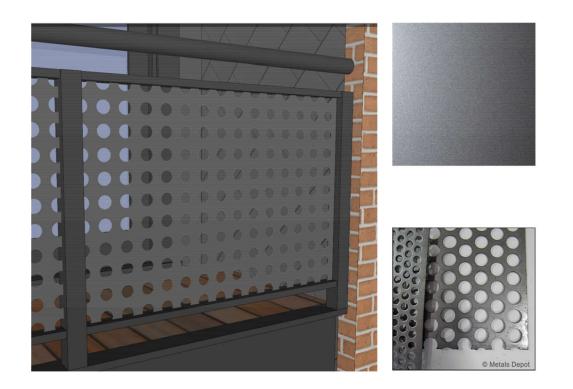

MIXED-USE BALCONY RAILING MANUFACTURER: METALS DEPOT STYLE: 1" HOLE - PS111 COLOR: KYNAR - PEWTER SILVER

CAST STONE MANUFACTURER:

FINISH: COLOR:



COLOR A -MOUNTAIN SAGE LAP SIDING MANUFACTURER: STYLE: FINISH: COLOR:



RAYNES AVENUE


PORTSMOUTH, NEW HAMPSHIRE

PROPOSED MATERIALS

HISTORIC DISTRICT COMMISSION APPLICATION FOR APPROVAL: JANUARY 4, 2023



NORTHERN DESIGN ARCHITECTURAL LIGHT ETCH SLATE

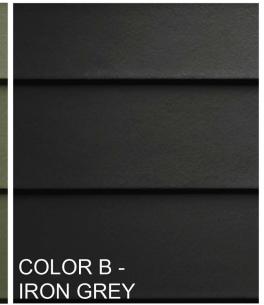

JAMES HARDIE PLANK SIDING - LAP SMOOTH SEE ABOVE







MIXED-USE ENTRY LIGHTMIXED-USE ENTRY LIGHTMIXED-USE ENTRY LIGHTMANUFACTURER:MODERN FORMSMANUFACTURER:MODERN FORMSMANUFACTURER:MODEL:SUSPENSEMODEL:MIDNIGHTMODEL:COLOR:BLACKCOLOR:BLACKCOLOR:

RAYNES AVENUE

PORTSMOUTH, NEW HAMPSHIRE

PROPOSED MATERIALS



HISTORIC DISTRICT COMMISSION APPLICATION FOR APPROVAL: JANUARY 4, 2023



5.5

MIXED-USE ENTRY LIGHT MANUFACTURER: MODERN FORMS MODEL: BLADE COLOR: BLACK



APPENDIX:

- PROJECT DATA

- PUZZLE PARKING SYSTEM

- 30"x42" (DUPLICATE) SCALE DRAWINGS FOR RECORD




PORTSMOUTH, NEW HAMPSHIRE



HISTORIC DISTRICT COMMISSION APPLICATION FOR APPROVAL: JANUARY 4, 2023



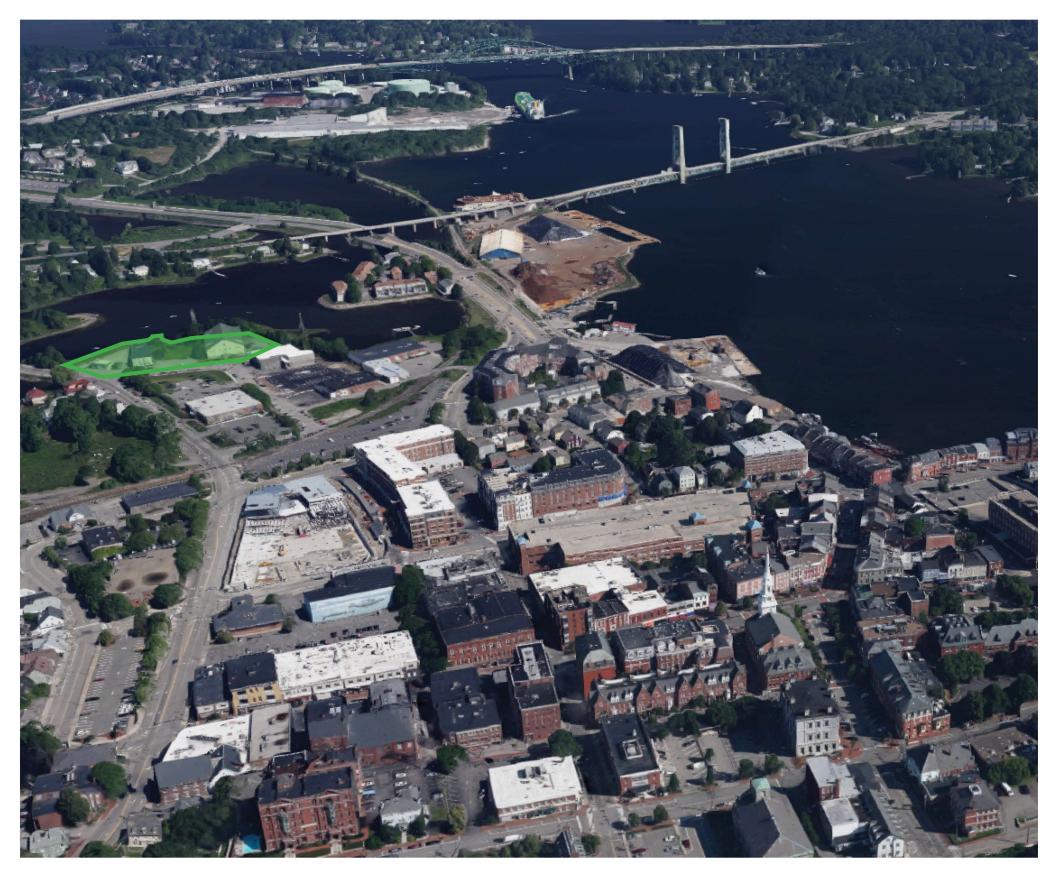

CHARACTER DISTRICT: CD-4 **BUILDING TOTALS: RESIDENTIAL:** 68,000 - 32 UNITS HOTEL: 66,000 - 124 UNITS

PROPOSED USE:

DEVELOPMENT STANDARDS BUILDING PLACEMENT

MAXIMUM PRINCIPA MAXIMUM SECOND SIDE YARD: MINIMUM REAR YAR MINIMUM FRONT LC

(1) - INCREASE ABOVE

BUILDING FORM (PRINCIPAL BUILDING)

BUILDING HEIGHT:

MAXIMUM FINISHE GROUND FLOOR AE MINIMUM GROUND MINIMUM SECOND FACADE GLAZING: SHOP FRON ALLOWED ROOF TY FLAT, GABLE

RAYNES AVENUE PORTSMOUTH, NEW HAMPSHIRE

PROJECT DATA REFERENCE



HISTORIC DISTRICT COMMISSION APPLICATION FOR APPROVAL: JANUARY 4, 2023

RAYNES AVENUE

PLAN PORTSMOUTH 3D MODEL: AREA 7

ZONING DISTRICT: CHARACTER DISTRICT 4 (CD4) DOWNTOWN OVERLAY DISTRICT NORTH END INCENTIVE OVERLAY DISTRICT HISTORIC DISTRICT

MULTI FAMILY DWELLING HOTEL RETAIL/RESTAURANT

PROPOSED LOT SIZE: ±2.53 ACRES (±110,415 SF)

(PRINCIPAL BUILDING):		PROPOSED	PROPOSED
	REQUIRED	BUILDING A	BUILDING B
PAL FRONT YARD:	15 FT	±16 FT ⁽¹⁾	7.4 FT
DARY FRONT YARD:	12 FT	±5 FT	N/A
	NR	NR	NR
RD:	5 FT	N/A	N/A
OT LINE BUILDOUT:	50%	78.4%	78.4%
THE MAXIMUM ALLOWED PE	R 10.5A42.12		

BUILDING AND LOT OCCUPATION:		PROPOSED
	REQUIRED	BUILDING A
MAXIMUM BUILDING BLOCK LENGTH:	200 FT	141 FT
MAXIMUM FACADE MODULATION LENGTH:	80 FT	<80 FT
MAXIMUM ENTRANCE SPACING:	50 FT	<50 FT
MAXIMUM BUILDING COVERAGE:	90%	±47.0%
MAXIMUM BUILDING FOOTPRINT:	30,000 SF ⁽²⁾	17,850 SF
MINIMUM LOT AREA:	NR	
MINIMUM LOT AREA PER DWELLING UNIT:	NR	
MINIMUM OPEN SPACE:	10%	35.4%
MAXIMUM GROUND FLOOR GFA PER USE:	15,000 SF	7,720 SF
(2) - INCREASE ABOVE 15,000 SF ALLOWED PER 10	.5A46.10	
BUILDING FORM (PRINCIPAL BUILDING):		PROPOSED

CITAL DOILDING.		I KOI OSED	TROF OSED
	REQUIRED	BUILDING A	BUILDING B
1	5 STORY ⁽³⁾	5 STORY	5 STORY
	60 FT	59.77 FT	57.90 FT
ED FLOOR SURFACE OF			
BOVE SIDEWALK GRADE:	36 IN	<36"	<36"
D STORY HEIGHT:	12 FT	15 FT	15 FT
STORY HEIGHT:	10 FT	10.5 FT	10.5 FT
NT FACADE TYPE	70%	70%	70%
YPES			
E, HIP, GAMBREL, MANSARD	FLAT, GABLE, HIP,	FLAT	
	GAMBREL, MANSARD		





6.1

PROPOSED BUILDING B

116 FT

<80 FT

<50 FT $\pm 47.0\%$ 14,622 SF


8,911 SF


PROPOSED







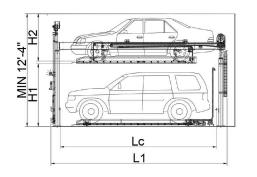

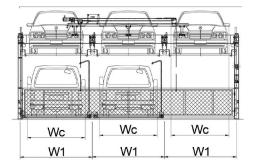


(B) Elevation Section View

Figure 6. 2-Level Puzzle (Typical)

Table 1. Typical 2-level Puzzle DimensionsEquipment Dimension and Car Size

Equipment Length (L1)	Equipment Width (W1)
20'-0"	8' - 6"
Car Length (Lc)	Car Width (Wc)
17' - 0"	6'- 10"

TWO-LEVEL PUZZLE (+2)

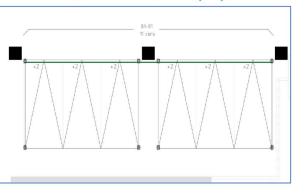

(A) Design Plan View



RAYNES AVENUE

PORTSMOUTH, NEW HAMPSHIRE

CIYTLIFT - PUZZLE PARKING SYSTEM REFERENCE



HISTORIC DISTRICT COMMISSION APPLICATION FOR APPROVAL: JANUARY 4, 2023







