MECHANIC STREET SEAWALL REPLACEMENT


AT PICKERING STREET



DEPARTMENT OF PUBLIC WORKS CITY OF PORTSMOUTH, NH

WINTER 2013

PREPARED BY
VINE ASSOCIATES, A DIVISION OF GZA GEOENVIRONMENTAL, INC.
372 MERRIMAC STREET
NEWBURYPORT, MA

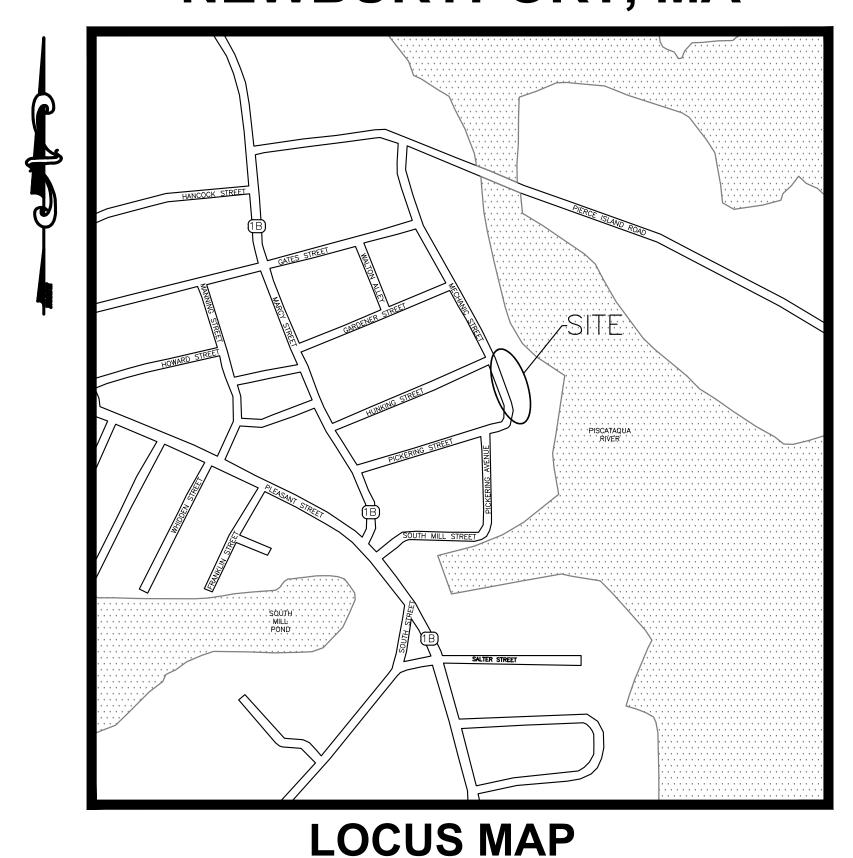

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(2-BAR ALUMINUM)



AMERICAN FLAGGING: 890-1154
GAS EMERGENCY: 866-900-4115
EMERGENCY: 911

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GENERAL NOTES:

- 1. THE SCOPE OF WORK INCLUDES ALL LABOR, TOOLS, EQUIPMENT, ACCESSORIES, AND MATERIALS TO FURNISH AND INSTALL THE SEAWALL REPLACEMENT. THE SEAWALL REPLACEMENT INCLUDES. BUT IS NOT LIMITED TO:
- A. PREPARE AND SUBMIT TO NEW HAMPSHIRE DEPARTMENT OF ENVIRONMENTAL SERVICES AN EROSION CONTROL/WATER QUALITY PROTECTION PLAN FOR APPROVAL PRIOR TO COMMENCING WORK.
- B. REMOVE EXISTING SEAWALL TO THE BOTTOM OF REPAIR ELEVATION INCLUDING TEMPORARY REMOVAL OF PAVEMENT AND ROADWAY FILL MATERIAL, AS NEEDED TO COMPLETE THE REPAIR WORK. USE OF EXPLOSIVES IS NOT PERMITTED.
- C. SALVAGE SUITABLE GRANITE BLOCK STONES FOR REUSE AS GRANITE FACING FOR THE REPLACEMENT SEAWALL. MISCELLANEOUS ITEMS FROM THE SEAWALL THAT ARE NOT SUITABLE FOR REUSE, SUCH AS GRANITE CURB AND BRICK, SHALL BE COME THE PROPERTY OF THE CONTRACTOR. ANY EXCESS GRANITE BLOCK SUITABLE FOR REUSE SHALL BECOME THE PROPERTY OF THE CITY AND THE CONTRACTOR SHALL LOAD, TRANSPORT, AND UNLOAD THE GRANITE BLOCK AT A SITE COORDINATED WITH THE CITY.
- D. HARBOR BOTTOM MATERIAL REMOVED SHALL BECOME THE PROPERTY OF THE CONTRACTOR AND SHALL BE DISPOSED OF IN ACCORDANCE WITH APPLICABLE FEDERAL. STATE AND LOCAL REGULATIONS.
- E. CONSTRUCT REINFORCED CONCRETE SEAWALL, AS
- F. CONSTRUCT STONE BLOCK FACING UTILIZING SALVAGED STONE BLOCKS FROM THE SITE. AS SHOWN.
- G. PROVIDE SUPPLEMENTAL GRANITE BLOCK AS NEEDED, SEE SPECIFICATIONS.
- H. UPON COMPLETION OF THE SEAWALL, REGRADE THE MUDLINE ALONG THE FACE OF THE SEAWALL TO MATCH APPROXIMATE EXISTING GRADE.
- I. CONSTRUCT DRAINAGE SYSTEM, AS SHOWN.

 J. REMOVE PAVEMENT, FULL—WIDTH, OF MECHANIC STREET AND REPLACE WITH BITUMINOUS BASE COURSE ONLY. THIS WORK SHALL BE COORDINATED WITH THE CITY AND THE SOUTH END SIDEWALK & ROAD REPLACEMENT PROJECT. THE FINAL WEARING COURSE WILL BE COMPLETED BY OTHERS.
- K. SUBMIT A RECORD DRAWING OF AS—BUILT CONDITIONS UPON COMPLETION OF THE WORK.
- 2. UTILITIES AND GENERAL SITE INFORMATION SHOWN ARE APPROXIMATE AND BASED ON LINEWORK FROM CITY OF PORTSMOUTH PUBLIC WORKS DEPARTMENT. VERIFICATION OF ACTUAL UTILITY LOCATIONS IS THE RESPONSIBILITY OF THE CONTRACTOR.
- 3. A LIMITED TOPOGRAPHIC SURVEY OF THE SEAWALL AND IMMEDIATELY ADJACENT FEATURES WAS PERFORMED BY VINE ASSOCIATES, A DIVISION OF GZA GEOENVIRONMENTAL, ON JULY 21, 2011.

- 4. ELEVATIONS SHOWN ARE IN FEET AND REFERENCE THE MEAN LOWER LOW WATER DATUM (MLLW). SEE TIDAL DATUMS TABLE.
- 5. DIMENSIONS, ELEVATIONS AND CONDITIONS RELATING TO THE WORK SHALL BE VERIFIED BY THE CONTRACTOR PRIOR TO ORDERING MATERIAL OR COMMENCING WORK. THE CONTRACTOR SHALL ADVISE THE OWNER OF ANY DISCREPANCIES FROM THE WORK SHOWN ON THE DRAWINGS.
- 6. THE CONTRACTOR SHALL MAINTAIN ADEQUATE SURVEY CONTROL, AT ALL TIMES, TO ESTABLISH AND MAINTAIN ALL LINES AND ELEVATIONS.
- 7. THE CONTRACTOR SHALL BE RESPONSIBLE FOR ANY DAMAGE DONE TO STRUCTURES, UTILITIES AND VESSELS OR INJURIES TO THE PUBLIC RESULTING FROM THE CONTRACTOR'S WORK OR WORK OF THE CONTRACTOR'S SUBCONTRACTORS. THE CONTRACTOR SHALL FURNISH, INSTALL, AND MAINTAIN TEMPORARY CONSTRUCTION FENCES AND BARRIERS AROUND THE CONTRACTOR WORK AREA. DEBRIS AND OIL ABSORBENT BOOMS SHALL BE PLACED SEAWARD OF THE LIMIT OF WORK.
- 8. ACCESS TO THE PRIVATELY OWNED STRUCTURES AT EITHER END OF THE SEAWALL REPLACEMENT WORK SHALL BE MAINTAINED THROUGHOUT CONSTRUCTION.
 TEMPORARY, SHORT—TERM, PERIODS OF NO OR LIMITED ACCESS MAY BE PERMITTED WITH ADVANCED NOTIFICATION AND COORDINATION WITH THE CITY AND THE PROPERTY OWNER.
- 9. THE PORTION OF MECHANIC STREET AFFECTED BY THE SEAWALL REPLACEMENT MAY BE CLOSED FOR THE DURATION OF THE CONSTRUCTION WORK. THIS AREA MAY ALSO BE USED AS CONTRACTOR LAYDOWN AREA. THE CONTRACTOR SHALL EXERCISE CAUTION TO NOT DAMAGE ADJACENT PRIVATE PROPERTY. THE CONTRACTOR SHALL BE RESPONSIBLE FOR ANY DAMAGE RESULTING FROM THE CONTRACTOR'S WORK OR WORK OF THE CONTRACTOR'S SUBCONTRACTORS. THE CONTRACTOR SHALL EXERCISE CAUTION TO NOT DAMAGE ADJACENT PRIVATE PROPERTY. THE CONTRACTOR SHALL BE RESPONSIBLE FOR ANY DAMAGE RESULTING FROM THE CONTRACTOR'S WORK OR WORK OF THE CONTRACTOR'S SUBCONTRACTORS.
- 10. THE CONTRACTOR SHALL PERFORM WORK AS PER THE WETLANDS AND SITE SPECIFIC PERMIT 2012-00751 ISSUED BY THE NEW HAMPSHIRE DEPARTMENT OF ENVIRONMENTAL SERVICES (NHDES). ANY CHANGES FROM THE PERMIT AND/OR THESE CONSTRUCTION PLANS SHALL BE APPROVED BY THE ENGINEER AND NHDES.

- 11. IT IS THE CONTRACTOR'S RESPONSIBILITY TO DETERMINE REMOVAL AND ERECTION PROCEDURES AND SEQUENCE TO ENSURE THE SAFETY OF THE FACILITIES. THE CONTRACTOR IS RESPONSIBLE TO ERECT, MAINTAIN AND REMOVE TEMPORARY ERECTION MATERIALS AND EQUIPMENT. ALL PROPOSED STAGING AREAS SHALL BE COORDINATED WITH THE CITY BEFORE STARTING THE WORK.
- 12. THE CONTRACTOR SHALL PROVIDE AND MAINTAIN ENVIRONMENTAL CONTROLS AS REQUIRED BY FEDERAL, STATE AND MUNICIPAL REGULATIONS AND PERMITS. ENVIRONMENTAL CONTROLS SHALL INCLUDE, BUT NOT BE LIMITED TO, SILTATION/EROSION CONTROL, TURBIDITY AND DUST.
- 13. THE CONTRACTOR SHALL FOLLOW ALL APPLICABLE FEDERAL, STATE AND MUNICIPAL REGULATIONS, INCLUDING THE FEDERAL DEPARTMENT OF LABOR, SAFETY, HEALTH ACT, U.S. ARMY CORPS OF ENGINEERS, STATE/LOCAL WETLANDS CONTROL, AND PERMITS.
- 14. STORAGE, FUELING AND LUBRICATION OF EQUIPMENT AND MOTOR VEHICLES SHALL BE CONDUCTED IN A MANNER THAT AFFORDS THE MAXIMUM PROTECTION AGAINST SPILL AND EVAPORATION. FUEL, LUBRICANTS AND OIL SHALL BE MANAGED AND STORED IN ACCORDANCE WITH ALL FEDERAL, STATE, REGIONAL, AND LOCAL LAWS AND REGULATIONS. THERE SHALL BE NO STORAGE OF FUEL ON THE PROJECT SITE. FUEL MUST BE BROUGHT TO THE PROJECT SITE AS NEEDED. EQUIPMENT OPERATION, ACTIVITIES, OR PROCESSES PERFORMED BY THE CONTRACTOR SHALL BE IN ACCORDANCE WITH ALL FEDERAL AND STATE AIR EMISSION AND PERFORMANCE LAWS AND STANDARDS.
- 15. THE CONTRACTOR SHALL PROVIDE CONTROL MEASURES AS REQUIRED BY ENVIRONMENTAL REGULATIONS AND AS REQUIRED TO PREVENT DEBRIS FROM ENTERING THE RIVER.
- 16. TEMPORARY COFFERDAM SHALL NOT BE INSTALLED DURING PERIODS OF HIGH TIDE.
- 17. UNCONFINED WORK, WITHIN THE RIVER, SHALL BE DONE AT PERIODS OF LOW TIDE.

MATERIAL NOTES:

GROUT

1. MATERIAL AND PRODUCT REQUIREMENTS, WHERE REFERENCED AS NHDOT, THE REQUIREMENT REFERS TO THE STATE OF NEW HAMPSHIRE DEPARTMENT OF TRANSPORTATION STANDARD SPECIFICATIONS FOR ROAD AND BRIDGE CONSTRUCTION — 2010 EDITION.

GRAVEL FILL NHDOT 209, GRANULAR BACKFILL

CRUSHED STONE NHDOT 304.4, CRUSHED STONE (FINE)

CONCRETE 28-DAY COMPRESSIVE STRENGTH OF 5,000 PSI NHDOT 520, CLASS AAA

(OVERLAY)
MAXIMUM 0.400 W/C RATIO
CORROSION INHIBITOR

GEOTEXTILE NHDOT 593

APPLICATION 1 —
SUBSURFACE DRAINAGE FOR

DRAINAGE WORK
APPLICATION 2 —
STABILIZATION FOR WALL BASE
FOUNDATION

REINFORCING STEEL ASTM A615, GRADE 60 EPOXY COATED, ASTM A775

DOWELS STAINLESS STEEL, TYPE 316

NON-SHRINK, NON-METALLIC, CEMENT-BASED GROUT APPROPRIATE FOR SALTWATER/MARINE

SALTWATER/MARINE
ENVIRONMENT AND
SUBMERSION
MINIMUM 28-DAY
COMPRESSIVE STRENGTH OF
7,000 PSI

TIDAL DATUMS (1983–2001 TIDAL EPOCH)

= 12.76 $^{\prime}$ ESTIMATED 100-YEAR FLOOD ELEVATION (STILLWATER) = 12.34 HIGHEST OBSERVED WATER LEVEL (2/19/1972) MEAN HIGHER HIGH WATER (MHHW) = 8.84' MEAN HIGH WATER (MHW) = 8.43' NORTH AMERICAN VERTICAL DATUM-1988 (NAVD88) = 4.62' = 4.37'MEAN TIDE LEVEL (MTL) 3.86' NATIONAL GEODETIC VERTICAL DATUM-1929 (NGVD29) = MEAN LOW WATER (MLW) 0.32 MEAN LOWER LOW WATER (MLLW) = 0.00'

SEAVEY ISLAND, PORTSMOUTH HARBOR NOAA STA ID #8419870

REFERENCE (TIDAL DATUM):



MECHANIC STREET SEAWALL (LOOKING TOWARDS SOUTH)



MECHANIC STREET SEAWALL
AERIAL IMAGE

REFERENCE:
AERIAL IMAGE FROM GOOGLE EARTH PROFESSIONAL DATED 2005.
LINEWORK FROM CITY OF PORTSMOUTH DEPARTMENT OF PUBLIC WORKS.



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NHDES FILE #2012-00751 CITY OF PORTSMOUTH, MECHANIC & PICKERING STREET

MECHANIC STREET SEAWALL NOTES

REPARED BY:

SEPARED BY:

GZA GeoEnvironmental, I
Engineers and Scientists


CITY OF PORTSMOUTH, NH

PROJ MGR: CWC REVIEWED BY: RJM CHECKED BY: JJZ DRAWING

DESIGNED BY: CWC DRAWN BY: JJZ SCALE: AS SHOWN

DATE: PROJECT NO. REVISION NO.


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GZA GeoEnvironmental, Inc. Engineers and Scientists						Inc.	City of Portsmouth Mechanic St Seawall Rehab Portsmouth, New Hamps							of 1	70.00	
Drilling Co.: New Hampshire Boring Foreman: Greg Leavitt Logged By: Jason Clegg Type of Rig: Rig Model: Drilling Met							del:	Truck nod: Rotary Wash	Boring Location: See Plan Ground Surface Elev. (ft.): Final Boring Depth (ft.): 15 Date Start - Finish: 7/14/2011 - 7/14/2			H. Datum: V. Datum:				
Auger/Casing Type: HW Sampler Type: Split Spoon Groundw											vater Depth (ft.)					
I.D/O.D.(in): 4"/4.5" Hammer Weight (lb.): _{300 lb}							D.D. (iı oler Hı	n.): 1-3/8"/2" mr Wt (lb) : 140	Date 7/14/17					/ater [4'	epth	Stab. Time 12 mins
Hammer Fall (in.): 24"				Samp	oler Hi	mr Fall (in): 30		771-171	1 0000					12 111113		
	Casing		;	Samp	ole	Othe	r:	Safety Hamm					<u>루</u>	Field		Stratum 之
epth (ft)	Blows/ Core Rate	No.			Rec.	Blows (per 6 in.)	SPT Value	(Modif	Description an fied Burmister			l	Remark	Test		Description $\frac{\delta}{\Box}$
	Nate		(***)	()	()	(per e ma)		ASPHALT					1		0.5'	ASPHALT
-		S-1	1-3	24	8	11 8 5 5	13	S-1: Medium dense, I trace Gravel, trace Gl		coarse SAI	ND,	some Silt,				
_		S-2	3-5	24	0	9 9 8 6	17	brown, fine to coarse	2: No recovery in spoon (see note 2). Medium dense, own, fine to coarse SAND, some Silt, little Gravel, trace							FILL
5 _		S-3	5-7	24	15	8 11 9 7	20	Asphalt. S-3: Top 6": Brown, fi Gravel, trace Brick.	op 6": Brown, fine to coarse SAND, some Silt, trace						6.8'	
- -		S-4	7-8.8	21	12	17 32 30 30/3"	62	Mid 5": Dark gray, fine Gravel, trace Brick.							8.8'	SILTY SAND
- 10 _		C-1	10-15	60	57	min/ft 4	R	Bottom 4": Olive, fine Gravel. S-4: Very dense, olive					3		0.0	
-		0 1				3 4		Gravel. C-1: Hard, slightly we METAPELITE, with c		•	•				MET	TAPELITE BEDROCK
-						6		(85°-90°) iron oxide/c	. ,	•		, to vertical	5			
15						6							6		15'	
- - 20 _ - - - 25 _ -								Bottom of boring at 15								
30									,							
EMARKS	 Drow Split Rolle Core minu 	e HW o spoon rbit into d bedro tes per	casing to bouncing o potentia ock from a foot. RC	5 feet on ob al bedr approx D = "	and re estructi ock fro ximatel Rock 0	strieved it to o on at 8.8 fee om 8.8 to 10 ly 10 to 15 fe Quality Desig	obtain s t. feet. O et usin nation"	bserved dark gray, fine-g g NX sized core barrel. I	Data in column	named "Blo	ws/	6"" represents	core	barrel p		
bedro	ck types	Actual	transitions	s may	be gra	dual. Water le	evel rea	on procedures. Stratification dings have been made at t times the measurements we	he times and un							ring No.: GZ-1

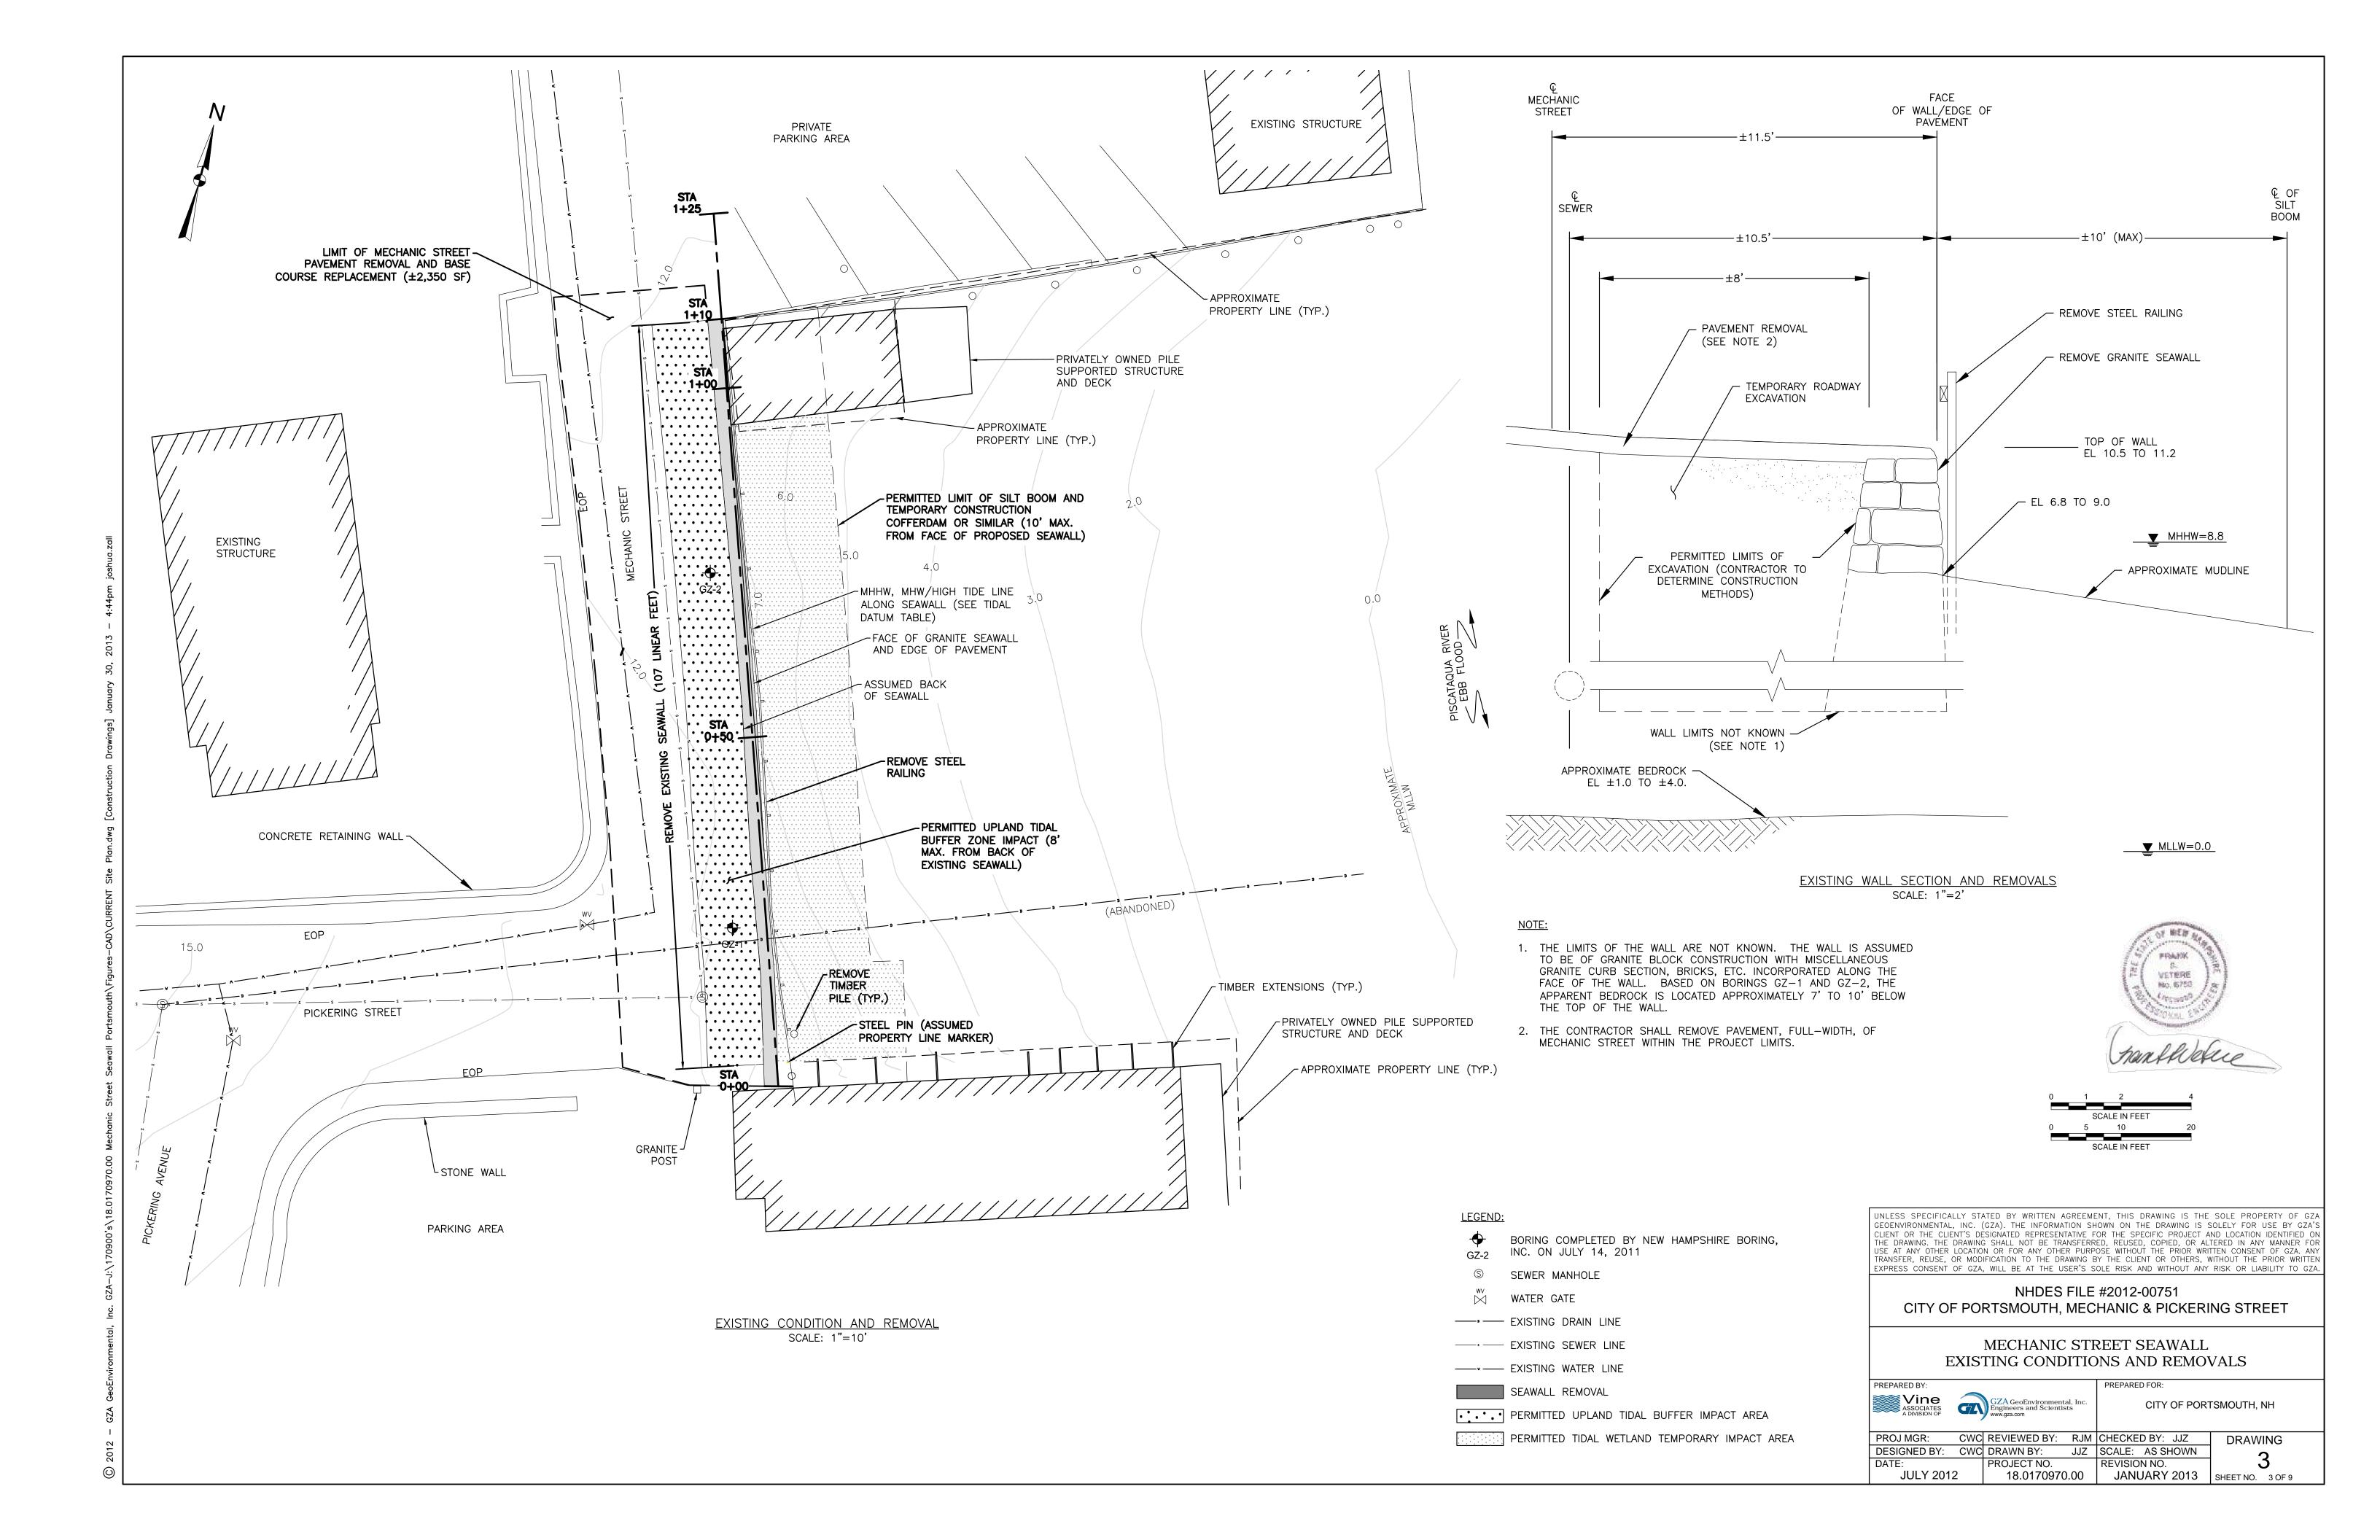GEOTECHNICAL BORING LOG



GEOTECHNICAL BORING LOG

PRANK
VETERE
Ho. 6750
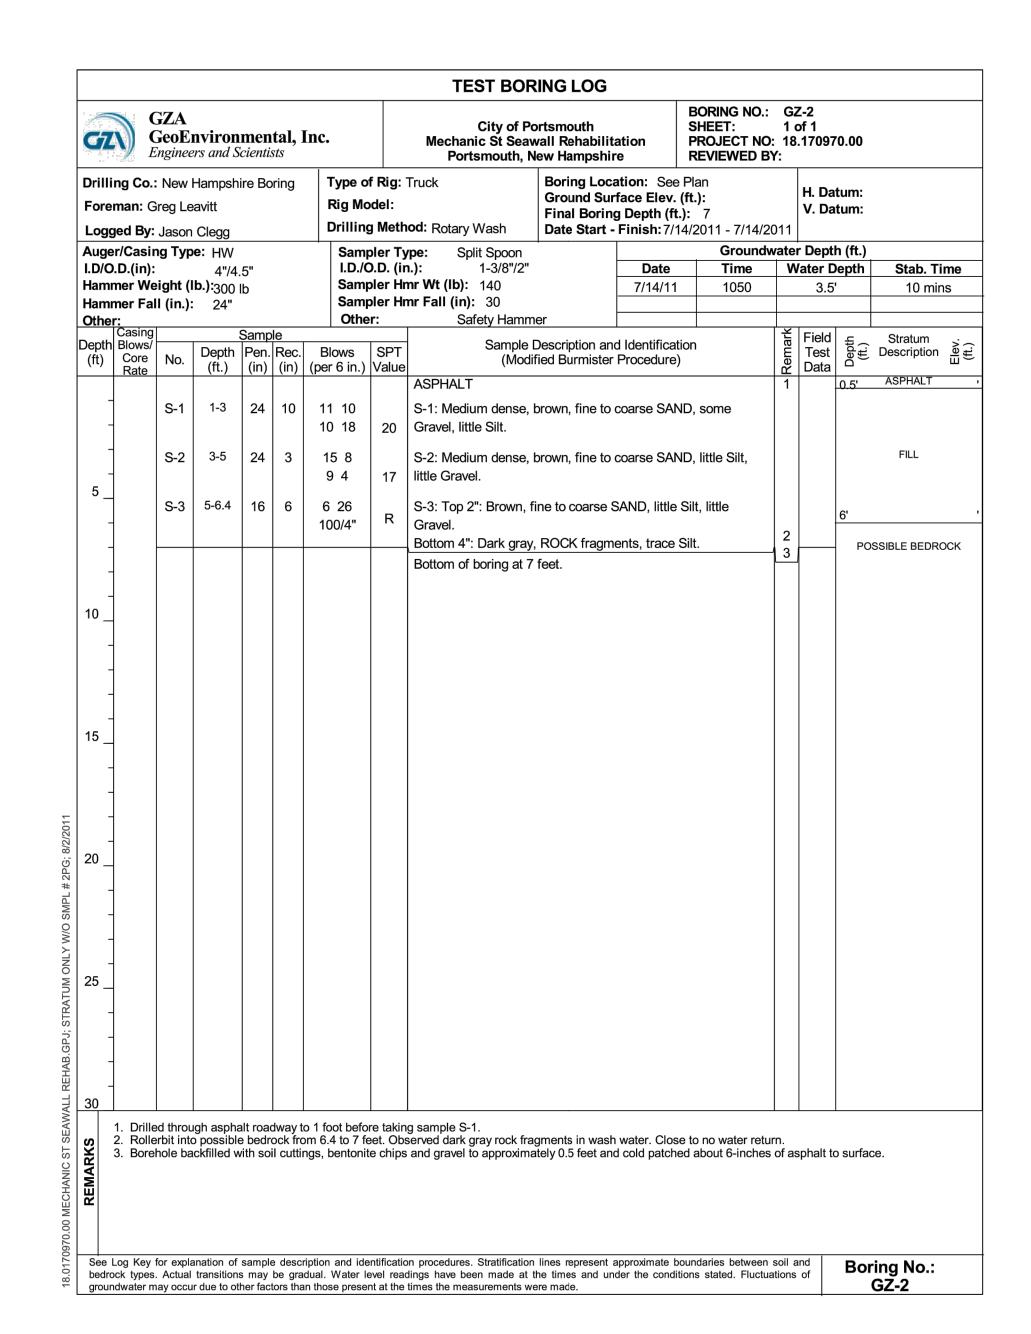
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NHDES FILE #2012-00751 CITY OF PORTSMOUTH, MECHANIC & PICKERING STREET

MECHANIC STREET SEAWALL GEOTECHNICAL BORING LOGS

PARED BY:

Vine


ASSOCIATES
A DIVISION OF

PARED BY:

GZA GeoEnvironm
Engineers and Science
www.gza.com

CITY OF PORTSMOUTH, NH

PROJ MGR: CWC	REVIEWED BY: RJM	CHECKED BY: JJZ	DRAWING			
DEGLONED DV	DD 414/41 D1/4 117	00415 4001101441	J. W			
DESIGNED BY: CWC	DRAWN BY: JJZ	SCALE: AS SHOWN	A			
DATE:	PROJECT NO.	REVISION NO.	1 4			
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JANUARY 2013	18.0170970.00	JANUARY 2013	SHEET NO. 4 OF 9			

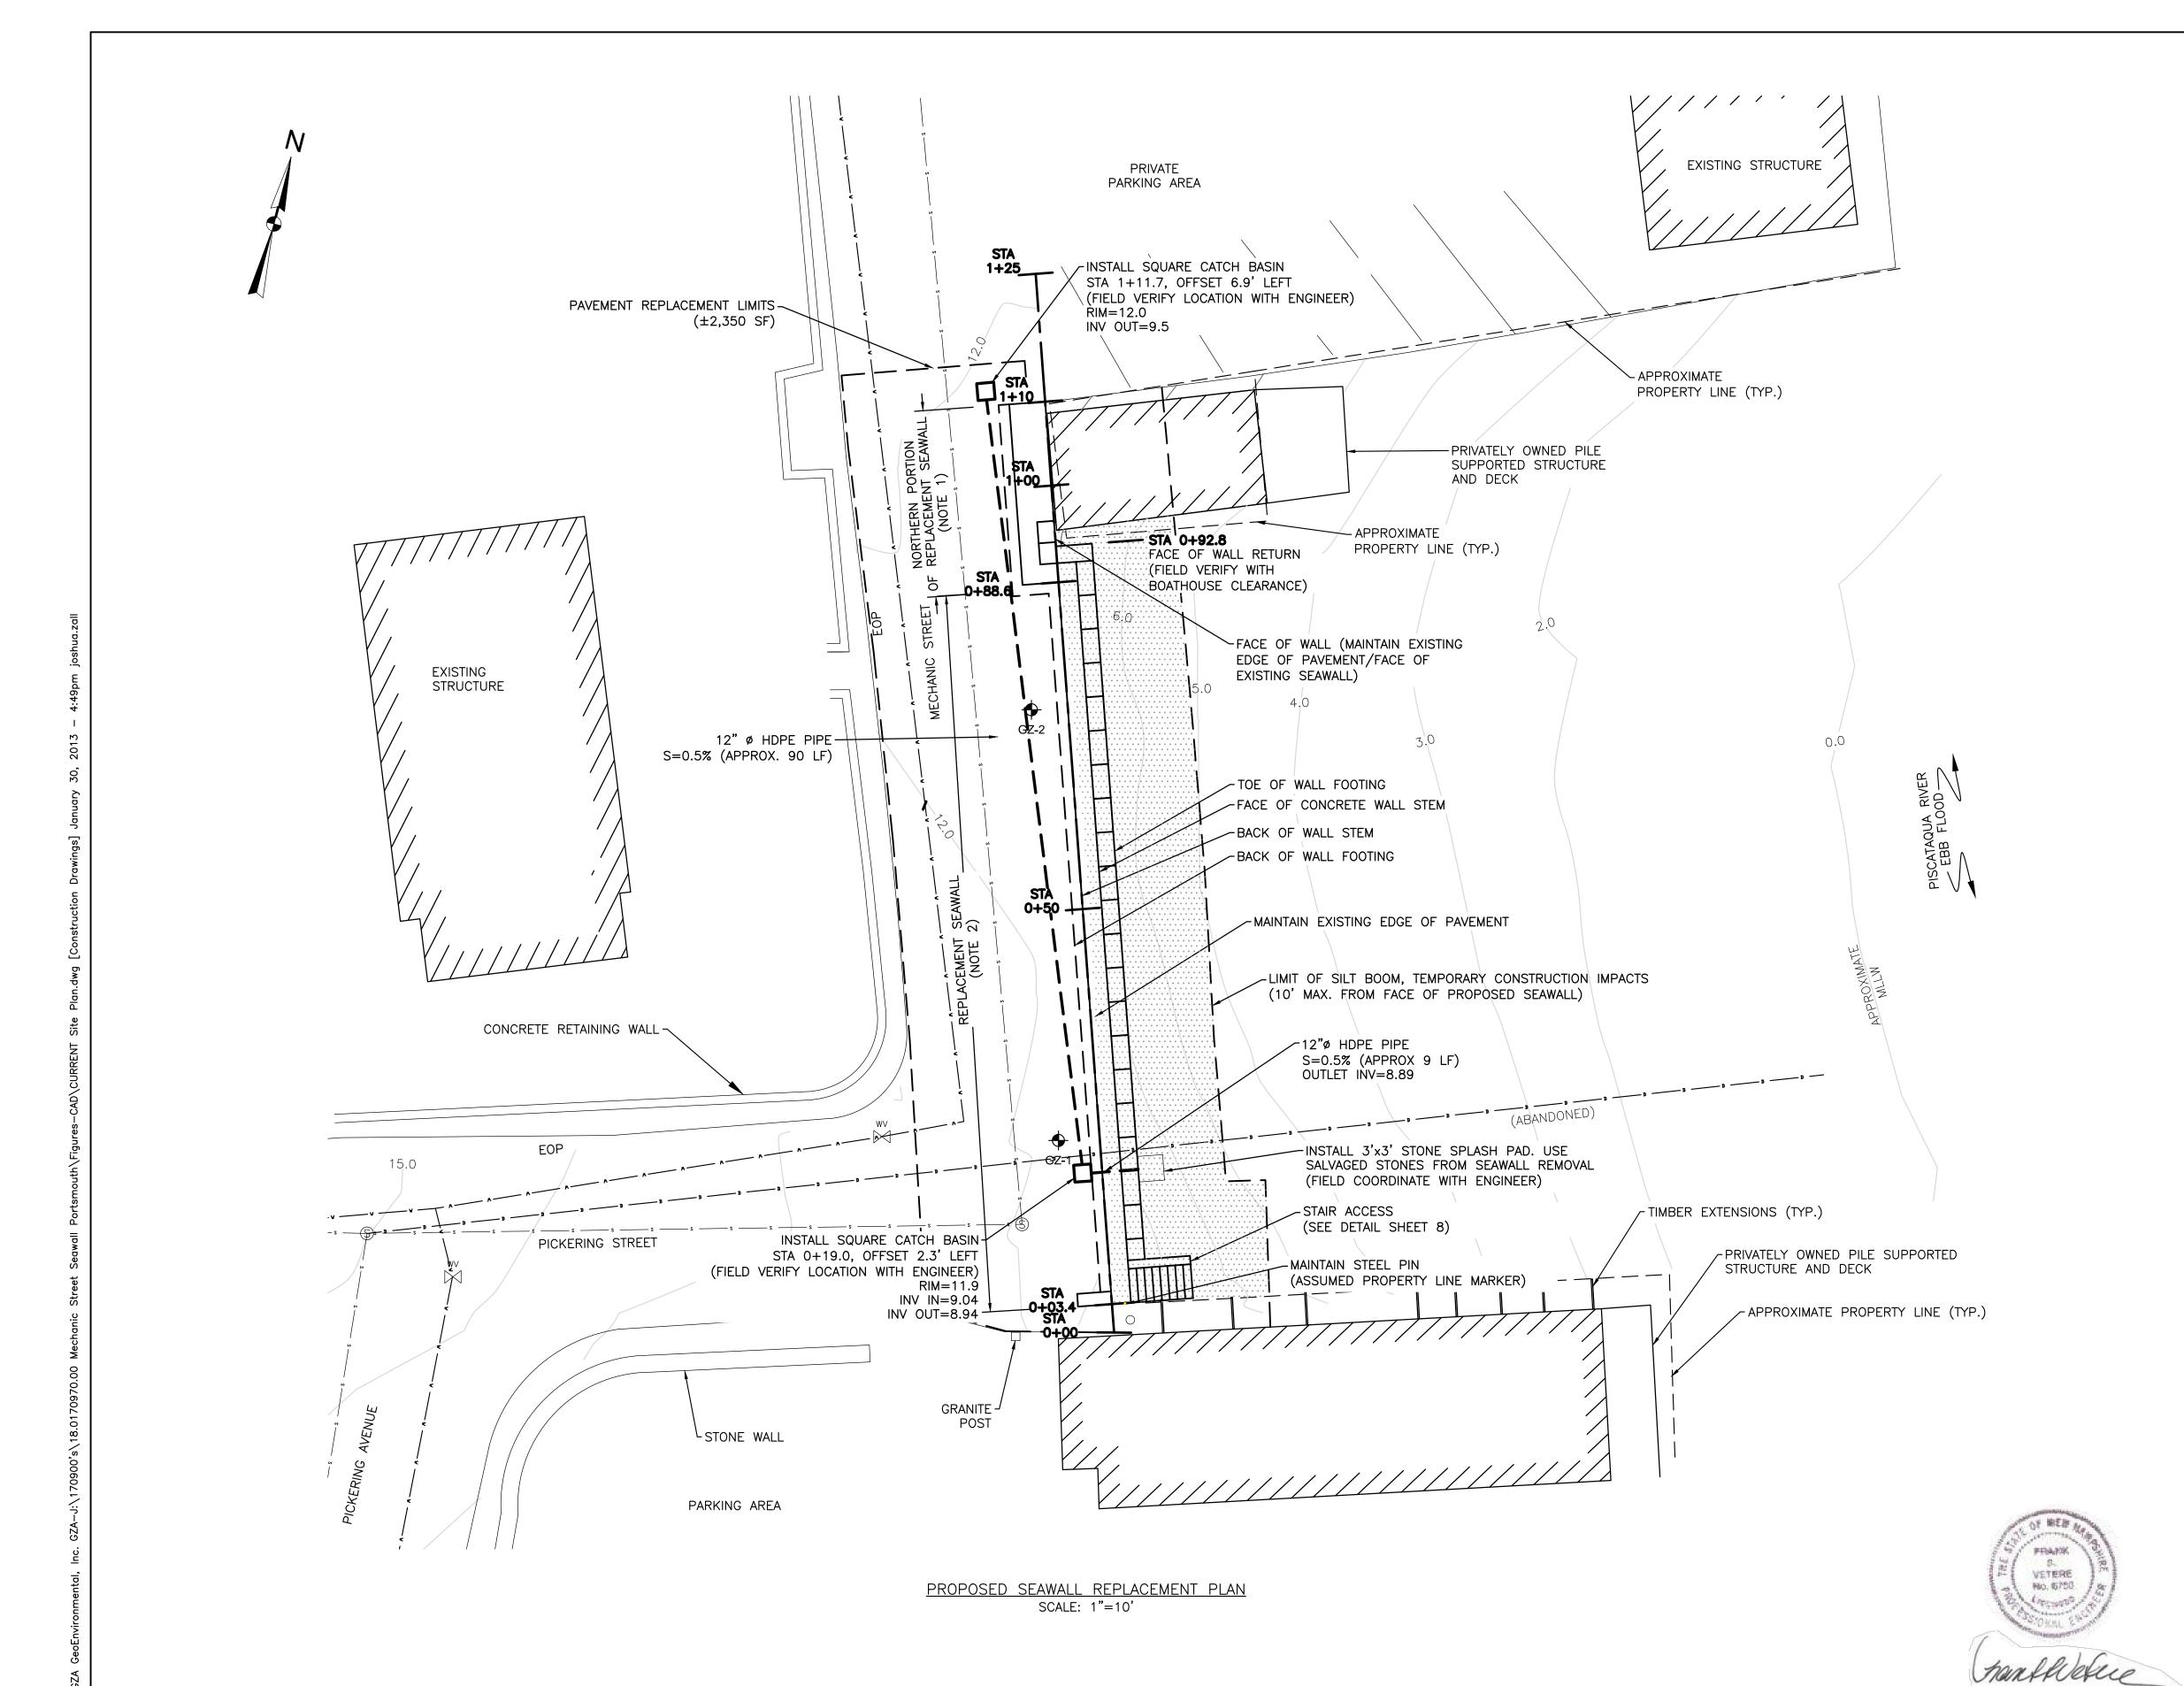

NOTES:

- 1. THE NORTHERN PORTION OF THE REPLACEMENT SEAWALL SHALL BE SET SUCH THAT THE FACE OF THE REPLACEMENT WALL STEM MAINTAINS THE FACE OF THE EXISTING WALL/EDGE OF PAVEMENT. GRANITE FACING IS NOT INCLUDED WITHIN THIS PORTION OF THE REPLACEMENT WALL.
- 2. EXCEPT AT THE NORTHERN PORTION OF THE REPLACEMENT SEAWALL, THE REPLACEMENT SEAWALL SHALL BE SET SUCH THAT THE BACK OF THE REPLACEMENT WALL STEM MAINTAINS THE FACE OF THE EXISTING WALL/EDGE OF PAVEMENT. GRANITE FACING SHALL BE SET ALONG THE FACE OF THE REPLACEMENT SEAWALL STEM INCLUDING THE WALL RETURN TO THE NORTHERN PORTION OF THE SEAWALL.

LEGEND:

BORING COMPLETED BY NEW HAMPSHIRE BORING, INC. ON JULY 14, 2011

S SEWER MANHOLE

WATER GATE

---- EXISTING DRAIN LINE

----- EXISTING SEWER LINE

----- EXISTING WATER LINE

TIDAL WETLAND TEMPORARY IMPACT AREA

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NHDES FILE #2012-00751 CITY OF PORTSMOUTH, MECHANIC & PICKERING STREET

MECHANIC STREET SEAWALL REPLACEMENT PLAN

EPARED BY:

GZA GeoEnvironmental, Inc.


CITY OF PORTSMOUTH, NH

PROJ MGR: CWC REVIEWED BY: RJM CHECKED BY: JJZ

DESIGNED BY: CWC DRAWN BY: JJZ SCALE: AS SHOWN


DATE: PROJECT NO. REVISION NO.

JULY 2012 18.0170970.00 JANUARY 2013 SHEET NO. 5 OF 9

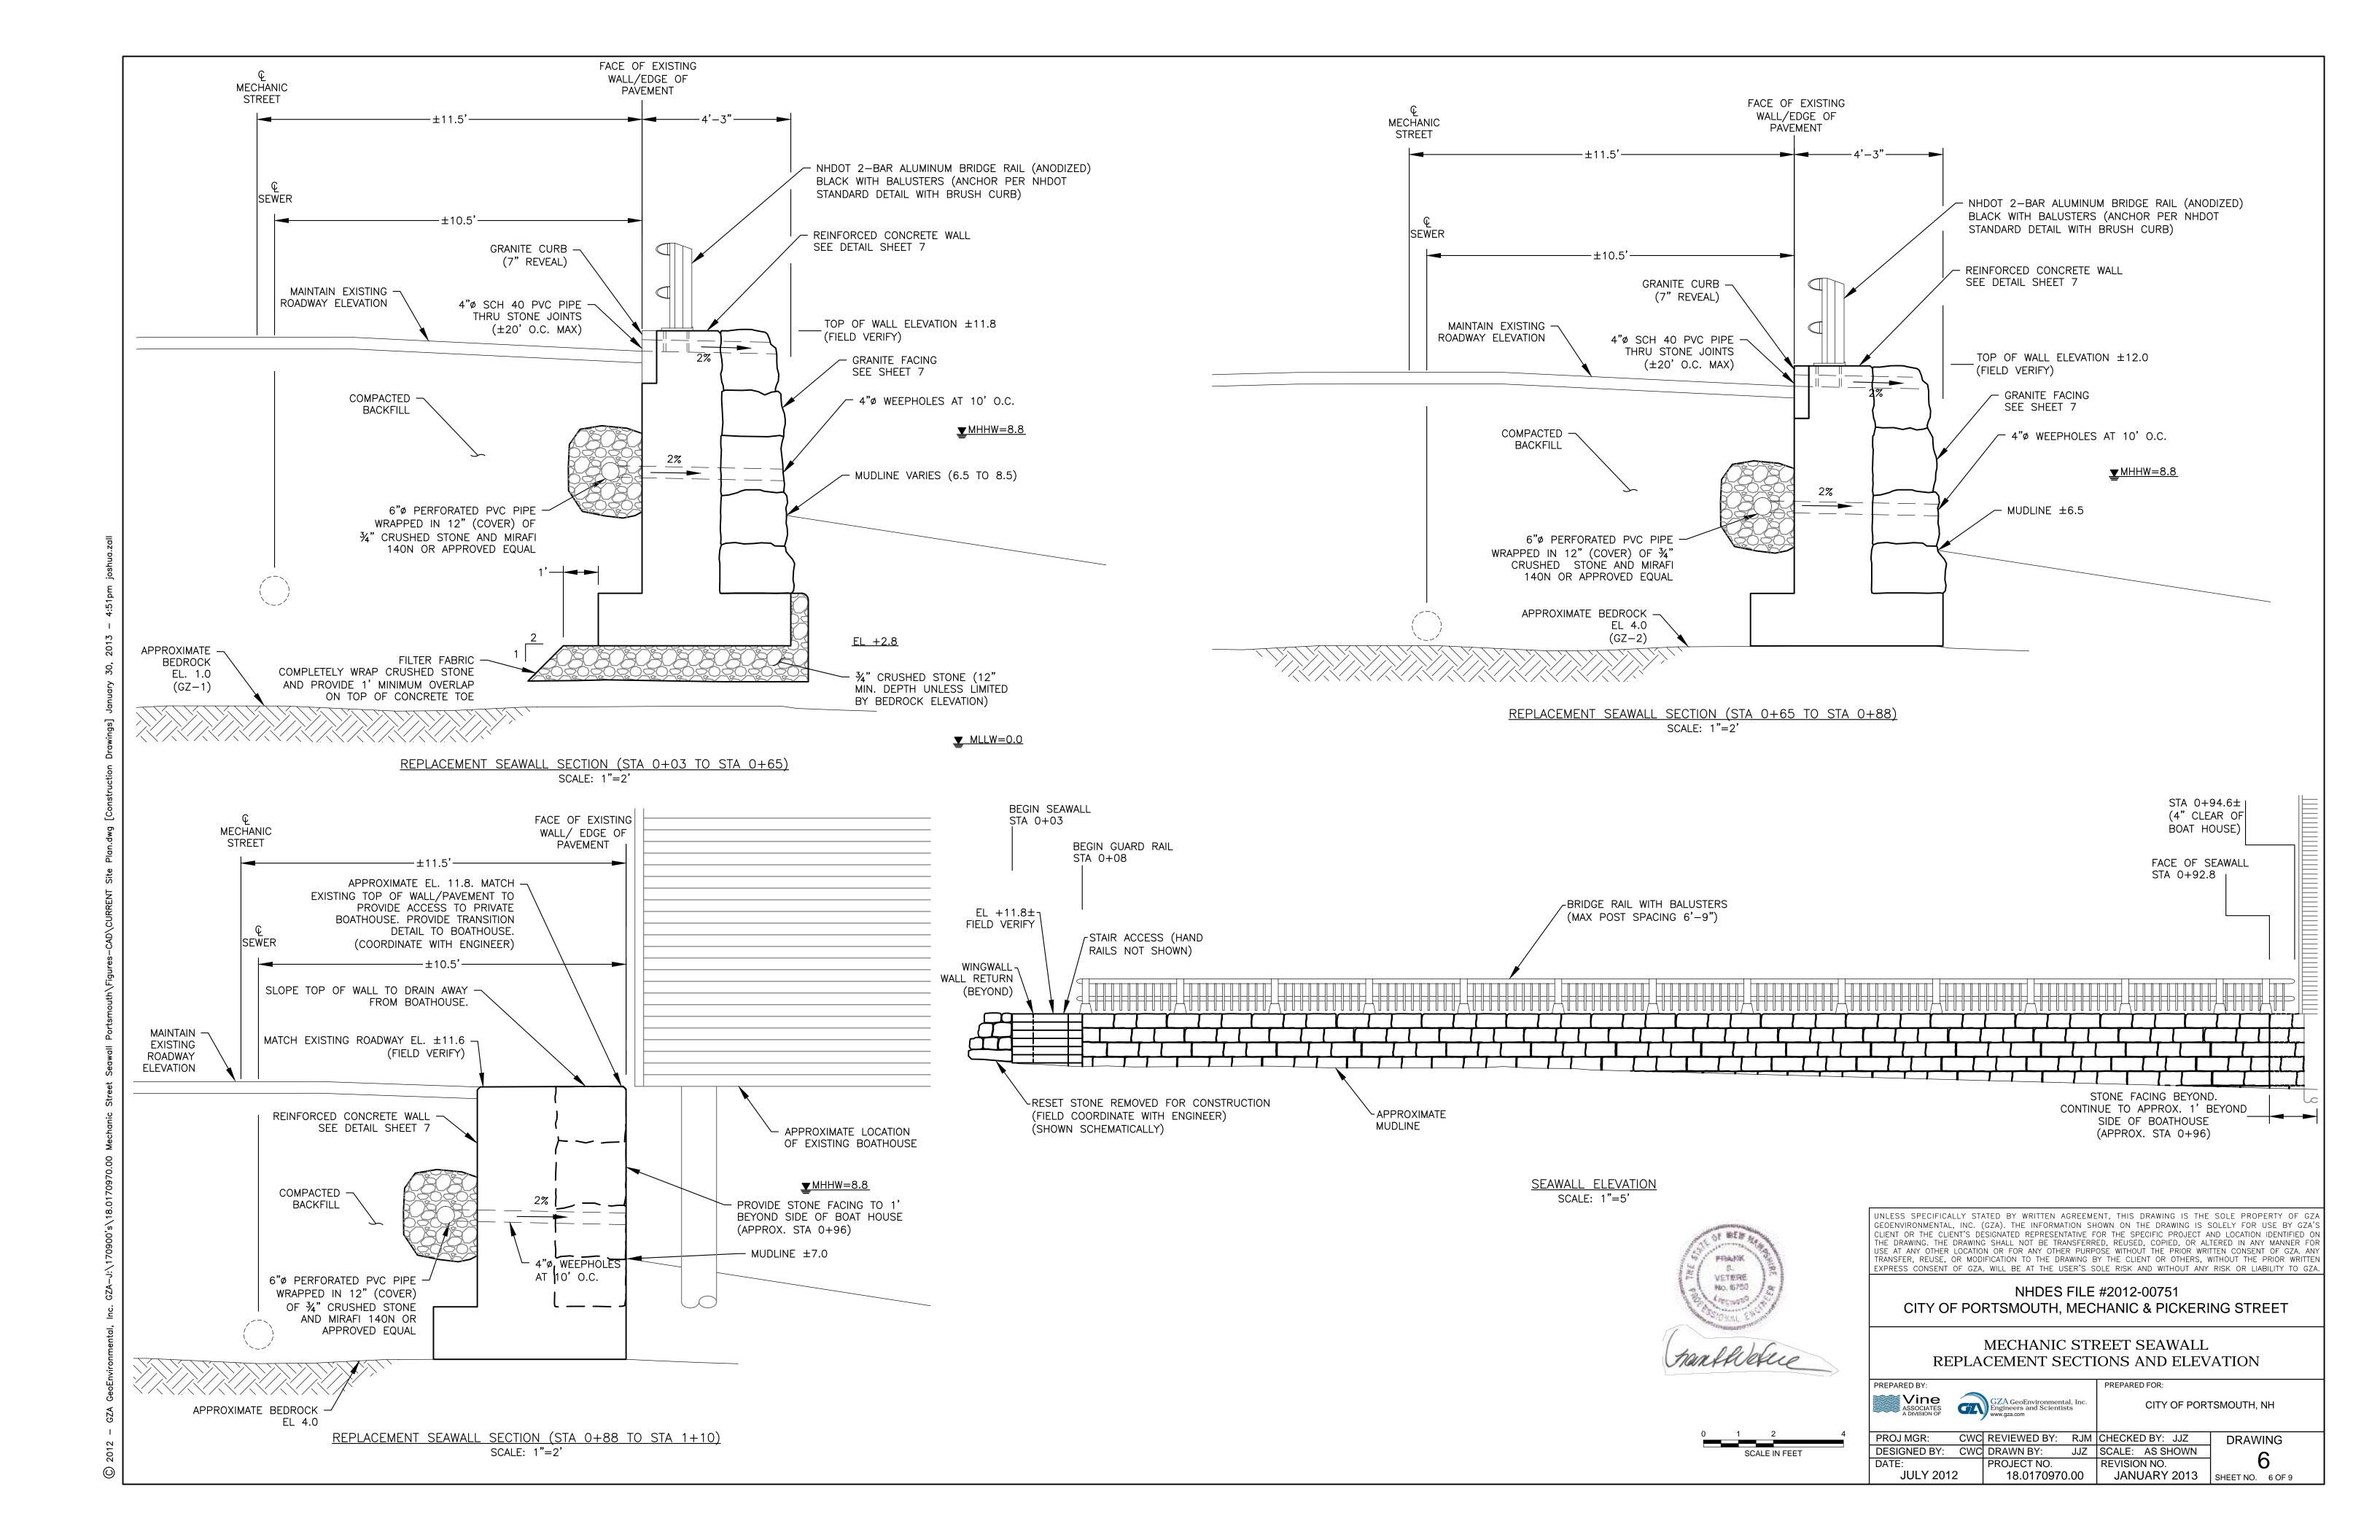


1'-3" 5" 1'-10"

SEAWALL SECTION SHOWN IF FOR AN 8' TO 9' OVERALL WALL HEIGHT (INCLUDING FOOTING). IF BEDROCK IS ENCOUNTERED AT AN ELEVATION ÀBOVE EL. 4.0, NOTIFY THE ENGINEER

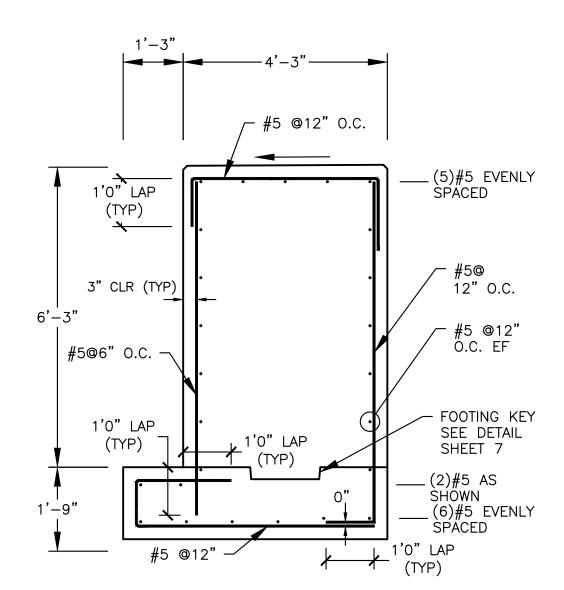



REPLACEMENT SEAWALL REINFORCING (STA 0+65 TO STA 0+88) SCALE: 1"=2'

SEAWALL SECTION BASED ON AN OVERALL 8 FT HEIGHT (INCLUDING FOOTING). IF BEDROCK IS ENCOUNTERED, AT AN ELEVATION ABOVE EL. +4.0 NOTIFY THE ENGINEER

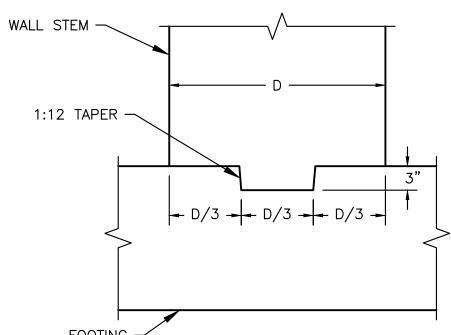

FOOTING KEY DETAIL SCALE: N.T.S.

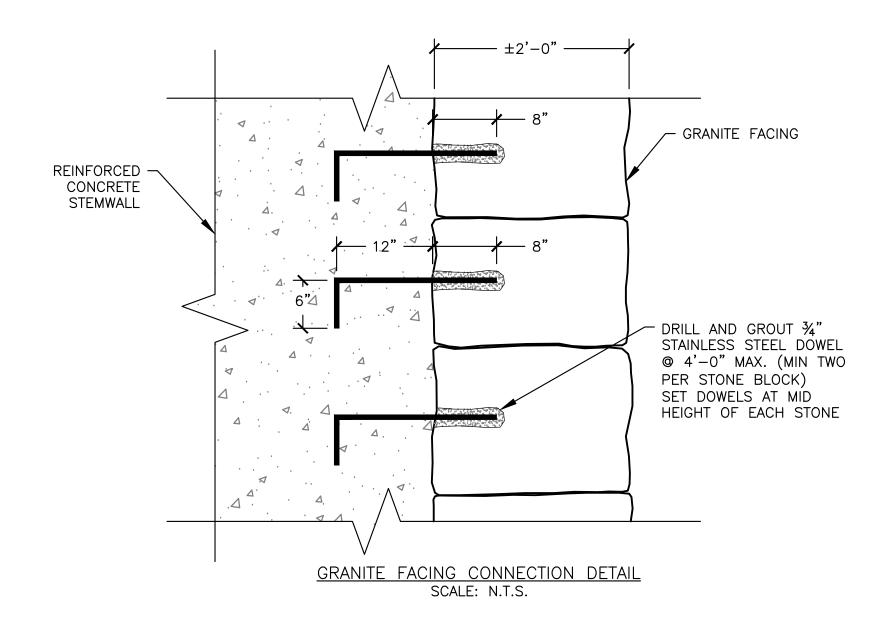

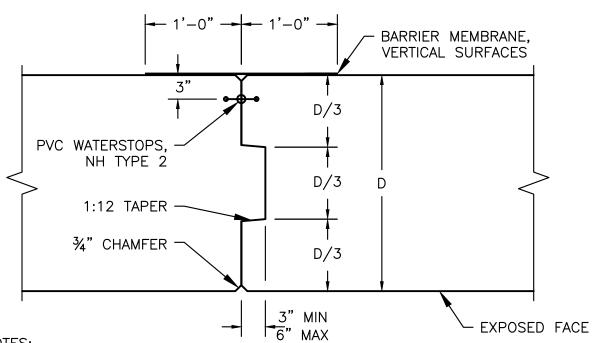


NOTES:


SCALE IN FEET


- 1. IF REINFORCING EXTENDS THROUGH THE JOINT,
- WATERSTOP IS NOT REQUIRED 2. MAXIMUM 50 FOOT SPACING.

CONSTRUCTION JOINT DETAIL SCALE: N.T.S.

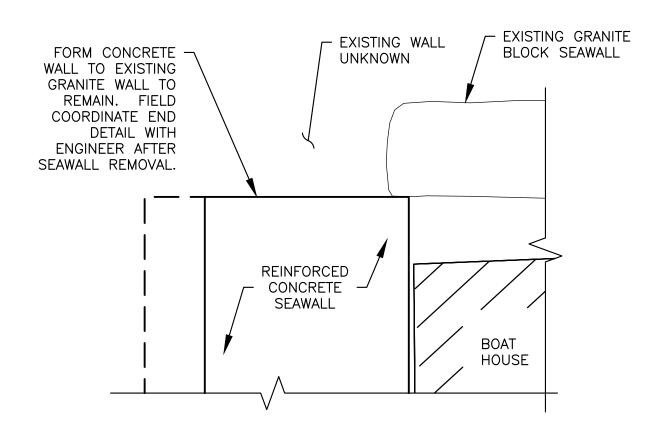

SEAWALL NORTH END DETAIL — PLAN SCALE: 1"=2'

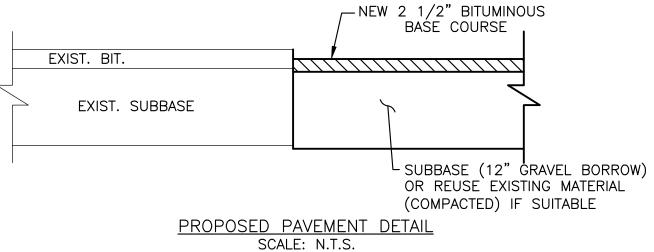

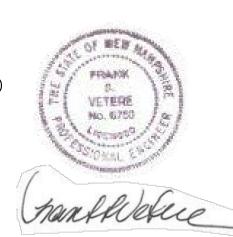


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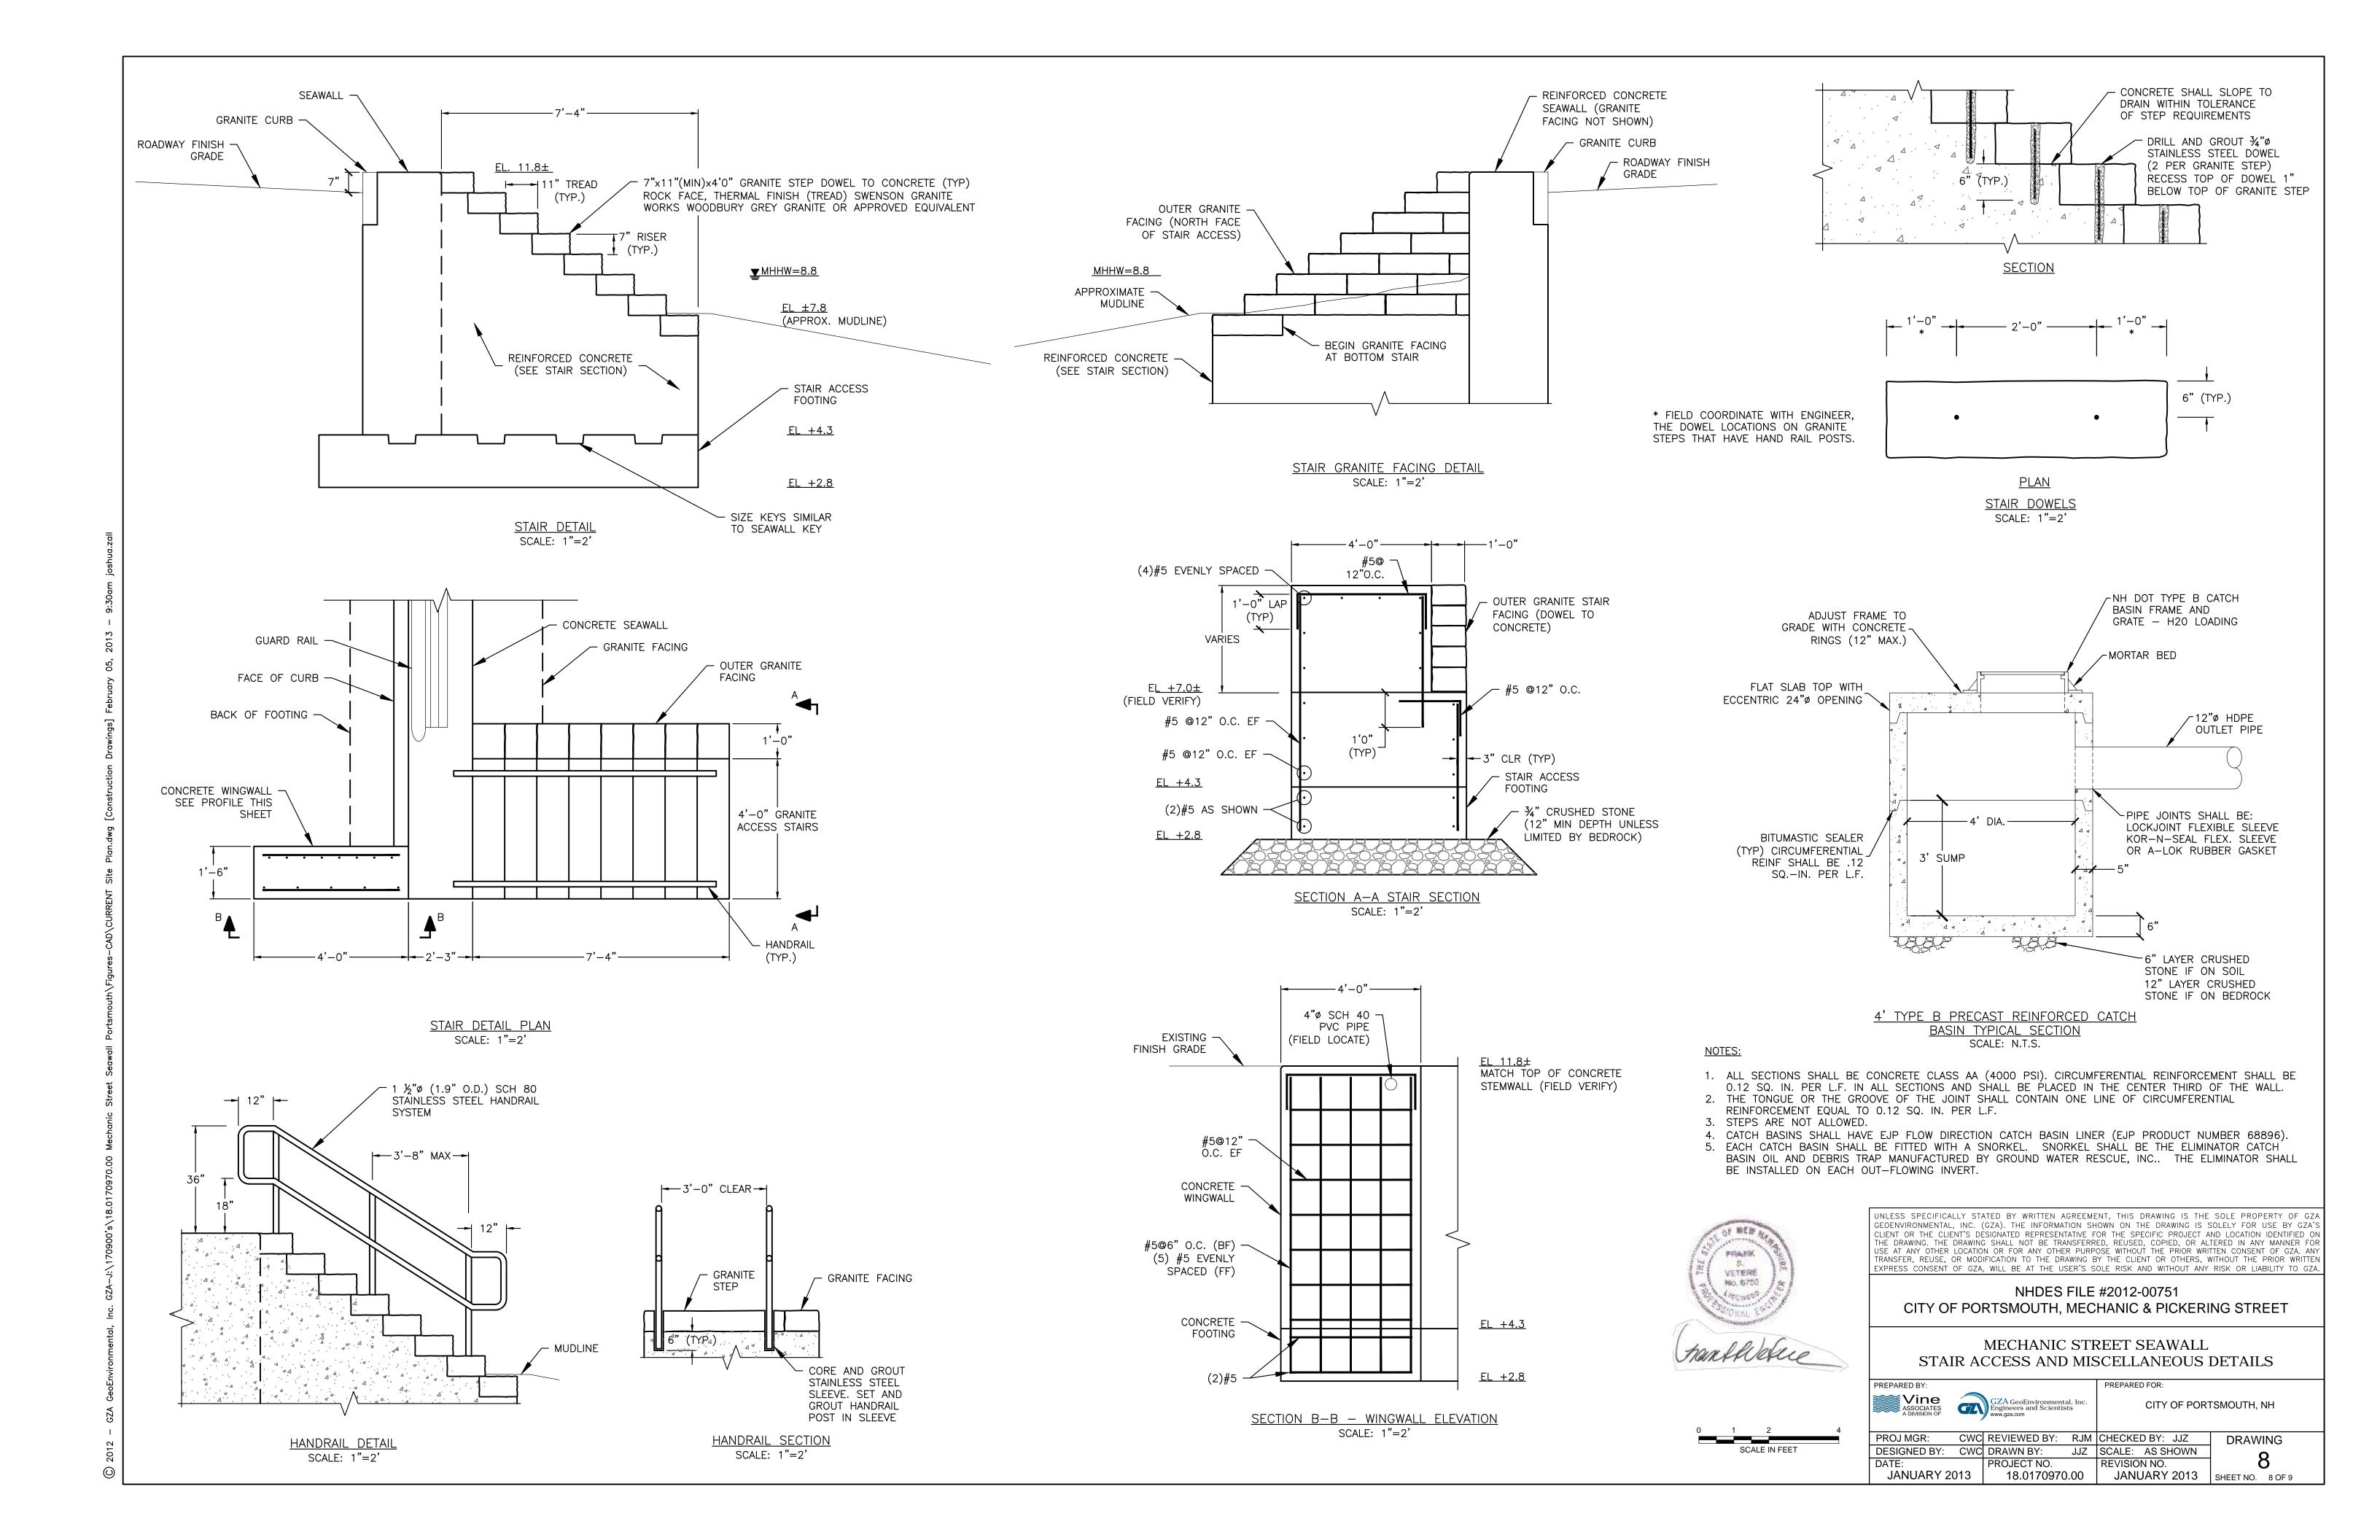
NHDES FILE #2012-00751 CITY OF PORTSMOUTH, MECHANIC & PICKERING STREET


MECHANIC STREET SEAWALL REPLACEMENT DETAILS

CITY OF PORTSMOUTH, NH

CWC REVIEWED BY: RJM CHECKED BY: JJZ DRAWING DESIGNED BY: CWC DRAWN BY: JJZ SCALE: AS SHOWN PROJECT NO. REVISION NO. JANUARY 2013 18.0170970.00 JANUARY 2013 SHEET NO. 7 OF 9



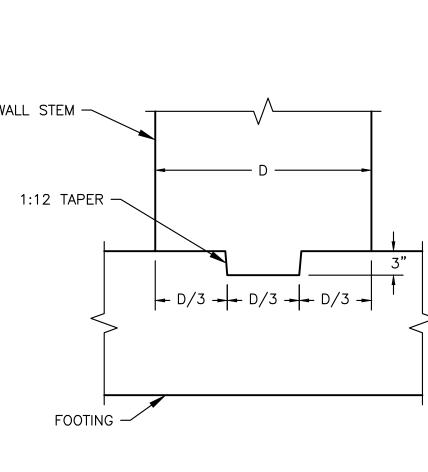

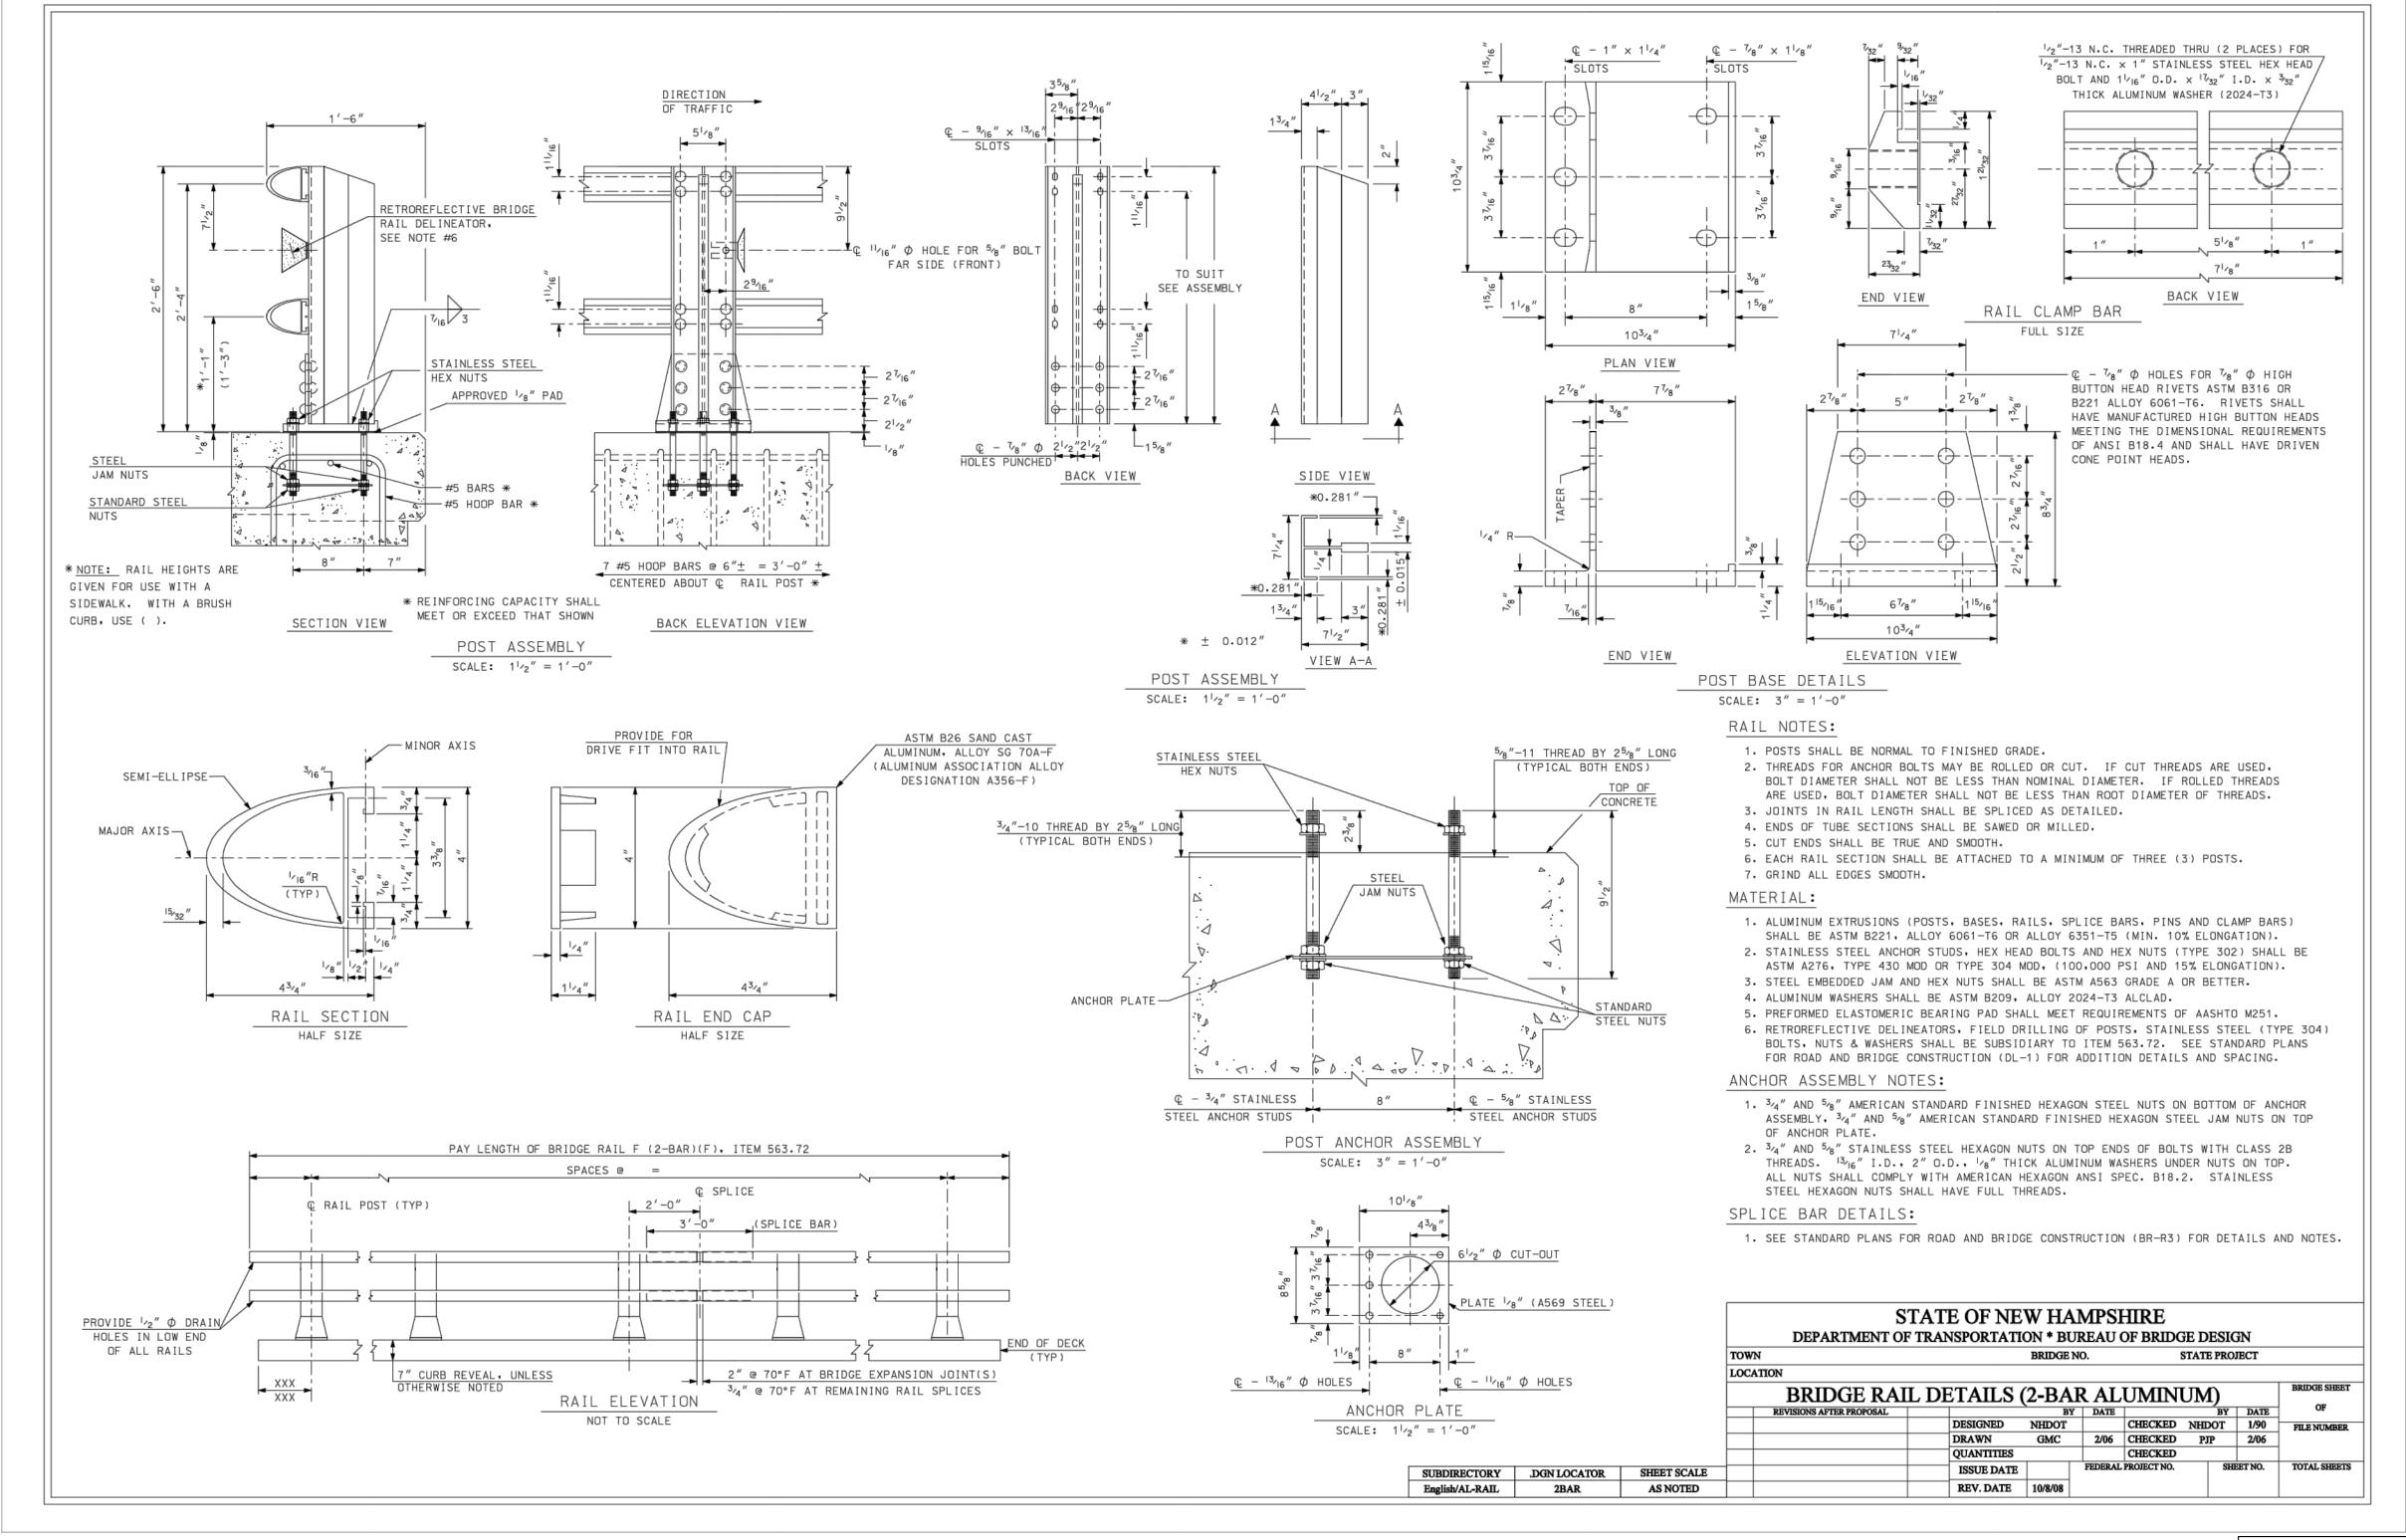

MATERIAL MODIFICATION NOTE:

1. STAINLESS STEEL SHALL BE TYPE 316.

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NHDES FILE #2012-00751 CITY OF PORTSMOUTH, MECHANIC & PICKERING STREET

MECHANIC STREET SEAWALL NHDOT STANDARD, BRIDGE RAIL DETAILS (2-BAR ALUMINUM)

Vine
ASSOCIATES
A DIVISION OF



CITY OF PORTSMOUTH, NH

PROJ MGR: CWC REVIEWED BY: RJM CHECKED BY: JJZ

DESIGNED BY: CWC DRAWN BY: JJZ SCALE: AS SHOWN

DATE: PROJECT NO. REVISION NO. JANUARY 2013

18.0170970.00

DRAWING

SHEET NO. 9 OF 9