46 Maplewood LLC is requesting a recommendation to the Historic District Commission to approve a Conditional-Use Permit (CUP) for the property located at 46-64 Maplewood Avenue.

- The CUP is for a relief of 45' in building height where 40' is allowed.
- The CUP is for relief from the Ordinance definition of Penthouse which stipulates a setback of 15' from all roof edges and total floor area not exceeding 50% of the story below. The proposed development has a 0' setback at the Maplewood-Deer Street intersection and is 62% of the floor area below.

Thank you for your consideration in this approval process.

Sincerely,

Jennifer Ramsey

SOMMA Studios on behalf of 46 Maplewood LLC



CONDITIONAL USE PERMIT QUALIFYING CRITERIA (AS EXHIBITED IN ELEVATION VIEW)


A. CIVIC SPACE:

B. PARKING: C. BUILDING MATERIALS: D. BUILDING SCALE ELEMENTS: WE ARE PROVIDING PERMANENTLY ACCESSIBLE, PUBLIC, OPEN SPACE SUCH AS; WIDENED SIDEWALKS, PLAZAS AND PEDESTRIAN-ONLY THROUGHWAYS. [THIS WILL TALLY MORE THAN 30% OF OUR LOT SIZE]. WE HAVE SPOKEN WITH THE ABUTTING PROPERTY, (aka VFW) AND WILL BE DRAFTING AN EASEMENT WITH THEM TO EXTEND LANDSCAPING UP TO THEIR BUILDING AND MAKE COSMETIC IMPROVE THE EXPERIENCE BETWEEN AND AROUND THESE TWO (2) NEIGHBORING STRUCTURES. WE ARE PROVIDING UNDERGROUND AND CONCEALED PARKING, WE ARE ALSO DIMINISHING AND BEAUTIFYING THE REMAINING SURFACE PARKING ON THE ADJACENT LOT.

WE ARE PROVIDING DAND CONCEALED PARKING, WE ARE ALSO DIMINISHING AND BEAUTIFYING THE REMAINING SURFACE PARKING ON THE ADJACENT LOT.

WE ARE PROVIDING MAD CONCEALED PARKING, WE ARE ALSO DIMINISHING STRUCTURES.

SCALING ELEMENTS, DETAILS AND MASSING TECHNIQUES FOCUSING ON THE PEDESTRIAN EXPERIENCE HAVE BEEN IMPLEMENTED SUCH AS STEPPING THE BUILDING, HORIZONTAL BANDS, EAVE BANDS AND DECORATIVE BUILDING CAPS, AWNINGS, PILASTERS AND COLUMNS AS WELL AS VARIED WINDOWS, DOOR SIZES AND MULTIPLE POINTS OF ENTRY.

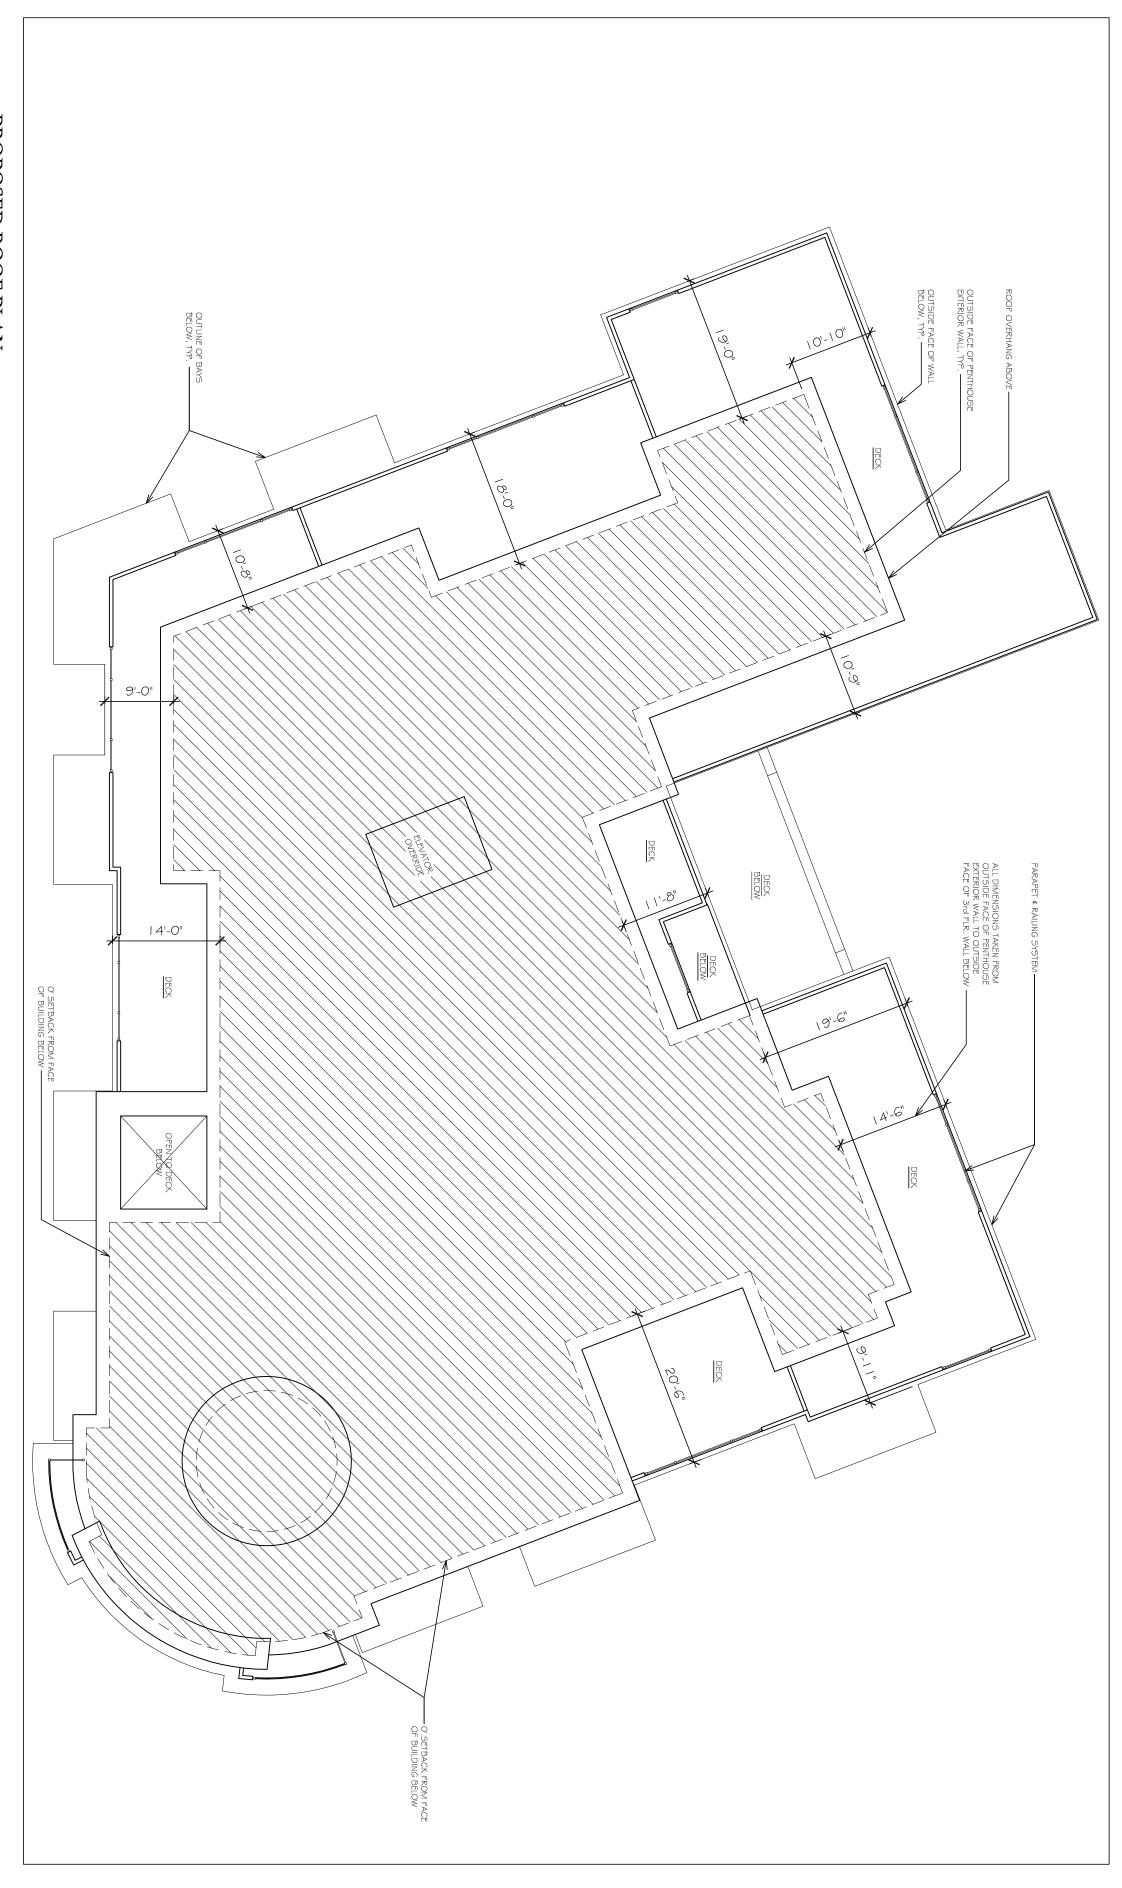

PROPOSED ROOF PLAN SCALE: N.T.S.

CONDITIONAL USE PERMIT QUALIFYING CRITERIA

REQUEST FOR 0'-0" SETBACK FROM FACE OF BUILDING BELOW WHERE 15'-0" MINIMUM IS REQUIRED. REQUEST FOR 62% SQUARE FOOTAGE OF FLOOR BELOW WHERE MAXIMUM 50% IS ALLOWED.

46 MAPLEWOOD AVENUE Portsmouth, New Hampshire

SCALE: AS NOTED




PH

6.7.17

SH.1

SOMMA Studios 603/766.3760

Amoskeag Architectural 603/606.7878

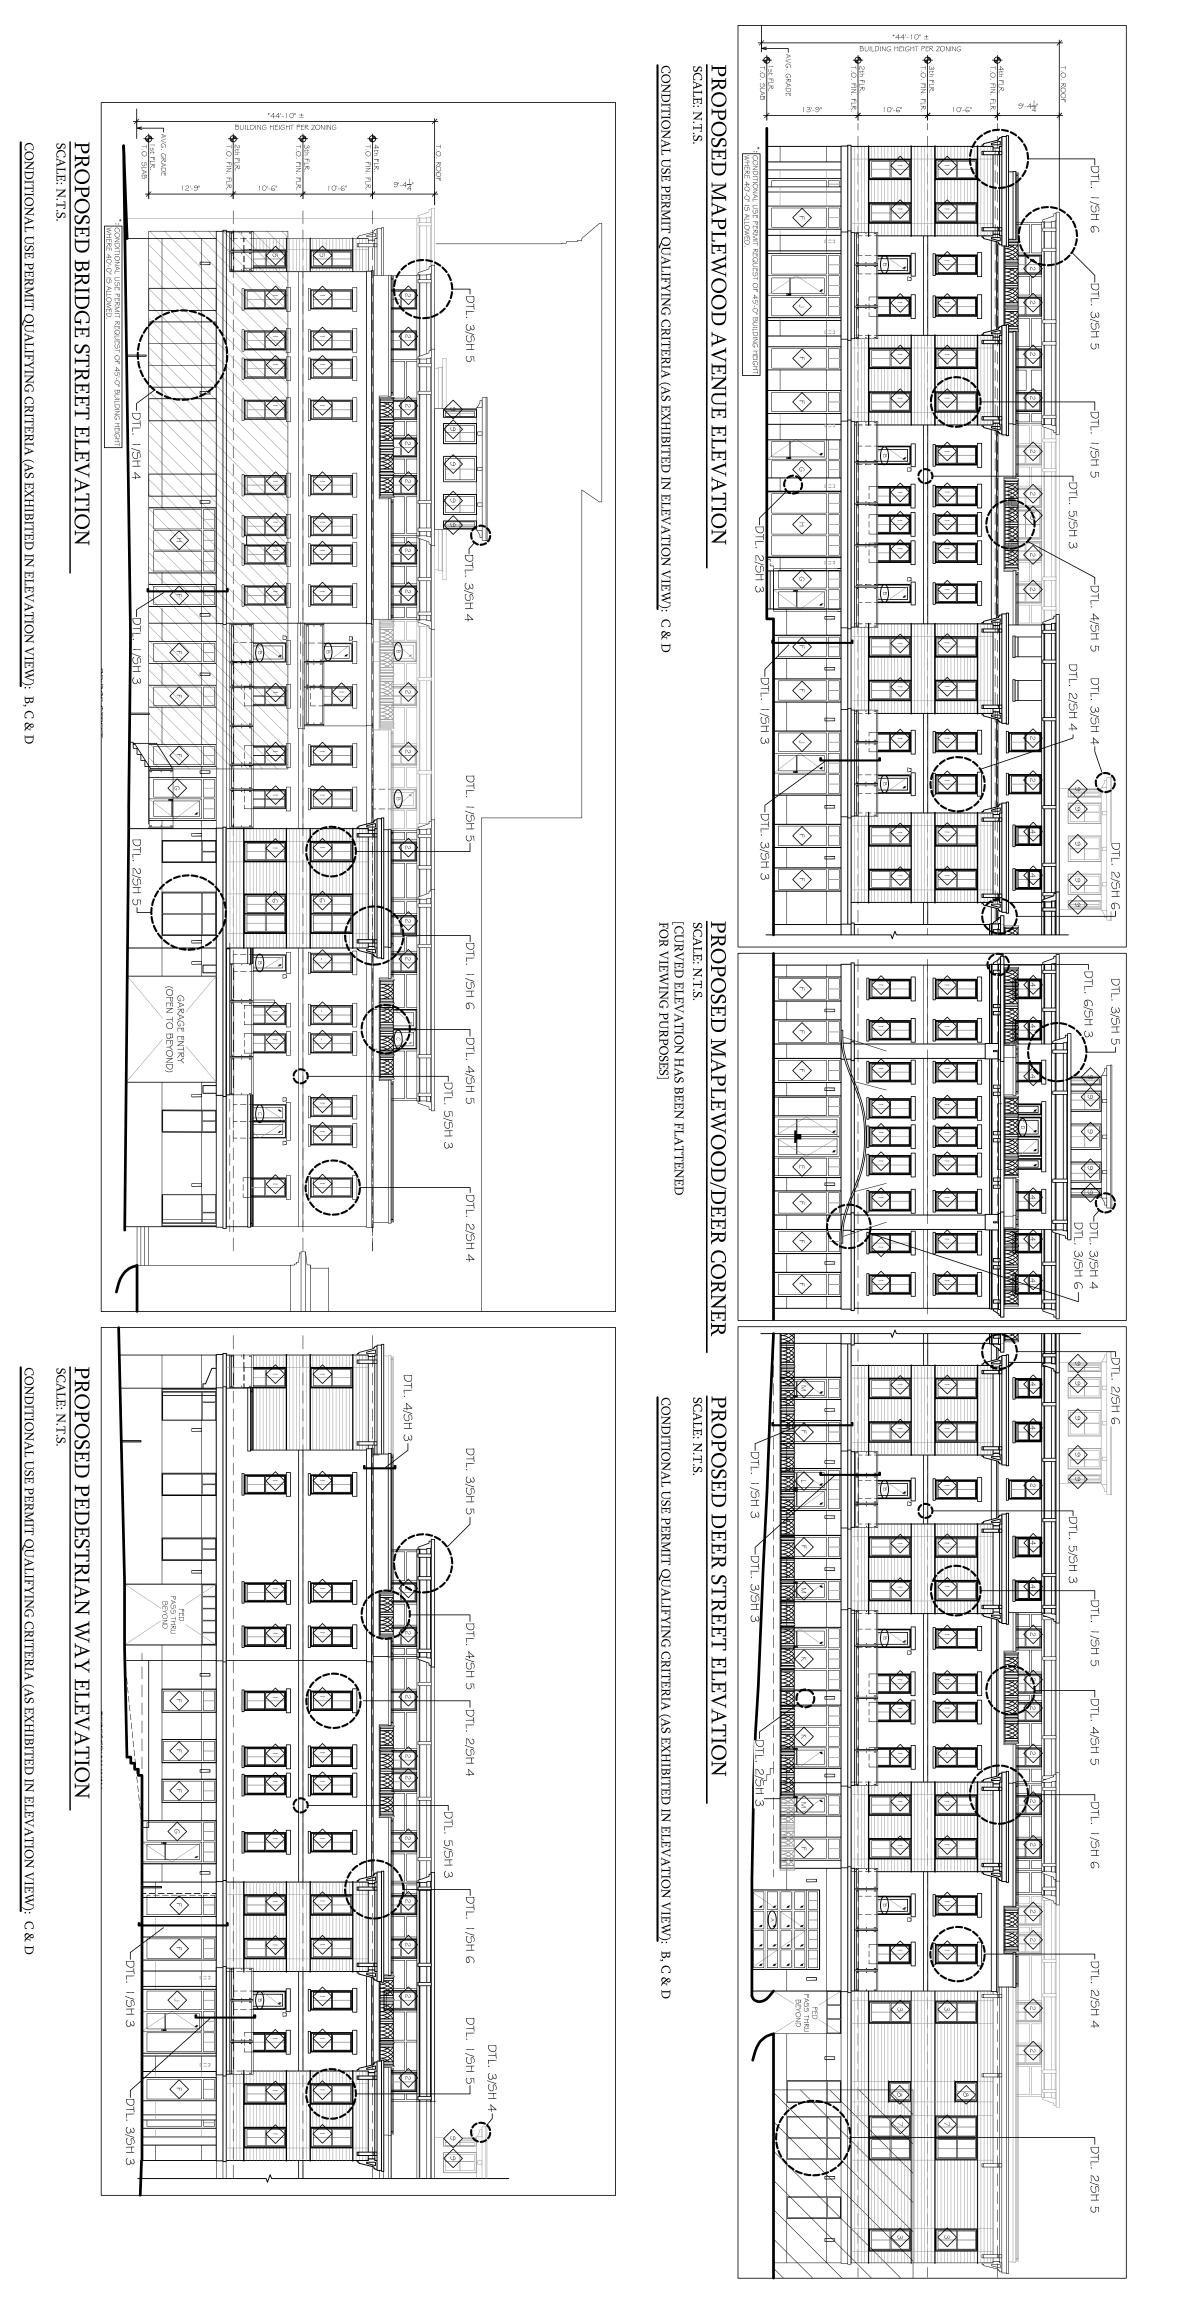

CONDITIONAL USE PERMIT QUALIFYING CRITERIA (AS EXHIBITED IN ELEVATION VIEW) A. CIVIC SPACE: WE ARE PROVIDING PERMANENTLY ACCESSIBLE, PUBLIC

B. PARKING: C. BUILDING MATERIALS: D. BUILDING SCALE ELEMENTS: WE ARE PROVIDING PERMANENTLY ACCESSIBLE, PUBLIC, OPEN SPACE SUCH AS; WIDENED SIDEWALKS, PLAZAS AND PEDESTRIAN-ONLY THROUGHWAYS. [THIS WILL TALLY MORE THAN 30% OF OUR LOT SIZE]. WE HAVE SPOKEN WITH THE ABUTTING PROPERTY, (aka VFW) AND WILL BE DRAFTING AN EASEMENT WITH THEM TO EXTEND LANDSCAPING PROPERTY, (aka VFW) AND WILL BE DRAFTING AN EASEMENT WITH THEM TO EXTEND LANDSCAPING PROPERTY, (aka VFW) AND WILL BE DRAFTING AN EASEMENT WITH THEM TO EXTEND LANDSCAPING PROPERTY, (aka VFW) AND WILL BE DRAFTING AN EASEMENT WITH THEM TO STRUCTURES.

WE ARE PROVIDING AN EASEMENT WITH THEM TO EXTEND LANDSCAPING UP TO THEIR BUILDING TO IMPROVE THE EXPERIENCE BETWEEN AND AROUND THESE TWO (2) NEIGHBORING STRUCTURES.

WE ARE PROVIDING UNDERGROUND AND CONCESSIBLE, PUBLISHED WINDOWS, BOUND THESE TWO (2) NEIGHBORING STRUCTURES.


WE ARE PROVIDING THE EXPERIENCE BETWEEN AND MAKE COSMETIC BUILDING THE BUILDING ON THE EXPERIENCE HAVE BEEN IMPLEMENTED SUCH AS STEPPING THE BUILDING, HORIZONTAL BANDS, EAVE BANDS AND DECORATIVE BUILDING CAPS, AWNINGS, PILASTERS AND COLUMNS AS WELL AS VARIED WINDOWS, DOOR SIZES AND MULTIPLE POINTS OF ENTRY.

46 MAPLEW 700D \triangleright ENU Portsmouth, New Hampshire

PH


SCALE: AS NOTED 6.7.17 SH. 2

Architectural 603/606.7878

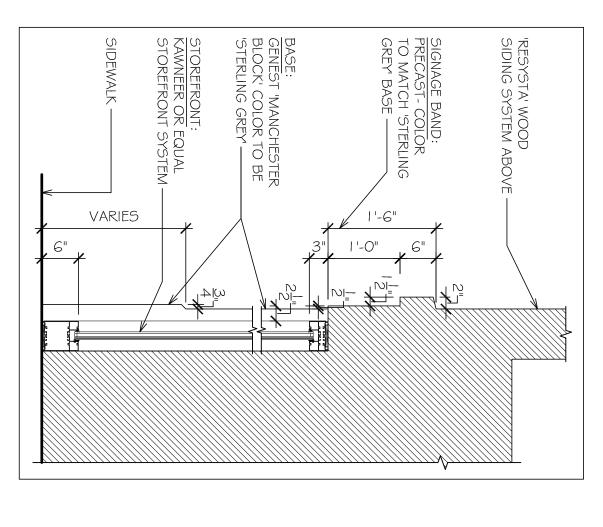

BASE, STOREFRONT & SIGNAGE BAND DETAIL scale: 3/4" = 1'-0"

CONDITIONAL USE PERMIT QUALIFYING CRITERIA (AS EXHIBITED IN ELEVATION VIEW): C & D

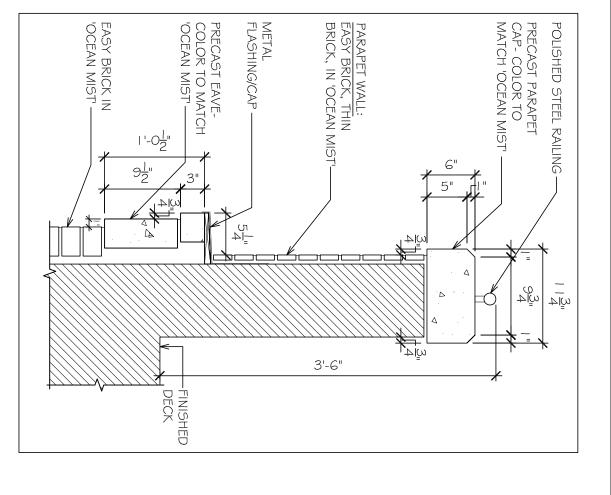

HORIZONTAL BAND:
EASY BRICK IN
OCEAN MIST'

4. HORIZONTAL BAND @ 3rd FLR.

5


HORIZONTAL BAND

@ 3rd FLR.

scale: 1 1/2" = 1'-0"

scale: 1 1/2" = 1'-0"


CONDITIONAL USE PERMIT QUALIFYING CRITERIA (AS EXHIBITED IN ELEVATION VIEW): C

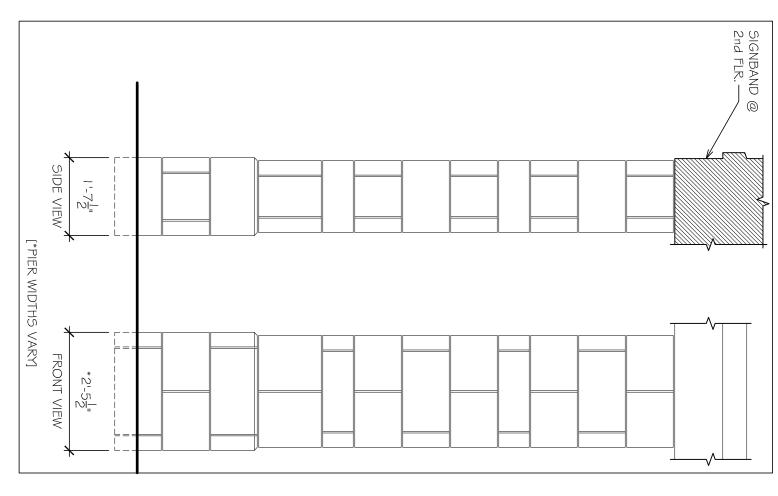

MANCHESTER BLOCK LAYOUT @ BASE

scale: 1/2" = 1'-0"


CONDITIONAL USE PERMIT QUALIFYING CRITERIA (AS EXHIBITED IN ELEVATION VIEW): C & D

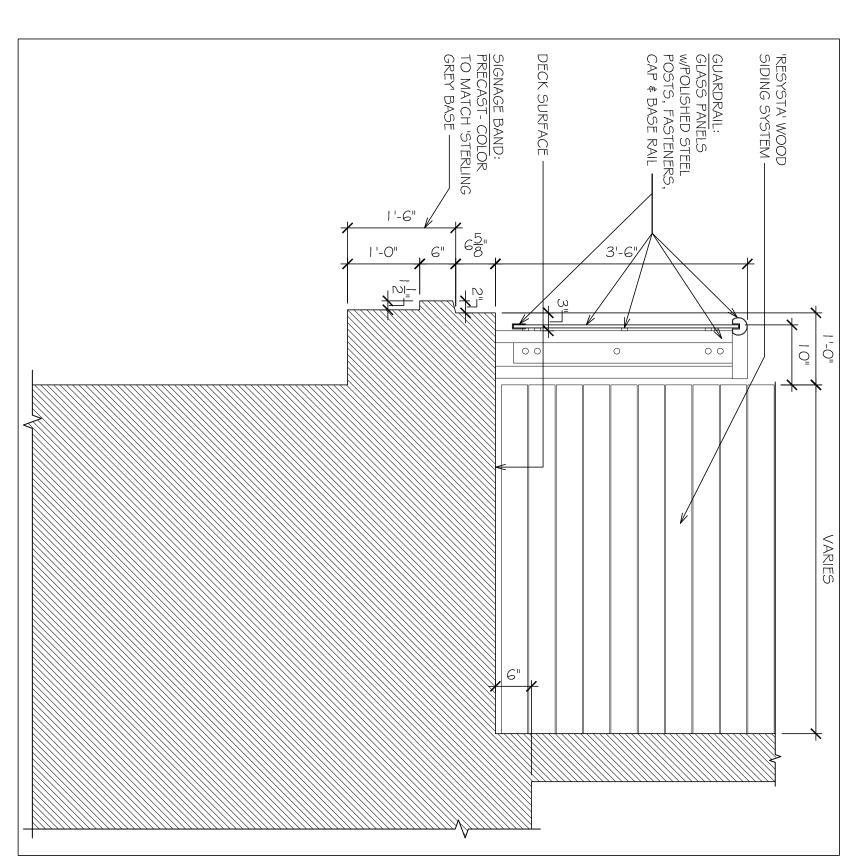

3. BRACKET, HORIZONTAL BAND & DECK DETAIL AT BAYS

scale: 3/4" = 1'-0"

CONDITIONAL USE PERMIT QUALIFYING CRITERIA (AS EXHIBITED IN ELEVATION VIEW): C & D

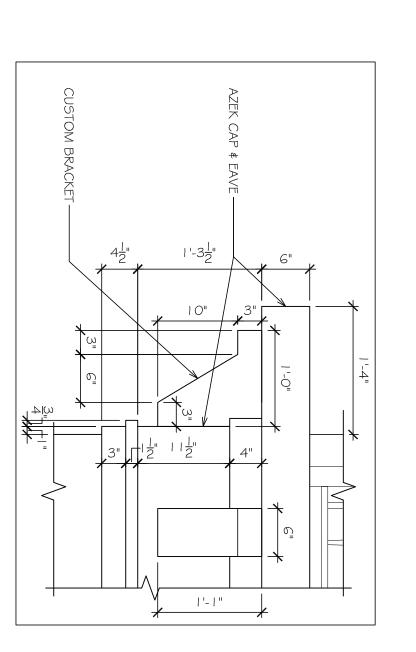

EAVE & BRACKET @ ROUNDED CORNER scale: 1" = 1'-0"

6.


CONDITIONAL USE PERMIT QUALIFYING CRITERIA (AS EXHIBITED IN ELEVATION VIEW): C


CONDITIONAL USE PERMIT QUALIFYING CRITERIA (AS EXHIBITED IN ELEVATION VIEW): C

SCALE: AS NOTED



46 MAPLEWOOD AVENUE Portsmouth, New Hampshire

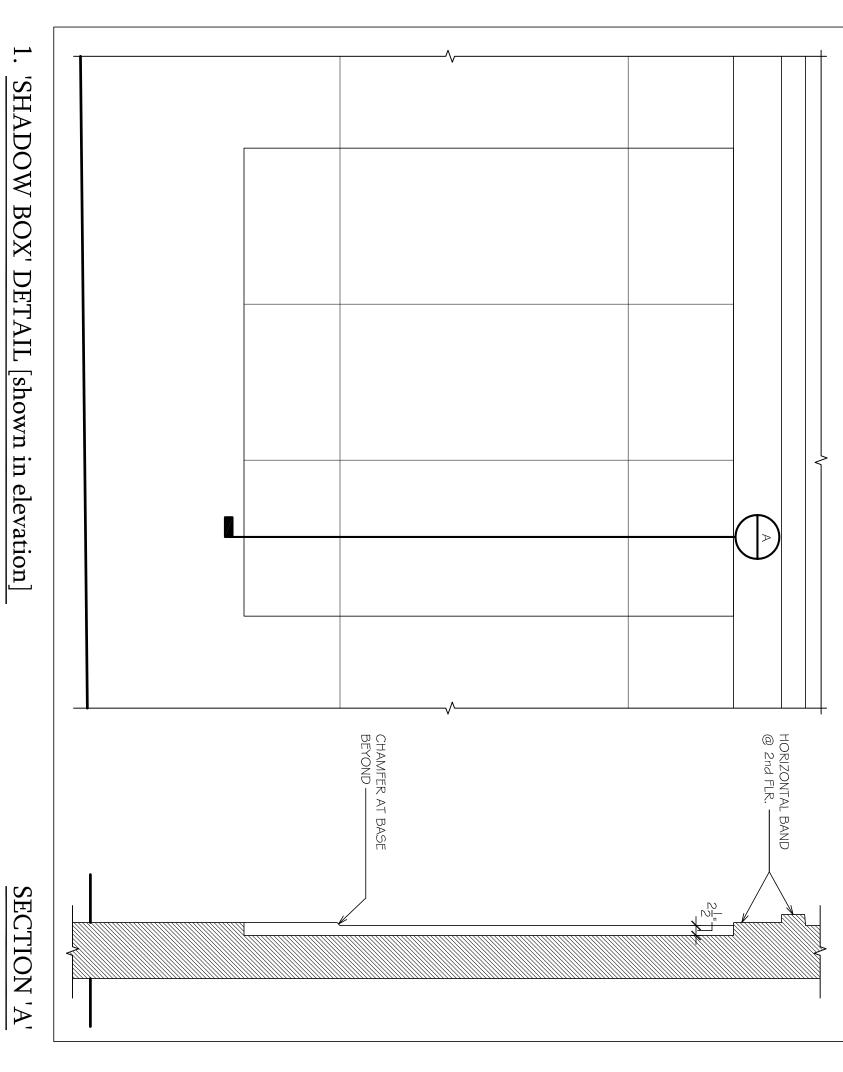

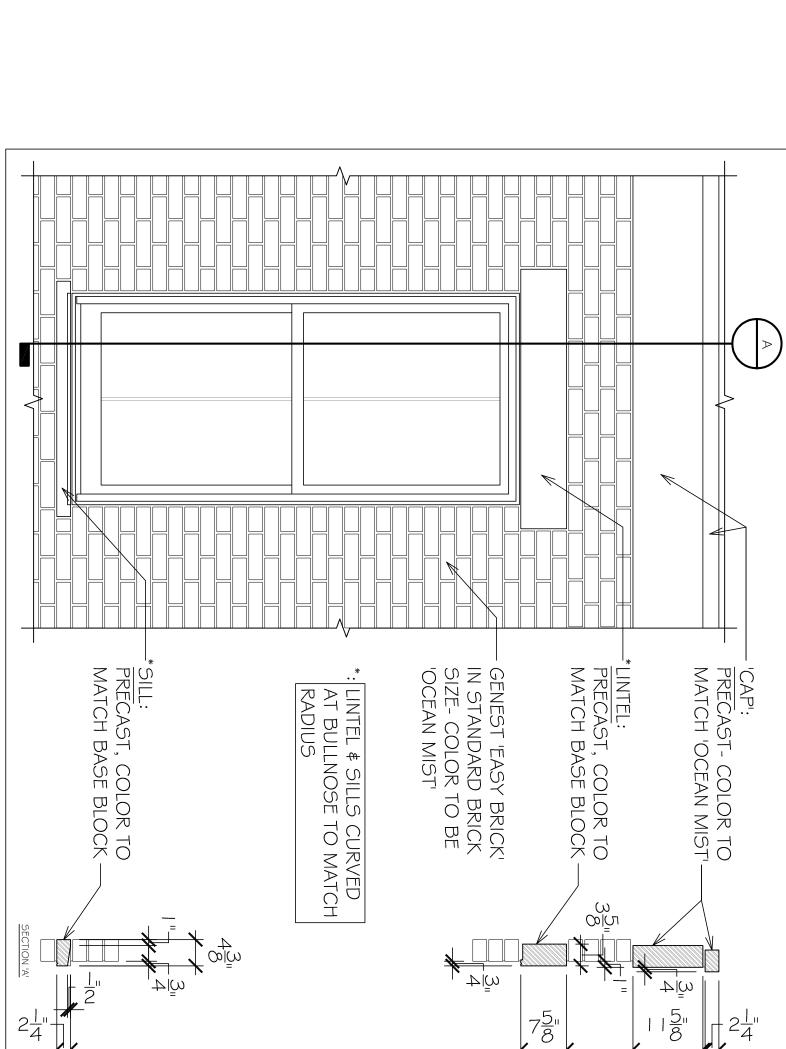


scale: 3/4" = 1'-0" WINDOW HEADER & SILL DETAIL IN MASONRY WALL

2.

CONDITIONAL USE PERMIT QUALIFYING CRITERIA (AS EXHIBITED IN ELEVATION VIEW): C

CONDITIONAL USE PERMIT QUALIFYING CRITERIA (AS EXHIBITED IN ELEVATION VIEW): C & D

scale: 1/2" = 1'-0"

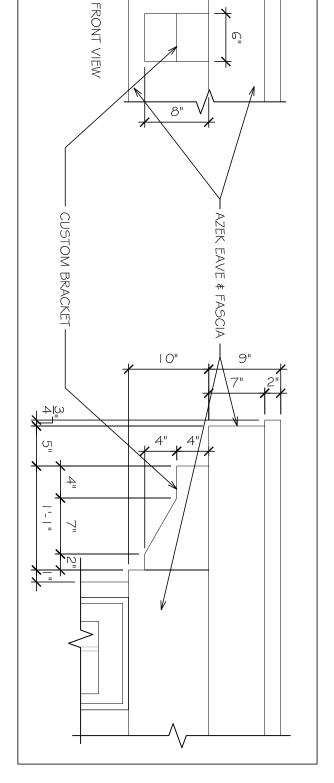

3. EAVE & BRACKET @ APPURTENANCE scale: 1" = 1'-0"


CONDITIONAL USE PERMIT QUALIFYING CRITERIA (AS EXHIBITED IN ELEVATION VIEW): C


46 MAPLEWOOD AVENUE SOMMA Studios 603/766.3760 Am Portsmouth, New Hampshire

Amoskeag Architectural 603/606.7878

SCALE: AS NOTED




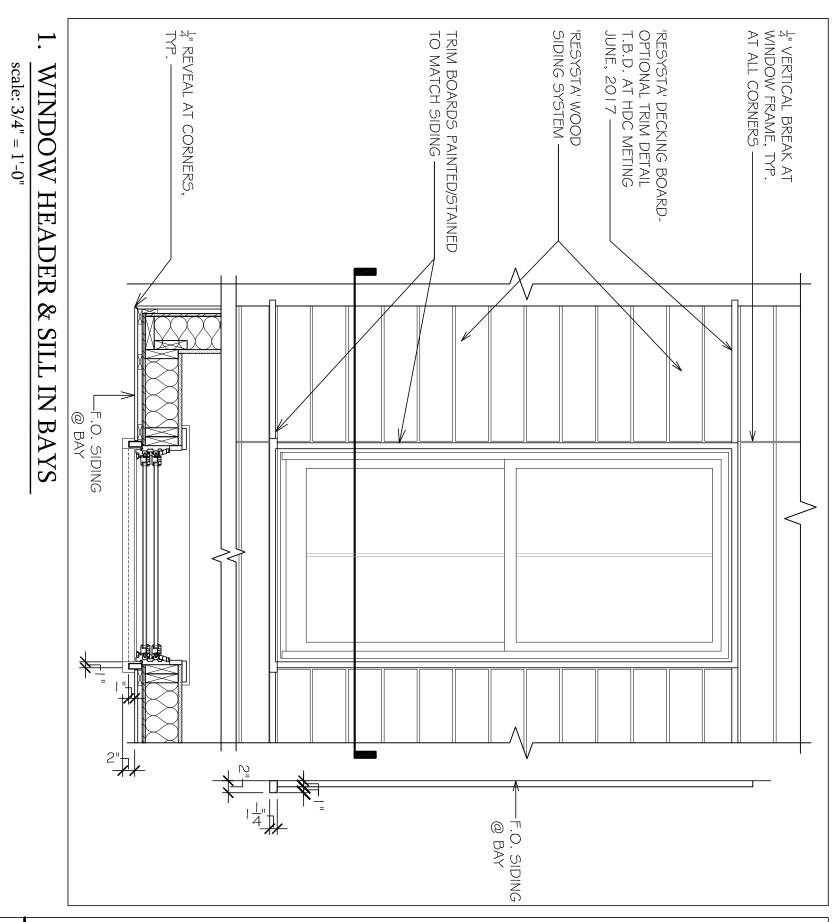

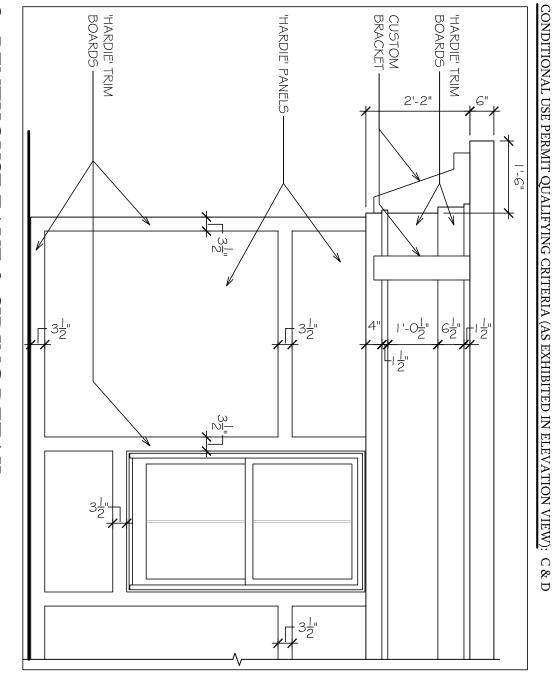

3 PENTHOUSE EAVE & SIDING DETAIL

scale: 1/2" = 1'-0" CONDITIONAL USE PERMIT QUALIFYING CRITERIA (AS EXHIBITED IN ELEVATION VIEW): C

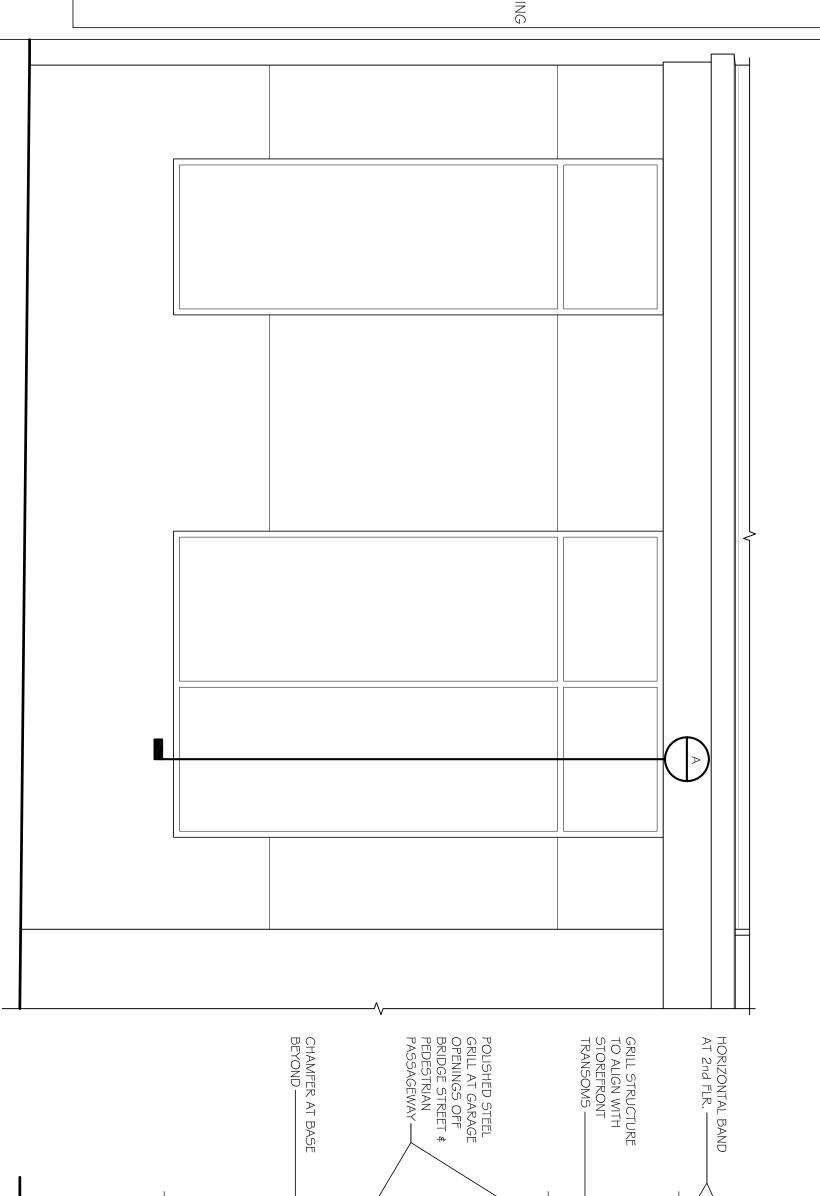


scale: 1/2" = 1'-0" 'GRILL' DETAIL AT GARAGE OPENINGS [shown in elevation]

SECTION 'A'

2

CONDITIONAL USE PERMIT QUALIFYII NG CRITERIA (AS EXHIBITED IN ELEVATION VIEW): C & D

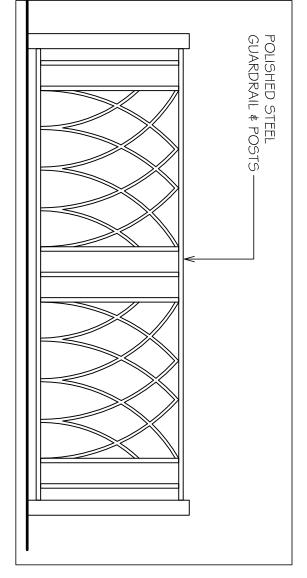

scale: 3/4" = 1'-0" PENTHOUSE GUAR DRAIL DETAIL


CONDITIONAL USE PERMIT QUALIFYING CRITERIA (AS EXHIBITED IN ELEVATION VIEW): C

SOMMA Studios 603/766.3760 46 MAPLEWOOD AVENUE Portsmouth, New Hampshire

Amoskeag Architectural 603/606.7878


SCALE: AS NOTED 6.7.17



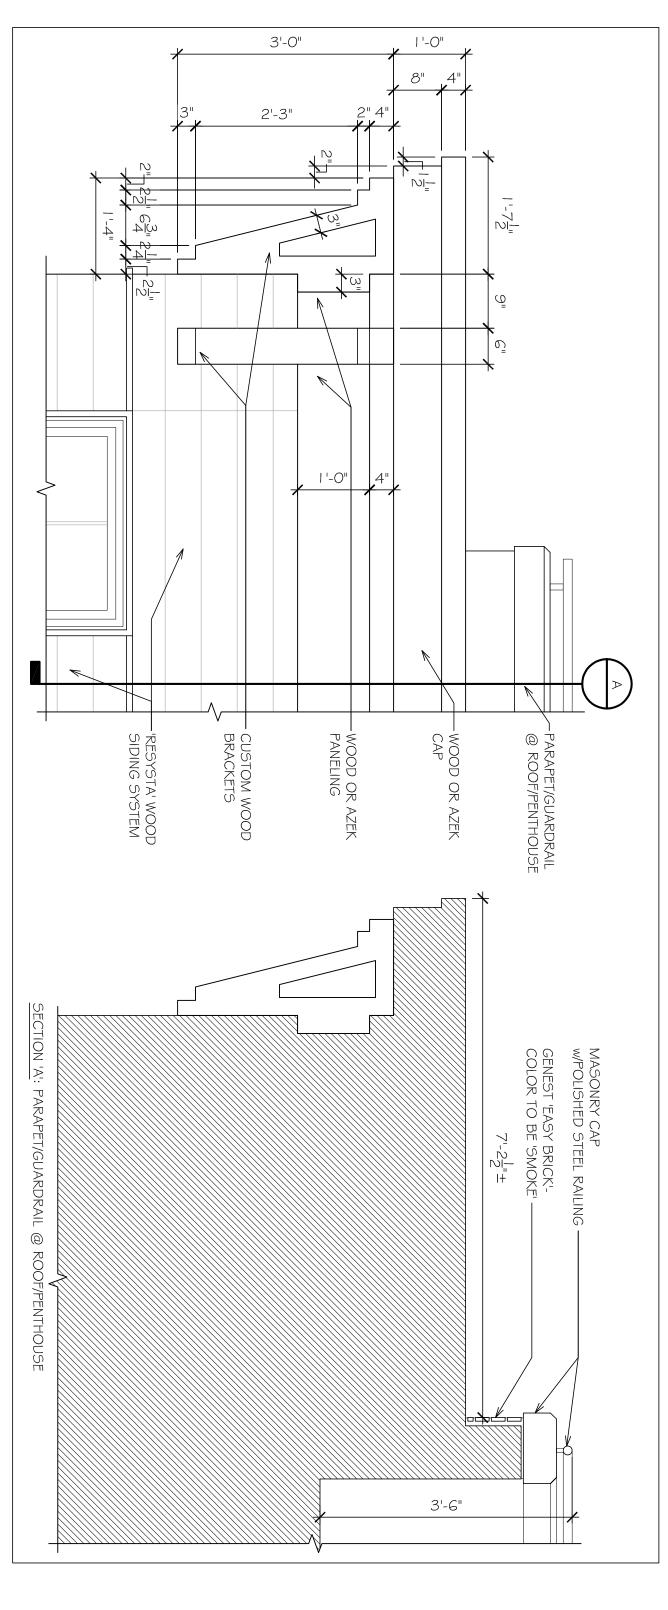

EAVE & BRACKET DETAIL (AT BAY) scale: 3/4" = 1'-0"

CONDITIONAL USE PERMIT QUALIFYING CRITERIA (AS EXHIBITED IN ELEVATION VIEW): C

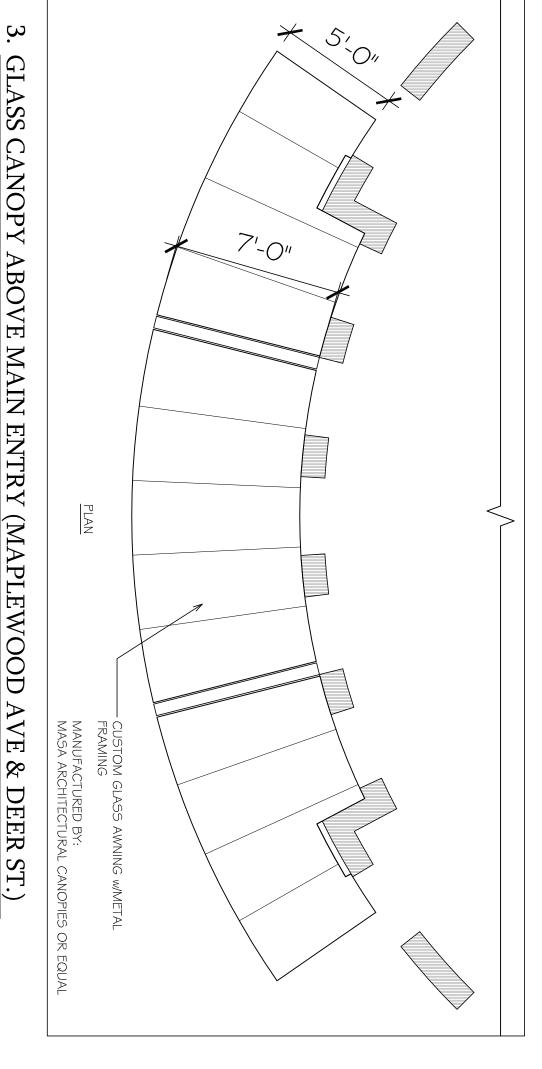


scale: 1/4" = 1'-0" GLASS CANOPY ABOVE MAIN ENTRY (MAPLEWO OD AVE & DEER ST.)

CONDITIONAL USE PERMIT QUALIFYING CRITERIA (AS EXHIBITED IN ELEVATION VIEW): C

46 MAPLEWOOD AVENUE SOMMA Studios 603/766.3760 Am Portsmouth, New Hampshire


Amoskeag Architectural 603/606.7878

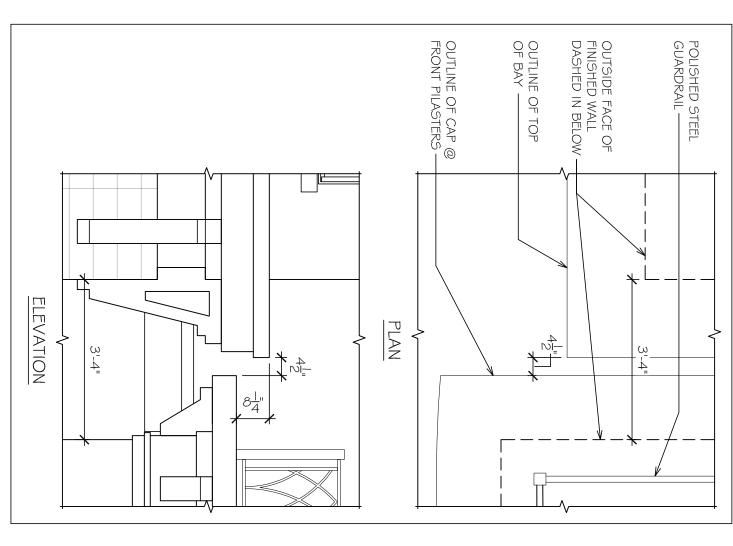


2 scale: 1/2" = 1'-0" EAVE RELATIONSHIP @ RECESS



scale: $\frac{1}{4}$ "= 1'-0"

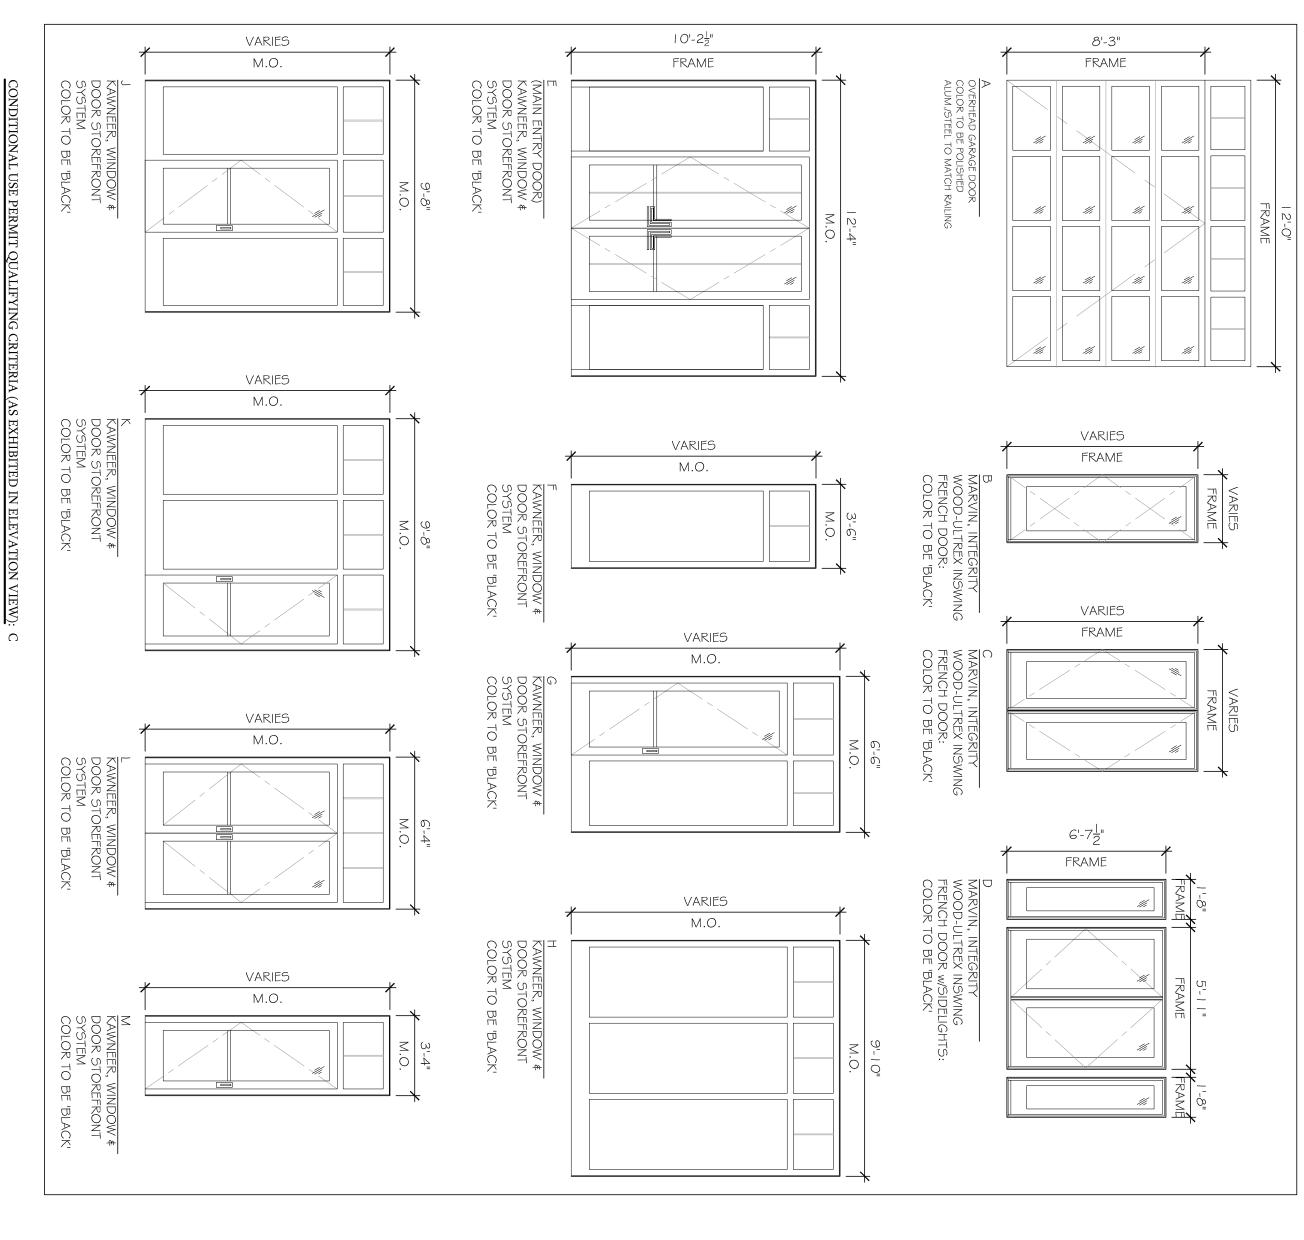

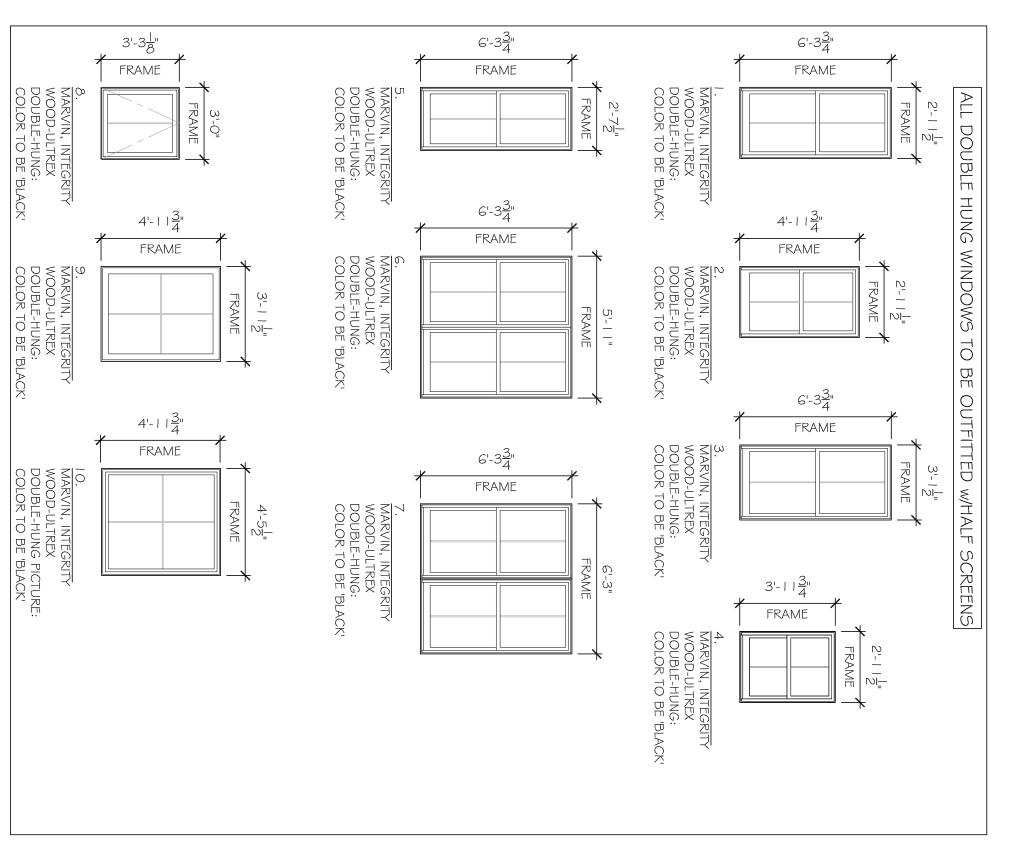

CONDITIONAL USE PERMIT QUALIFYING CRITERIA (AS EXHIBITED IN ELEVATION VIEW): C


46 MAPLEWOOD AVENUE Portsmouth, New Hampshire

SOMMA Studios 603/766.3760 Amoskeag Architectural 603/606.7878

SCALE: AS NOTED

6.7.17 **SH. 7**



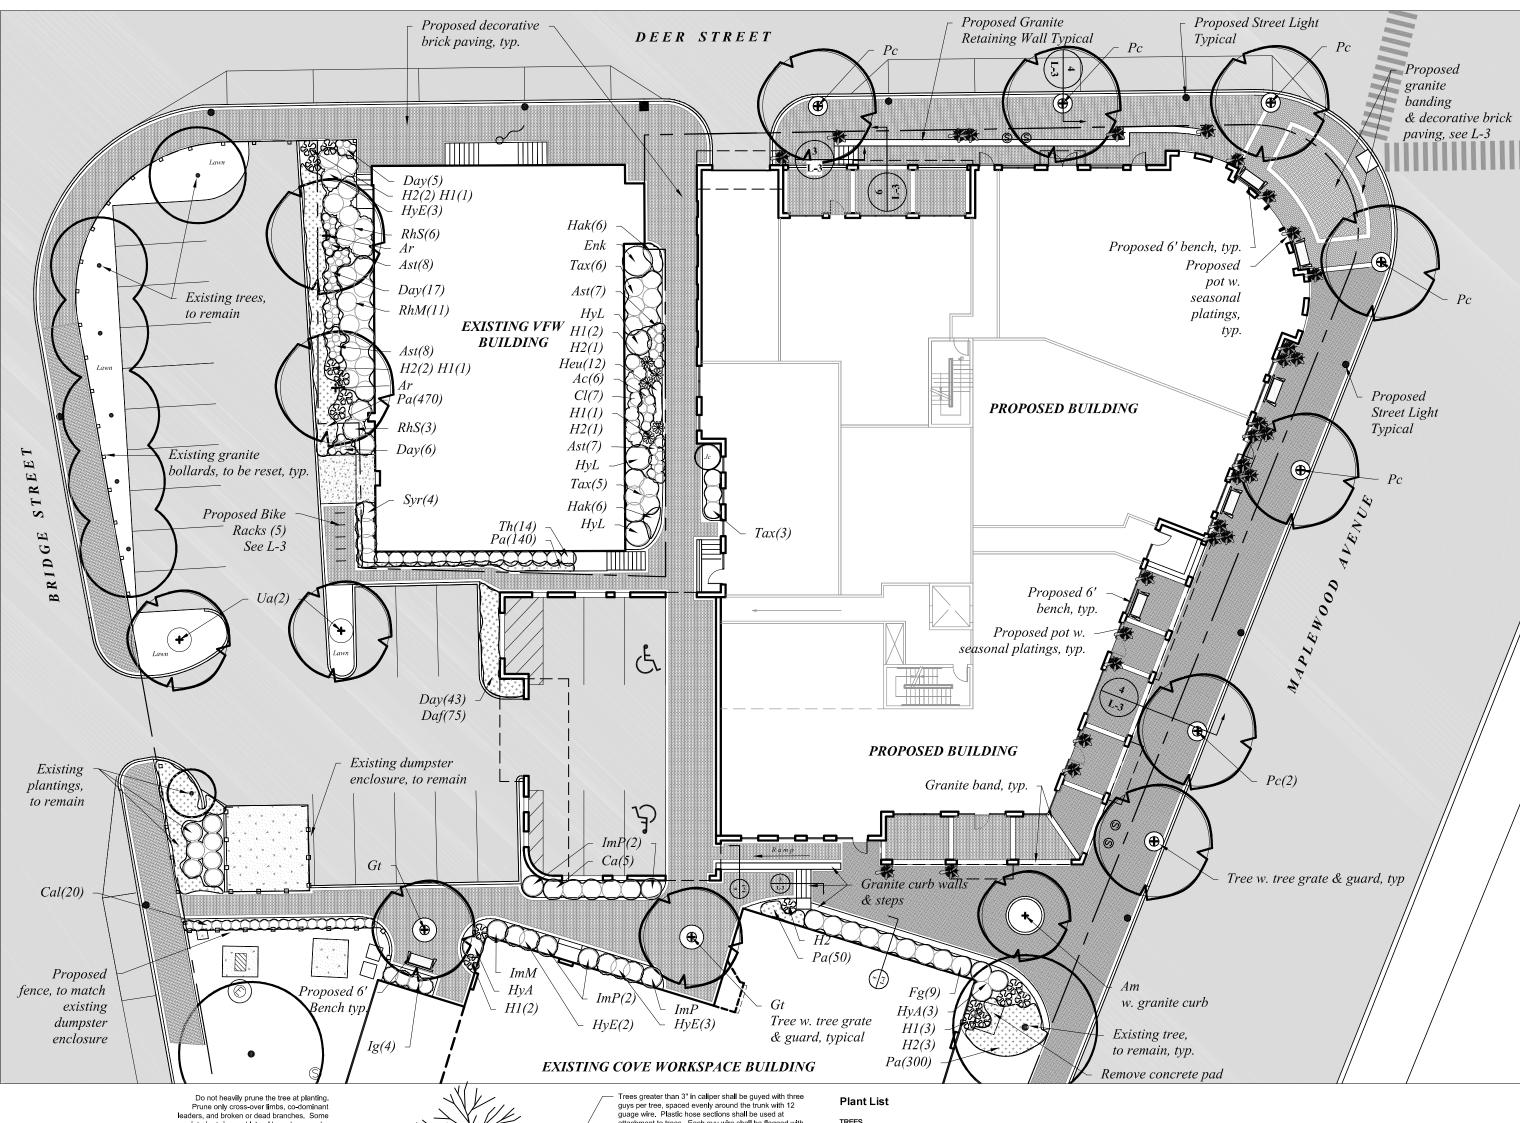

Conditional Use Permit Qualifying Criteria

A. Civic Space-

We are providing permanently accessible, public open space such as widened sidewalks, plazas and pedestrian-only throughways. (This will tally more than 30% of our lot size). We have spoken with the abutting property, (aka VFW) and will be drafting an easement with them to extend landscaping up to their building and make cosmetic improvements to their building to improve the experience between and around these 2 neighboring structures.

B. Parking-


We are providing underground and concealed parking. We are also diminishing and beautifying the remaining surface parking on the adjacent lot.


C. Building Materials-

We are using high quality building materials such as masonry, glass, and metal, high quality windows, storefront systems, and awning assemblies.

D. Building Scale Elements-

Scaling elements, details and massing techniques focusing on the pedestrian experience have been implemented such as stepping the building, horizontal bands, eave bands and decorative building caps, awnings, pilasters and columns as well as varied windows, door sizes and multiple points of entry.

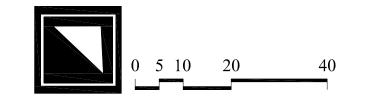

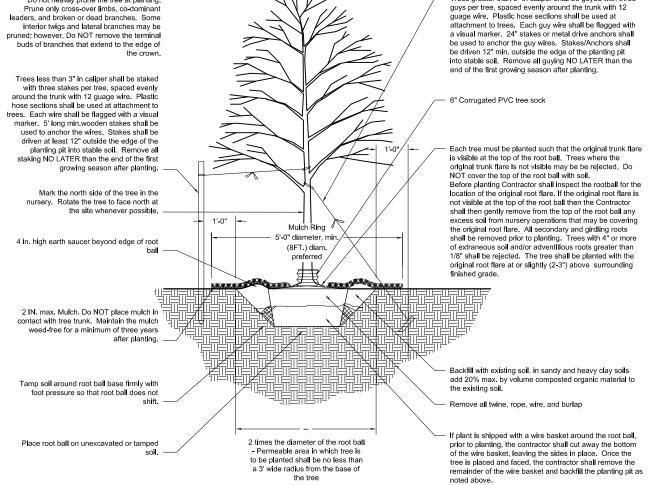


Symbol	Botanical Name	Common Name	Quantity	Size			Comments
Ar	Acer rubrum 'Karpick'	Karpick Red Maple	2	3-3.5" cal			B&B
Am	Amelanchier x grandiflora 'Autumn Brilliance'	Autumn Brilliance Serviceberry	1	12-14' ht		B&B Multi-	Stem Specimen
Gt	Gleditsia triancanthos inermis 'Halka'	Halka Thomless Honeylocust	2	3-3.5" cal			B&B
Pc	Pyrus calleryana 'Aristocrat'	Aristocrat Flowering Pear	7	3-3.5" cal			B&B
Ua	Ulmus americana 'Princeton'	Princeton American Elm	2	3-3.5" cal			B&B
HRUBS							
Symbol	Botanical Name	Common Name	Quantity	Size	min height	min width	Comments
Ca	Comus alba 'Ivory Halo'	Ivory Halo Dogwood	5	5 gal			
Cle	Clethra alnifolia 'Hummingbird'	Hummingbird Summersweet	7	5 gal			
Enk	Enkianthus campanulatus	Redvein Enkianthus	1	4-5' ht			B&B
Fg	Fothergilla gardenii	Dwarf Fothergilla	9	5 gal	2.5'	2.5'	
HyA	Hydrangea arborescens 'Annabelle'	Annabelle Hydrangea	4	5 gal	2.5'	2.5'	
HyE	Hydrangea macrophylla 'Endless Summer'	Endless Summer Hydrangea	8	5 gal	2.5'	2.5'	
HyL	Hydrangea paniculata 'Little Lime'	Little Lime Hydrangea	2	5 gal	2.5'	2.5'	
Íg	Ilex glabra 'Shamrock'	Shamrock Inkberry	4	3 gal	2'	2'	
lmM	Ilex meserve 'Blue Maid'	Blue Maid Holly (female conical)	1	2-2.5' ht		2.5'	B&B
ImP	Ilex meserve 'Blue Princess'	Blue Princess Holly (female)	5	5-6' ht			B&B
Jc	Juniperus chinensis 'Mountbatten	Mountbatten Juniper	1	7-8' ht			B&B
Le	Leucothoe fontanesiana 'Scarletta'	Scarletta Leucothoe	Ó	3 gal	2'	2'	545
RhM	Rhododendron 'Myrtifolium'	Myrtle-leaf Rhododendron	11	2-2.5' ht	-	-	B&B
RhS	Rhododendron 'Scintillation'	Scintillation Rhododendron	9	2-2.5' ht			B&B
Syr	Syringa 'Bloomerang'	Bloomerang Lilac	4	2-2.5' ht			B&B
Tax	Taxus media 'Ever-Low'	Ever-Low Yew	14	18-24" wide	18"	18"	B&B
Th	Thuja occidentalis 'Smaragd'	Emerald Green Arborvitae	14	7-8' ht	10	10	B&B
PERENNI Symbol	ALS, GROUNDCOVERS, VINES and ANNUAL Botanical Name	.S Common Name	Quantity	Size			Comments
Ac	Actaea racemosa	Bugbane	6	1 gal			Comments
Ast	Astilbe 'Fanal'	Fanal Pink Astilbe	30	1 gal			
Cal	Calamagrostis acutifolia 'Karl Foerster'	Feather Reed Grass	20	1 gal			
Dav	Hemerocallis 'Big Time Happy'	Big Time Happy Daylily	9	1 gal			Mix evenly
Day	Hemerocallis 'Barbra Mitchell'	Barbra Mitchell Daylily	9	1 gal			Mix evenly
Day	Hemerocallis 'Gordon Biggs'	Gordon Biggs Daylily	10	1 gal			Mix evenly
Day	Daffodil Mix	Gordon Biggs Daylily	10	ı yaı			with everity
Dai	Narcissus 'Ice follies'	Daffodil	25	4			Missasanis
				top size			Mix evenly
	Narcissus 'King Alfred'	Daffodil	25	top size			Mix evenly
	Narcissus 'Mount Hood'	Daffodil	25	top size			Mix evenly
1.14	Hosta sieboldiana 'Elegans'	Elegans Hosta Frances Williams Hosta	10	1 gal			
H1			9	1 gal			
H2	Hosta 'Frances Williams'						
H2 Hak	Hakonechloa macra 'Aureola'	Golden Japanese Forest Grass	12	1 gal			
H2 Hak Heu	Hakonechloa macra 'Aureola' Heuchera 'Splendens'	Golden Japanese Forest Grass Coral Bells	12 12	1 gal			
H2 Hak	Hakonechloa macra 'Aureola'	Golden Japanese Forest Grass	12				plant 8" o.c

D eW Portsmouth, S B 4 9 Ó VMDrawn By: RW 1'' = 20' - 0''Scale: May 19, 2017 Date: Revisions:

Hampshire

PI

D

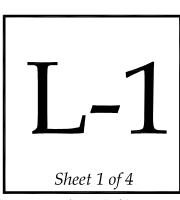



Existing Board Fence to be repeated



Portsmouth Street Light



Bench (9) - DuMor 119, black



Trash Receptacle - DuMor 157



Ironsmith Olympian 60"
Tree Grate




Ironmith M-13 Tree Guard



Campania Sandhurst - 26"




Campania Vallarella

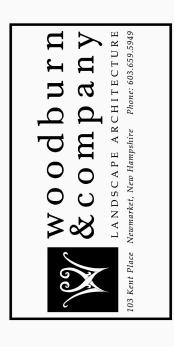


46-64 Maplewood Aven LANDSCAPE ELEMENTS


Drawn By: VM
Checked By: RW
Scale:
Date: May 19, 2017
Revisions:



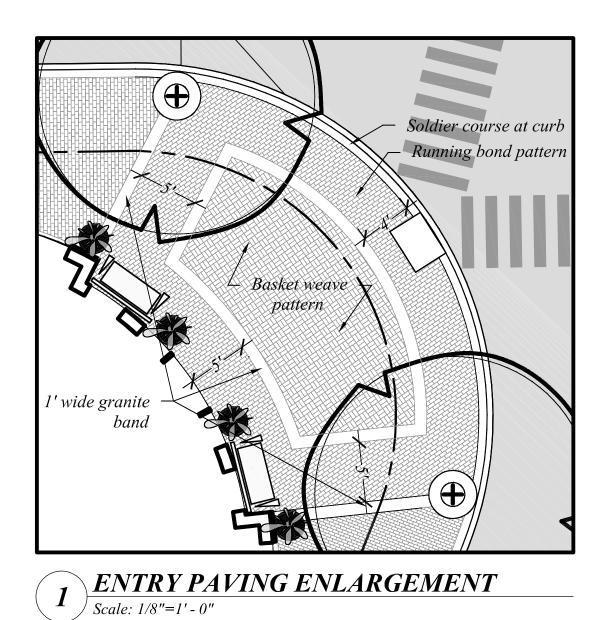

Scale: 1/2"=1' - 0"

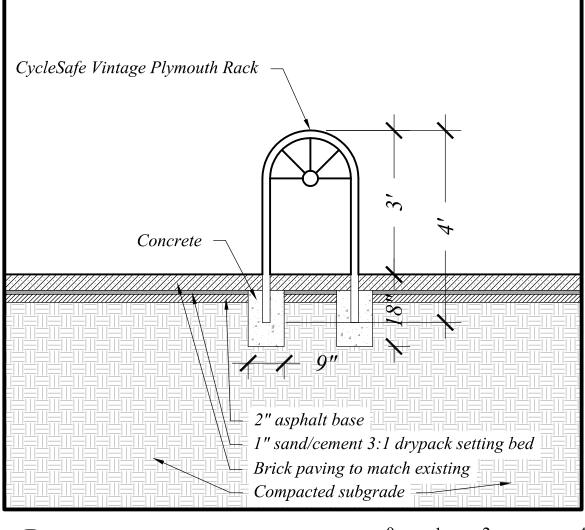


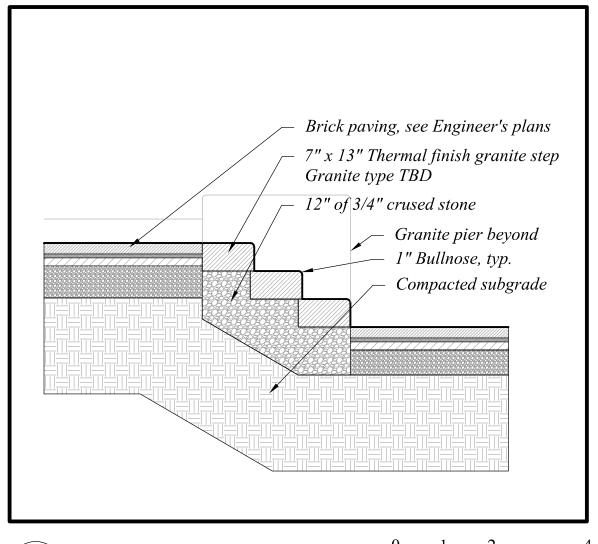

2 BIKE RACK
Scale: 1/2"=1' - 0"

3 GRANITE STEPS
Scale: 1/2"=1' - 0"

0 1 2

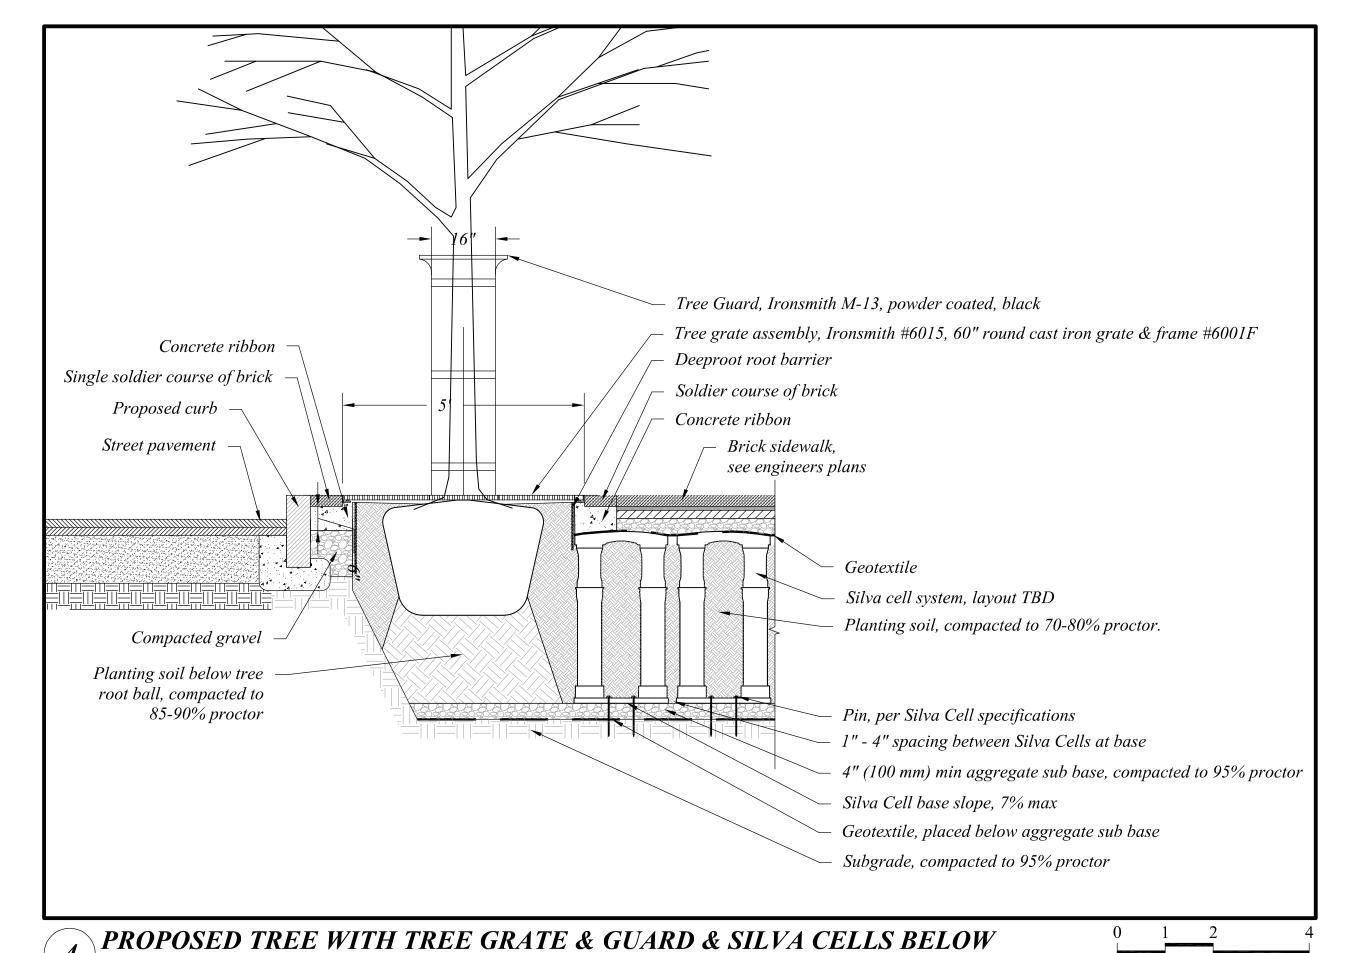

46-64 Maplewood Avenue


LANDSCAPE PLAI
Portsmouth, New Hampshire

7

0


Drawn By: VM
Checked By: RW
Scale: as noted
Date: May 19, 2017
Revisions:

L-3
Sheet 3 of 4

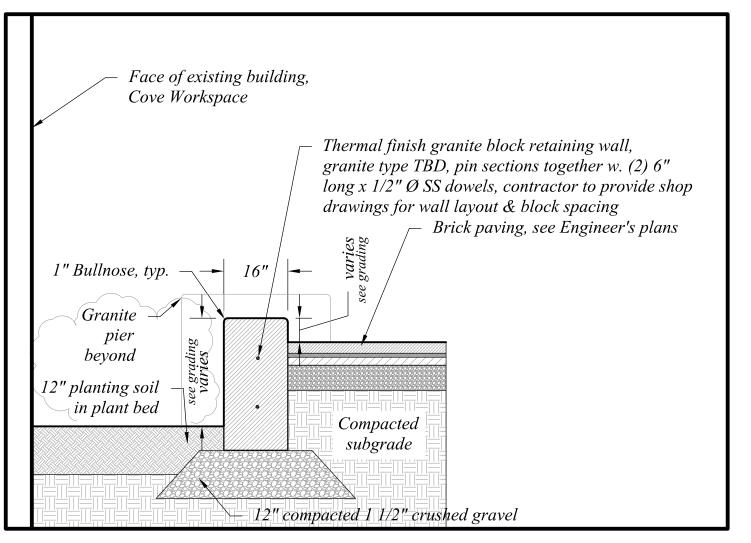

RETAINING WALL AT COVE

Scale: 1/2"=1' - 0"

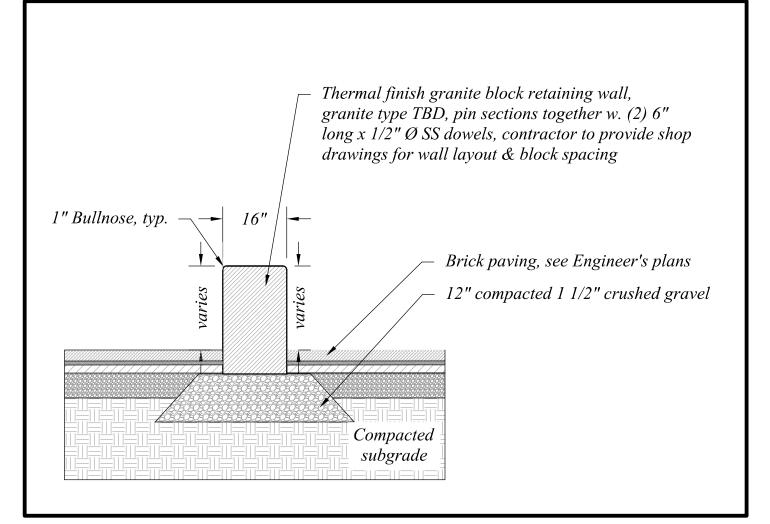

6 RETAINING WALL AT RAMP

Scale: 1/2"=1'-0"

Brick paving, see Engineer's plans
Railing, see Architects plans
Core drill wall to accept railing posts

Thermal finish granite block retaining wall, granite type TBD, pin sections together w. (2) 6" long x 1/2" Ø SS dowels, contractor to provide shop drawings for wall layout & block spacing

1" Bullnose, typ.

Concrete footing, #4 bars 12" o.c. e.w.
Brick paving, see Engineer's plans

Compacted subgrade

Planting soil, see dtl 4/L-3

RETAINING WALL AT DEER STREET

Scale: 1/2"=1' - 0"

L-4
Sheet 4 of 4



ಡ

0

C

0

0

Drawn By: VM
Checked By: RW
Scale: as noted
Date: May 19, 2017
Revisions:

46 Maplewood Conditional Use Permit Request

With a favorable overall design and the Commission's encouragement to emphasize verticality and create importance at the Maplewood-Deer Street corner we are requesting a Conditional Use Permit (CUP).

46 Maplewood Ave is pursuing Section 10.535.13: Increased Building Height by Conditional Use Permit.

• We are asking for relief for 45' in height where 40' is allowable.

We are also seeking an exception from the definition of 'Penthouse', Section 10.5A60, which requires a setback at least 15' from all edges of the roof and a total floor area not exceeding 50% of the area of the story below.

Our 46 Maplewood Penthouse has 0' setback at the Maplewood-Deer Street corner and is 62% of the floor below.

Based on the location of the 46 Maplewood development, our building meets the following 4 criteria as a means of satisfying the terms of the Conditional Use Permit:

A. Civic Space:

We are providing permanently accessible public open space such as widened sidewalks, plazas and pedestrian-only throughways. (This will tally more than 30% of our lot size.) The developer has been in discussion with the abutting property (aka VFW). We will be drafting an easement with them to extend landscaping up to their building. In addition to the easement we will make cosmetic improvements to their building to enhance the experience between and around these 2 neighboring structures.

B. Parking:

We are providing underground and concealed parking. We are also diminishing the remaining surface parking and beautifying the lot in tandem with the adjacent property owner.

C. Building Materials:

We are using high quality building materials such as masonry, composite board, glass, metal, high quality windows, storefront systems, and a custom awning assembly.

D. Building Scale Elements:

Scaling elements, details and massing techniques focusing on the pedestrian experience have been implemented such as stepping the building, horizontal bands, eave bands and decorative building caps, awnings, pilasters and columns as well as varied windows, door sizes and multiple points of entry.

We have noted where these elements are illustrated throughout the presentation using the letters A-D referenced above. We are requesting approval from the Commission at the June work session/public hearing for consistency with the spirit of the Ordinance allowing us to also receive a Certificate of Appropriateness for the 46 Maplewood development.













